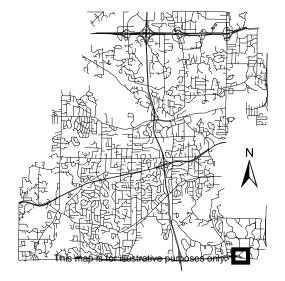




Location Map

Project: Guidepost Montessori Address: 10297 Yellow Circle Drive



4/9/24



City of Minnetonka Planning & Zoning

RE: 10297 Yellow Circle Drive, Minnetonka, MN

Dear Planning & Zoning Commission,

Thank you for taking the time to review this application related to our Conditional Use Permit for a daycare/childcare use for the property located at 10297 Yellow Circle Drive, Minnetonka, MN. As a developer for the daycare operator Guidepost Montessori, we believe this site is a great use for daycare and believe our plan works well within the site. As the City of Minnetonka continues to grow and the major employers nearby do as well, we believe that the city and its constituents would benefit from a high-quality daycare facility nearby a main thoroughfare. Guidepost would be signing a 20-year lease assuming we get approval, showing their commitment to Minnetonka and being a good long-term neighbor.

The site under contract is currently an existing 11,329SF building which we plan to renovate. The building elevations would remain the same aside from signage being added, height (two stories), and lot coverage (~5,686 SF vs a site area of 56,366SF). While there would be traffic with the parents picking up and dropping off, this traffic would be occurring during peak pick up and drop off time periods in the morning and afternoon and would not interfere with the daytime or evening hours. Furthermore, the location would be closed on the weekends, except for an occasional special event, again further lessening the impact on the surrounding neighbors. Therefore, I would ask that the Plan Commission consider approving the action requested.

With 42 parking spaces on site, this is more than enough to handle the pick-up and drop off periods, which are typically from 7-9 am in the morning and from 3-6 in the evening.

Some useful statistics and metrics about the proposed development are as follows:

Site Size – 56,366 SF

Building Size - 11,329 SF

Daycare Operator – Guidepost Montessori

Parking Spaces – 42

Number of Employees – Only 18 on site at one time

Number of Students - 160

Kids per class – Approx 10-20 depending on age (10 per toddler, and 20 per 3-6 child)

Hours of Operation – 7-6

% of students that are half-day vs. full-day – 100% full time

I look forward to having a conversation about the development in the near future and addressing any concerns the Commission may have about the project at that time.


Sincerely,

Ben Udell



227 W Monroe | Suite 5200 | Chicago, IL, 60606 **D**: (312) 625-1382 **C**: (847) 345-2827



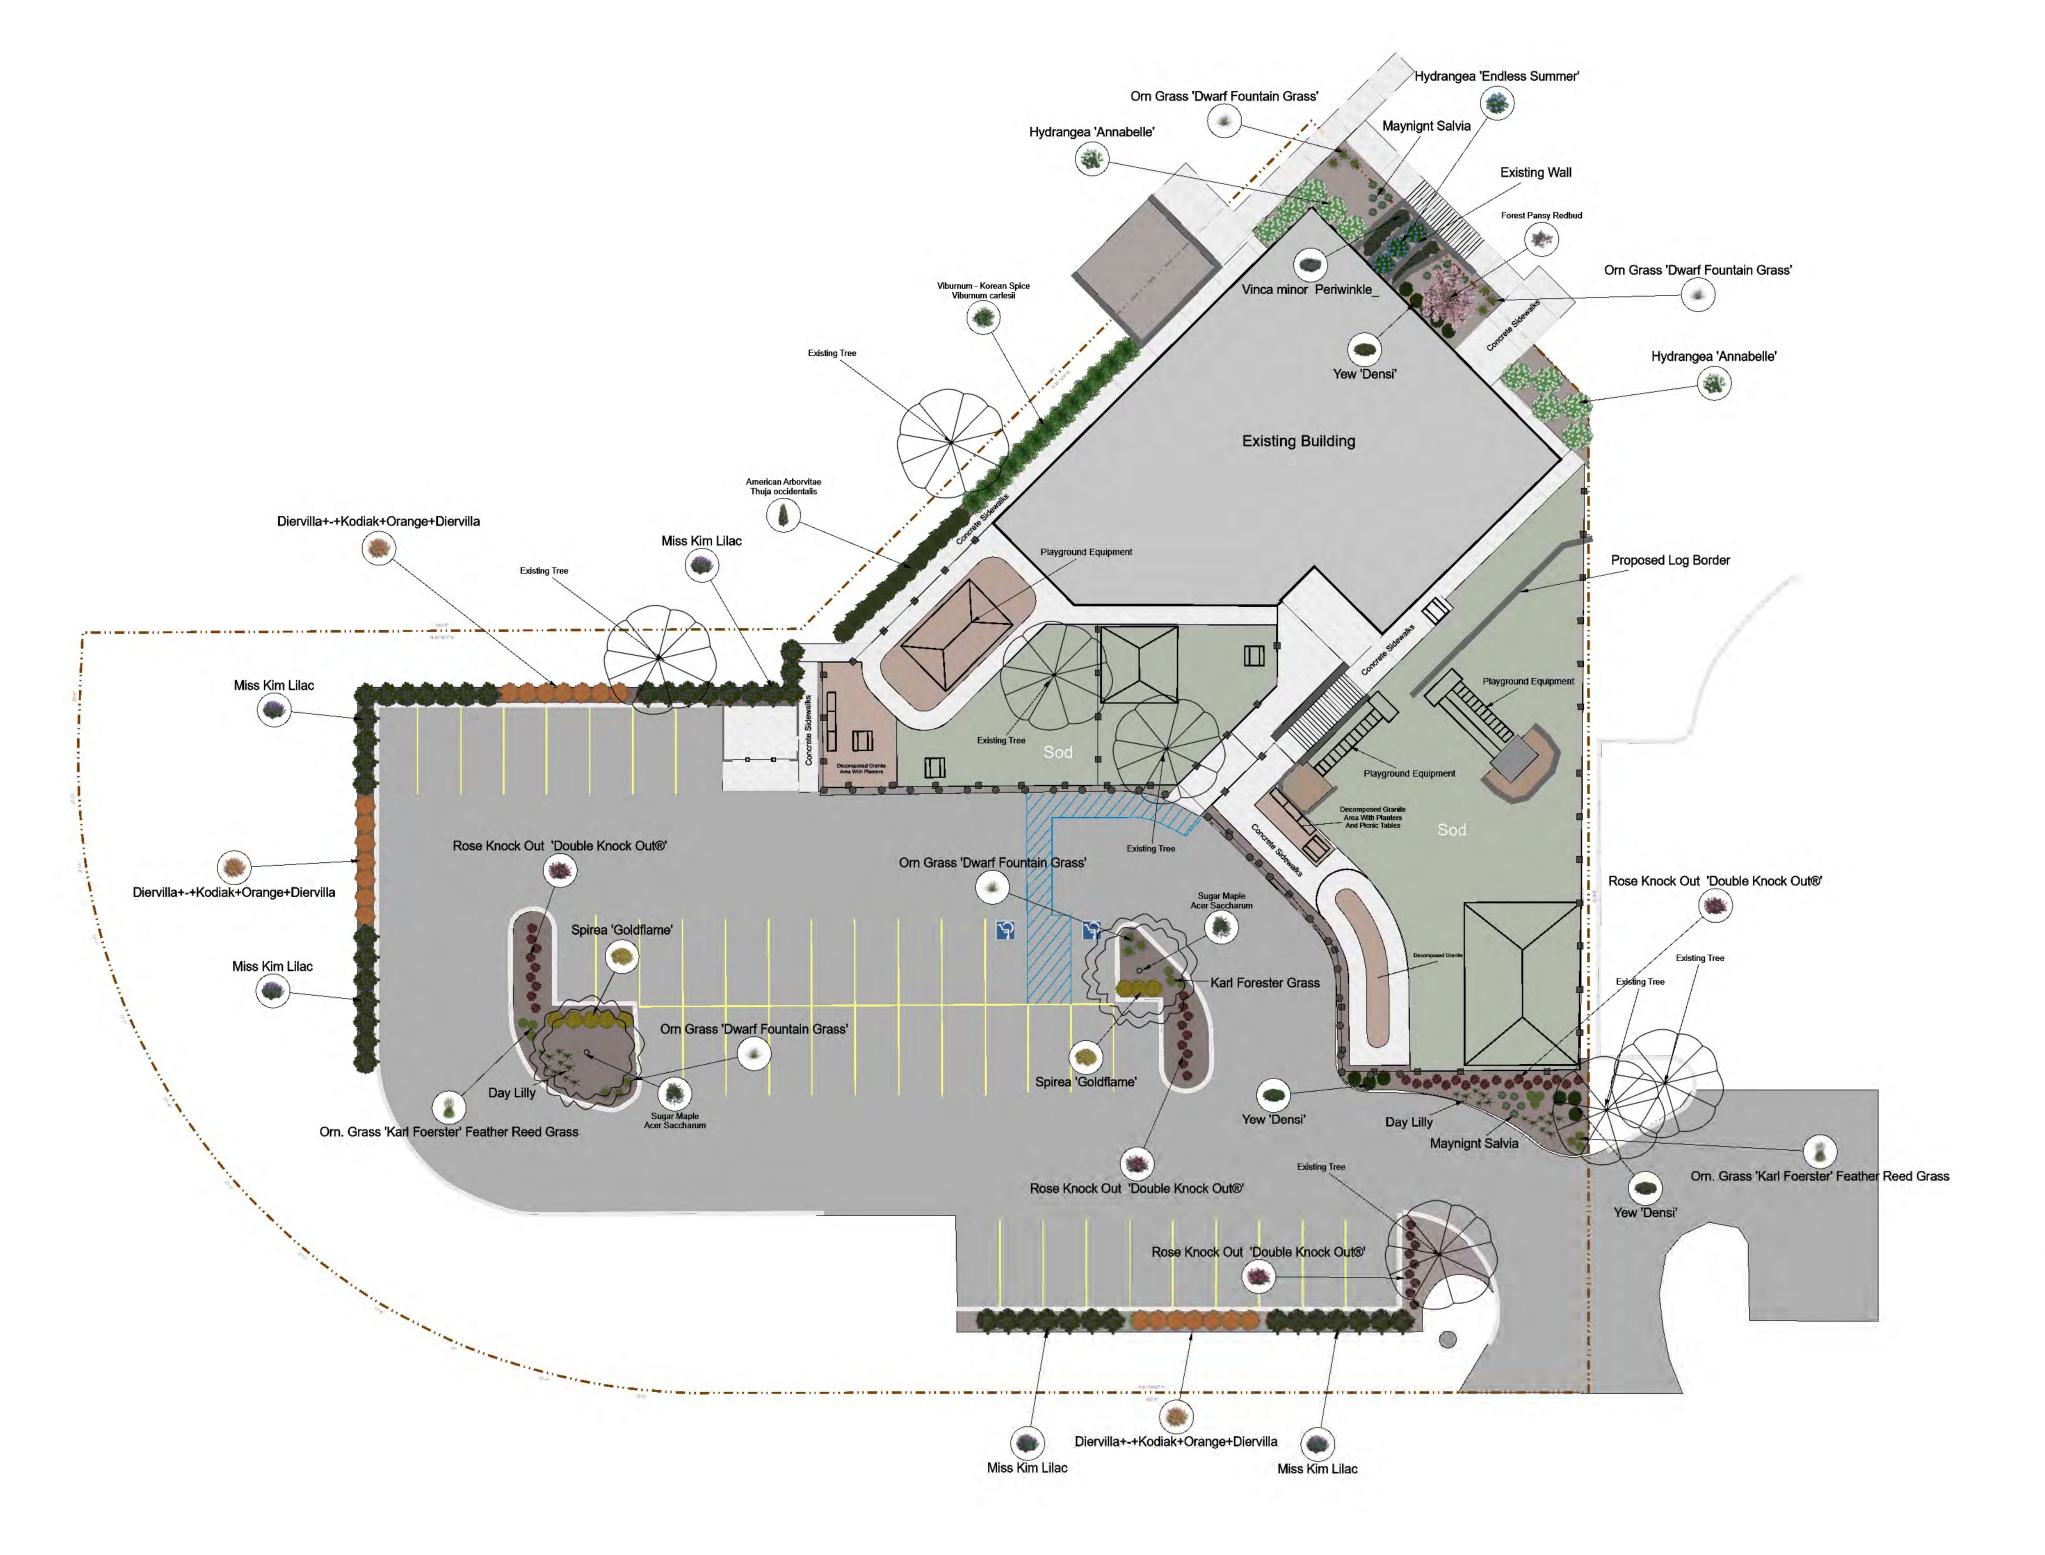

	Key Notes
1	Sod = 6,670 sq/ft
2	Seed and Blanket Disturbed Areas
3	4" depth Shredded Hardwood Mulch = 3,750 sq/ft
4	Decomposed Granite = 1,388 sq/ft

			Plant Schedule	
Symbol	Qty	Size	Common	Botanical
**	12	1 gal.	Day Lilly	
1	7		Existing Tree	Existing Tree
*	1	2"	Forest Pansy Redbud	Cercis canadensis 'Forest Pansy
-	21	5 gal.	Honeysuckle 'Kodiak Orange'	Diervilla x "Kodiak Orange"
*	3	5 gal.	Hydrangea 'Endless Summer'	Hydrangea 'Endless Summer'
*	10	5 gal.	Hydrangea 'Incrediball'	Hydrangea 'Incrediball'
*	16	1 gal.	May Night Salvia	
*	1	1 gal.	May Night Salvia	
	42	5 gal.	Miss Kim Lilac	
*	12	1 gal.	Orn Grass 'Dwarf Fountain Grass'	
	12	1 gal.	Orn. Grass 'Karl Foerster' Feather Reed Grass	
*	45	5 gal.	Rose Knock Out 'Double Knock Out®'	Rosa 'Double Knock Out®'
(1)	8	5 gal.	Spirea 'Goldflame'	
	2	2.5"	Sugar Maple	Acer Saccharum
	12	4'	Techny Arborvitae	Thuja Occidentalis
	13	5 gal.	Viburnum - Korean Spice	Viburnum carlesii
4	7	Flats	Vinca minor Periwinkle	
-	11	5 gal.	Yew 'Densi'	

LANDSCAPING NOTES:

1. LOCATING AND PROTECTING ALL UNDERGROUND UTILITIES, PRIOR TO DIGGING, IS THE RESPONSIBILITY OF THE LANDSCAPE CONTRACTOR.

2. PRIOR TO INSTALLATION, THE LANDSCAPE CONTRACTOR SHALL INSPECT THE SUB GRADE, GENERAL SITE CONDITIONS, VERIFY ELEVATIONS, UTILITY LOCATIONS, IRRIGATION, APPROVE TOPSOIL PROVIDED BY GENERAL CONTRACTOR AND OBSERVE THE SITE CONDITIONS UNDER WHICH THE WORK IS TO BE DONE. NOTIFY GENERAL CONTRACTOR OF ANY UNSATISFACTORY CONDITIONS. WORK SHALL NOT PROCEED UNTIL SUCH CONDITIONS HAVE BEEN CORRECTED AND ARE ACCEPTABLE TO THE LANDSCAPE CONTRACTOR AND/OR CONSTRUCTION MANAGER.

3. GENERAL AND LANDSCAPE CONTRACTOR ARE RESPONSIBLE FOR PROTECTING EXISTING TREES FROM DAMAGE DURING CONSTRUCTION. GENERAL CONTRACTOR TO INSTALL TREE PROTECTION FENCING PRIOR TO ANY SITE WORK.

4. ALL SHRUB AND GROUNDCOVER BEDS TO BE MULCHED WITH A MINIMUM OF 3 INCHES OF CLEAN SHREDDED HARDWOOD MULCH. 5. PLANTING HOLES TO BE DUG A MINIMUM OF TWICE THE WIDTH THE SIZE OF THE

ROOT BALL OF BOTH SHRUB AND TREE. AMEND BACKFILL WITH TOPSOIL MIX. BACKFILL AND TAMP BOTTOM OF THE HOLE PRIOR TO PLANTING SO TOP OF ROOT BALL DOES NOT SETTLE BELOW SURROUNDING GRADE. 6. TOPSOIL MIX TO BE 4 PARTS SCREENED TOPSOIL AND 1 PART ORGANIC MATERIAL.

7. EXISTING GRASS IN THE PROPOSED PLANTING AREAS TO BE REMOVED AND AREA TO BE HAND RAKED TO REMOVE ALL ROCKS AND DEBRIS LARGER THAN 1 INCH IN DIAMETER PRIOR TO PLANTING SHRUBS.

8. SOIL TO BE TESTED TO DETERMINE FERTILIZER AND LIME REQUIREMENTS. LIME AND FERTILIZER TO BE DISTRIBUTED PRIOR TO LAYING SOD. ALL DISTURBED AREAS (INCLUDING RIGHT-OF-WAYS) NOT RECEIVING PLANTINGS TO RECEIVE 4 INCHES OF TOPSOIL AND SODDED.

9. SOD TO BE DELIVERED FRESH (CUT LESS THAN 24 HOURS PRIOR TO ARRIVING ON SITE), LAID IMMEDIATELY, ROLLED AND WATERED THOROUGHLY WITHIN ONE HOUR OF INSTALLATION.

10. ALL CHANGES TO DESIGN AND/OR PLANT SUBSTITUTIONS TO BE AUTHORIZED BY THE LANDSCAPE ARCHITECT.


11. ALL PARKING ISLANDS TO BE BERMED UP 5"-10" WITH CLEAN FRIABLE TOPSOIL


PRIOR TO PLANTING. 12. ALL LANDSCAPING SHALL BE INSTALLED IN CONFORMANCE WITH ANSI Z60.1 THE AMERICAN STANDARD FOR NURSERY STOCK, AND THE ACCEPTED STANDARDS OF


AMERICANHORT. 13. THE LANDSCAPE CONTRACTOR SHALL GUARANTEE ALL PLANTS INSTALLED FOR ONE FULL YEAR FROM THE DATE OF ACCEPTANCE BY THE OWNER. ALL PLANTS SHALL BE ALIVE AND AT A VICOROUS RATE OF GROWTH AT THE END OF THE GUARANTEE PERIOD. THE LANDSCAPE CONTRACTOR SHALL NOT BE

RESPONSIBLE FOR ACTS OF GOD OR VANALISM. 14. ANY PLANT THAT IS DETERMINED DEAD, IN AN UNHEALTHY OR UNSIGHTLY CONDITION. LOST ITS SHAPE DUE TO DEAD BRANCHES OR OTHER SYMPTOMS OF POOR, NON-VIGOROUS GROWTH SHALL BE REPLACED BY THE LANDSCAPE CONTRACTOR WITH THE COST OF THE REPLACEMENT INCLUDED IN THE BID

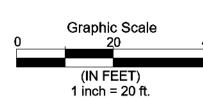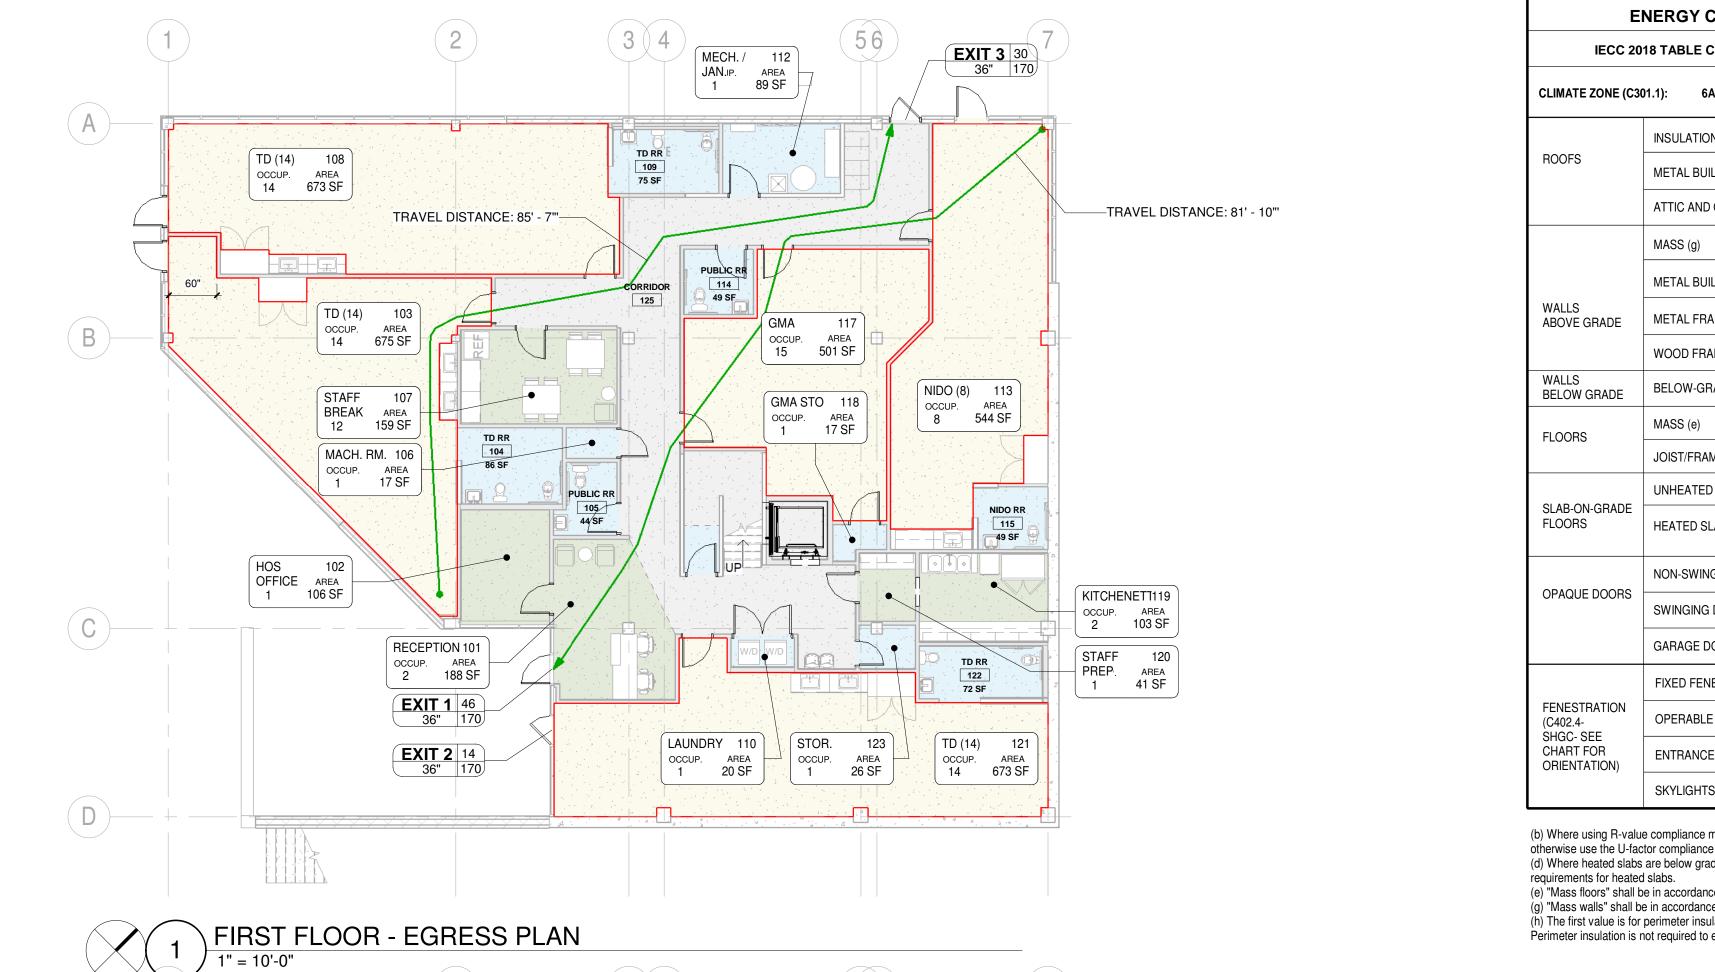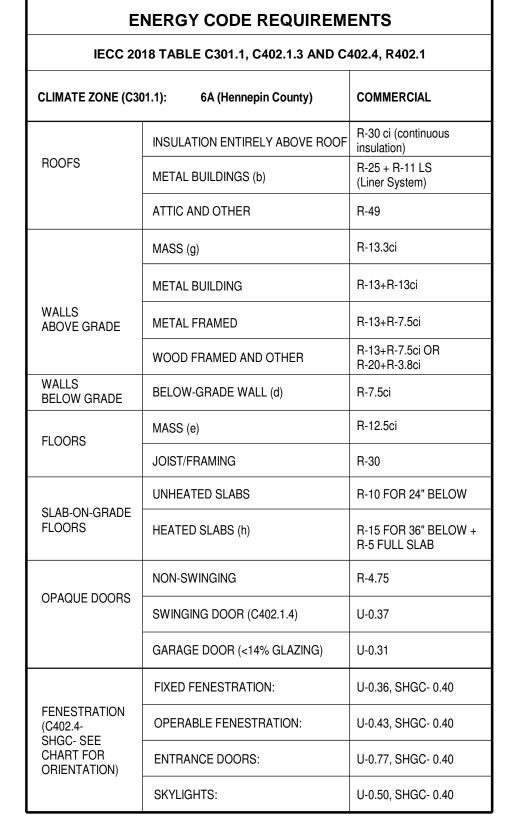PROPOSAL PRICE. 15. WATER THOUGHLY TWICE IN THE FIRST 24 HOURS AND APPLY MULCH IMMEDIATELY.







BU	IILDING INFORMATIO	ON CONTRACTOR OF THE CONTRACTO
1 SUM	2. DEMO EXISTING INTERIOR 3. EXTERIOR WALLS TO REF	
s	5. NEW INTERIOR FINISHES 6. NEW/REVISED HVAC, NEV	
		EPTACLE LOCATIONS, NEW ELEC SERVICE & DISTRIBUTION
AF	PLICABLE CODES **	ALL CODES MAY BE SUBJUECT TO MUNICIPAL AMENDMENTS
202 202 202	MINNESOTA ENERG	
202 202	MINNESOTA MECHA MINNESOTA PLUMB	NICAL & FUEL GAS CODE (2018 IMC & IFGC) ING CODE
202 202) MINNESOTA FIRE CO	
202		TOR & RELATED DEVICES CODE RICAL CODE (2020 NEC)
GE	NERAL BUILDING IN	FORMATION
ZON	IING CLASSIFICATION:	I-1 (INDUSTRIAL DISTRICT) CONDITIONAL USE AS DAYCARE
	sh enclosures or accessory building line of the principal building.	LIMITED HEIGHT 35' is not to exceed 600 square feet in size shall be located behind the front
	PPOSED OCCUPANCY:	FIRST FLOOR: I-4 (DAYCARE)
TYF	E OF CONSTRUCTION: E PROTECTION:	SECOND FLOOR: E (EDUCTION) 2B, UNPROTECTED SPRINKLERED
	ANALYSIS: (APPROXIMATIONS	
	1. FIRST FLOOR: 2. SECOND FLOOR: TOTAL AREA:	5,440 SF (INTERIOR REMODEL ONLY) 5,440 SF (INTERIOR REMODEL ONLY) 10.880 SF
ALL		ER FLOOR (I-4),
ALL	OWABLE HEIGHT: 3 STORIES;	75' MAX HEIGHT
NO NO	E: INTERIOR CONSTRUCTION (JNLY, NO CHANGE IN AREA
ME	EANS OF EGRESS (C	H. 10)
NUN	ND END LIMIT (1020.4): MBER OF EXITS REQUIRED (1006 RRIDOR WIDTH (1020.2):	20' (GROUP I-4); 50' (GROUP E W/ SPRINKLER) 3.3.2): 2 PER FLOOR 44" MINIMUM (GROUP I-4); 72" (GROUP E SERVING>100)
CLE	AR EXIT WIDTH (1022.2): IR WIDTH (1011.2):	32" (36" NOMINAL) 44" MINIMUM / 36" MIN. IF SERVING <50

GROUP I-4 200' W/ SPRINKLER GROUP E 250' W/ SPRINKLER FIRE RESISTANCE RATING REQUIREMENTS (TABLE 601) 0-HR SUPPORTING ROOF ONLY BEARING WALLS ROOF: BEARING WALLS EXTERIOR INTERIOR NON-BEARING WALLS: 0 HRS EXTERIOR: 0 HRS INTERIOR 0 HRS ROOF CONSTRUCTION: 0 HRS COORIDOR (1020.1): FIRE RESISTANCE OF THE EXTERIOR WALL AND OPENINGS PER TABLE 602 AND 705.8: IF STRUCTURE IS OVER 30 FT AWAY FROM THE FACE OF THE IF DISTANCE FROM FAÇADE TO ADJACENT PROPERTY LINE IS BETWEEN 10' AND 30' NO LIMIT IF THE BUILDING IS GREATER THAN 20' - 25' AWAY

.3" PER OCCUPANT

.2" PER OCCUPANT

44" MINIMUM / 36" MIN. IF SERVING <50

34" - 38"

50 OR MORE

42" MIN.

FLAME SPREAD PER CHAPTER 8 (TABLE 803.13): ALL NEW INTERIOR FINISHES SHALL COMPLY WITH CHAPTER 8 IBC: EXIT ENCLS. CORRIDORS ROOMS & ENC. SPACES GROUP I-4: GROUP E: ASTM E84 / FLAME SPREAD (FS) AND SMOKE DEVELOPMENT (SD) INDEX: FLAME SPREAD SMOKE DEVELOPED FRS: 0-25 FOS: 26-75 0-450 FOS: 76-200 0-450

ADA REQUIREME	NTS
SEE SHEET G1-2	AREA OF REFUGE

-LOCATIONS AT STAIRS AS SHOWN -COMMUNICATION DEVICES NOT REQUIRED IF SPRINKLED BUILDING **DESIGN LOADS**

PLUMBING	CODE REQUIREMENTS
DESIGN LUADS: 5	EE STRUCTURAL DRAWING

FIRSR FLOOR - GROUP I-4 CHILD DAYCARE: TOTAL OCCUPANTS = 72 (50 STUDENTS + 16 STAFFS) WATER CLOSET (1 PER 15): LAVATORY (1 PER 15):

14 TODDLERS (24-36 MO.)

20 CHILDREN (3-6 YRS.)

800 SF;F 30 CHILDREN (3-6 YRS.)

1,140 SF 20 CHILDREN (3-6 YRS.)

1,140 SF 30 CHILDREN (3-6 YRS.)

SECOND FLOOR - GROUP E EDUCATIONNAL: TOTAL OCCUPANTS = 126 (110 STUDENTS + 16 STAFFS)

WATER CLOSET (1 PER 50): LAVATORY (1 PER 50): DRINKING FOUNTAIN (1 PER 100): 2 (SHARED) OTHER (1 SERVICE SINK): 1 (SHARED) POST BID/PERMIT REVISIONS: No. Date Description PROJECT NO. DRAWN BY CHECKED BY CODE STUDY

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ENGINEERS

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G

HIGHE

Schematic Design:

ISSUE DATE:

Design Development

DR,

02/19/24




SD 2-23-24 (NFC)

<u>PROVIDED</u>

2 (SHARED)

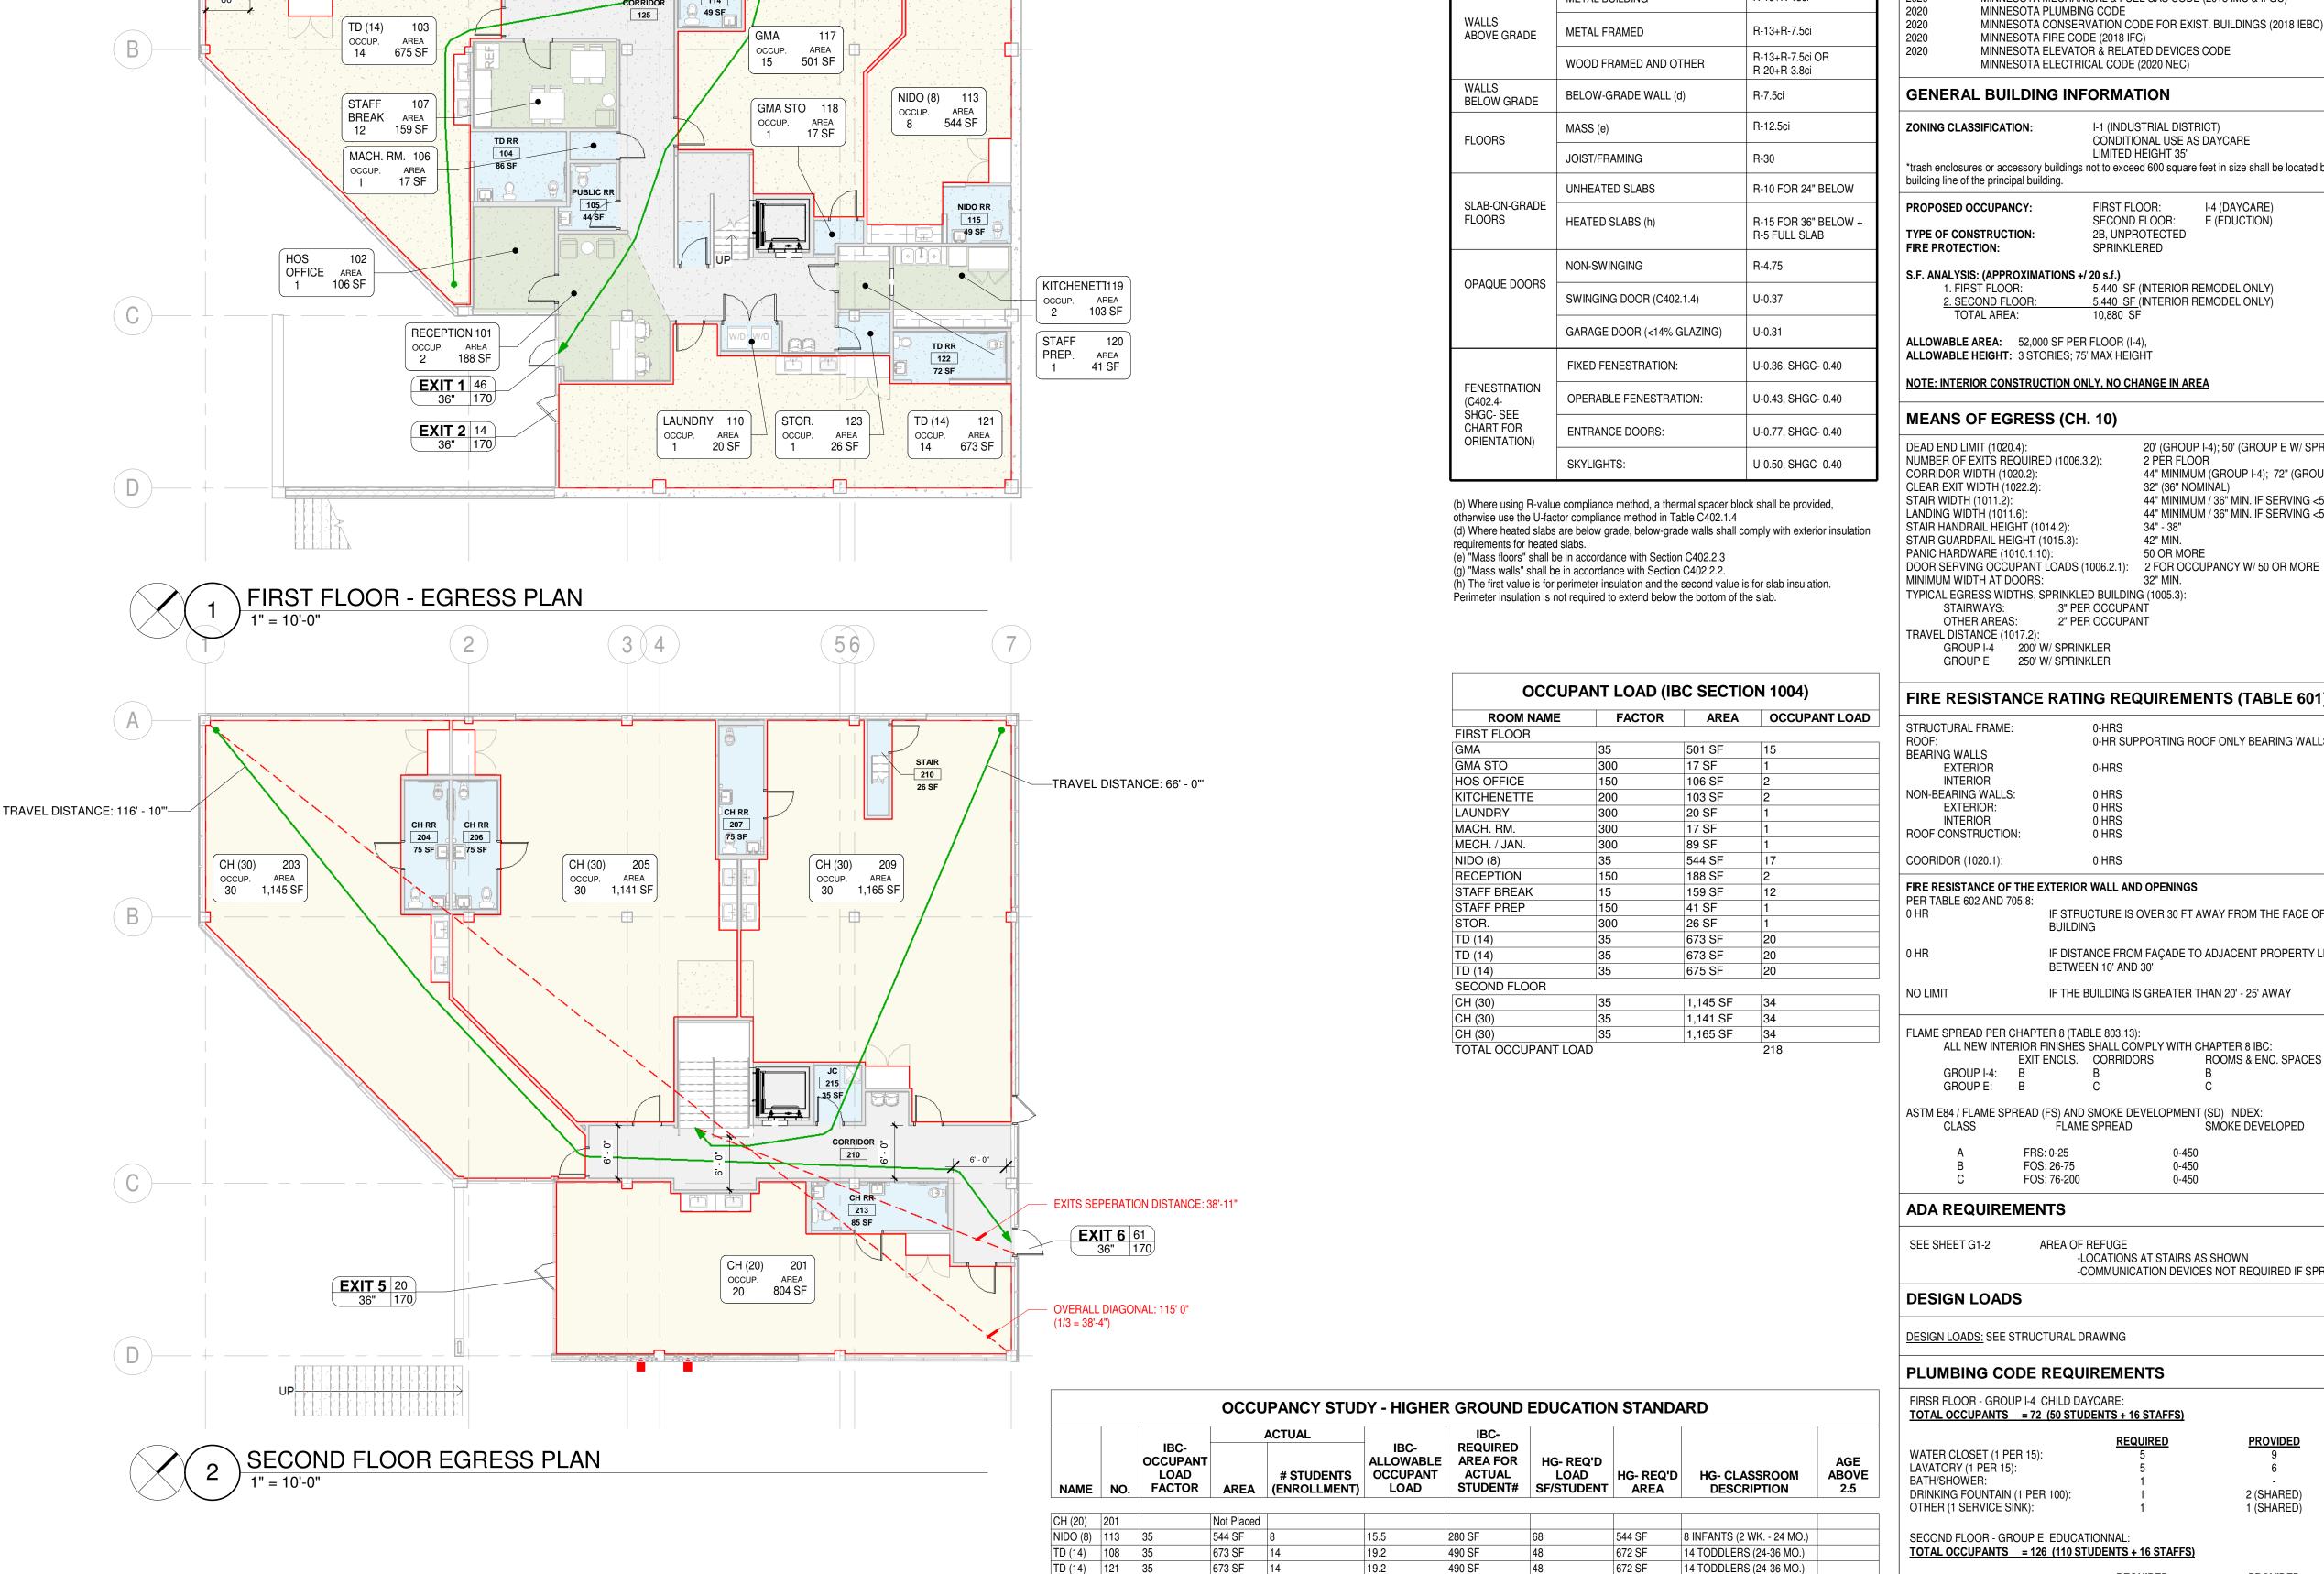ALLEN+PEPA COPYRIGHT 2/23/2024 2:21:03 PM



675 SF

1,145 SF

1,141 SF 3

1,165 SF 30

6,821 SF 160

CH (30) 205

490 SF

700 SF

1,050 SF

1,050 SF

1,050 SF

DEMOLITION GENERAL NOTES

- THE GENERAL CONTRACTOR SHALL VISUALLY INSPECT ALL EXISTING CONDITIONS AND SHALL COORDINATE ANY OUTSTANDING DEMO ISSUES WITH THE ARCHITECT PRIOR TO BEGINNING WORK. ALL BASE BUILDING FRAMES, WINDOW SILLS, AND CORE PARTITIONS TO BE FREE FROM MASTIC OR OTHER BUILDING RESIDUE AND READY TO RECEIVE FINISH.

 PROVIDE PROTECTION OF ALL EXISTING FINISHES TO REMAIN.
- MAINTAIN AND PROTECT EXISTING UTILITIES TO REMAIN IN SERVICE BEFORE PROCEEDING WITH DEMOLITION, PROVIDING BYPASS CONNECTIONS TO OTHER PARTS OF THE BUILDING.
- WITH DEMOLITION, PROVIDING BYPASS CONNECTIONS TO OTHER PARTS OF THE BUILDING.

 LOCATE, IDENTIFY, SHUT OFF, DISCONNECT, AND CAP OFF UTILITY SERVICES TO BE DEMOLISHED.
- CONDUCT DEMOLITION OPERATIONS AND REMOVE DEBRIS TO PREVENT INJURY TO PEOPLE AND DAMAGE TO ADJACENT BUILDINGS AND SITE IMPROVEMENTS.
 PROVIDE AND MAINTAIN SHORING, BRACING, OR STRUCTURAL SUPPORT TO PRESERVE
- BUILDING STABILITY AND PREVENT MOVEMENT, SETTLEMENT, OR COLLAPSE.


 7. PROTECT BUILDING STRUCTURE AND INTERIOR FROM WEATHER AND WATER LEAKAGE AND DAMAGE.


 8. PROTECT WALLS, CEILINGS, FLOORS, AND EXPOSED FINISHES THAT ARE TO REMAIN. ERECT
- AND MAINTAIN DUSTPROOF PARTITIONS BETWEEN AREA OF WORK AND NON-WORK AREAS INCLUDING DUCTS & AREA ABOVE CEILING. COVER AND PROTECT FIXTURES, FURNISHINGS, AND EQUIPMENT THAT ARE TO REMAIN.

 9. NEATLY CUT OPENINGS AND HOLES PLUMB, SQUARE, AND TRUE TO DIMENSIONS REQUIRED.
- NEATLY CUT OPENINGS AND HOLES PLUMB, SQUARE, AND TRUE TO DIMENSIONS REQUIRED.
 USE CUTTING METHODS LEAST LIKELY TO DAMAGE CONSTRUCTION TO REMAIN OR
 ADJOINING CONSTRUCTION.
 PROMPTLY PATCH AND REPAIR HOLES AND DAMAGED SURFACES OF BUILDING CAUSED BY
- DEMOLITION. RESTORE EXPOSED FINISHES OF PATCHED AREAS AND EXTEND FINISH
 RESTORATION INTO REMAINING ADJOINING CONSTRUCTION.
- 11. PROMPTLY REMOVE DEMOLISHED MATERIALS FROM OWNER'S PROPERTY AND LEGALLY DISPOSE OF THEM. DO NOT BURN DEMOLISHED MATERIALS.
- 12. TO THE BEST OF THE OWNER'S AND ARCHITECT'S KNOWLEDGE, THERE ARE NO HAZARDOUS MATERIALS PRESENT IN THE EXISTING AREA OF WORK. IF MATERIAL IS FOUND WHICH MAY BE SUSPECTED TO BE HAZARDOUS, CONTRACTOR SHALL NOTIFY ARCHITECT AND BUILDING OWNER IMMEDIATELY. IF IT IS DETERMINED TO BE HAZARDOUS, THE MATERIAL SHALL BE FULLY ABATED ACCORDING TO APPLICABLE LAWS.
- PROVIDE DUMPSTER FOR DEBRIS REMOVAL. COORDINATE LOCATION WITH BUILDING OWNER. REMOVE DEMOLITION MATERIALS EACH DAY AND VACUUM PUBLIC/COMMON AREAS BEFORE LEAVING SITE.

	01 - Keynotes - DEMO PLAN	
NOTE	DESCRIPTION	Schedule Type
1	DEMO WALL AS SHOWN	DEMO
2	DEMO DOOR OR OPENING AS SHOWN	DEMO
3	DEMO CABINETS, COUNTERS, PARTITIONS, & PLUMBING AS SHOWN	DEMO
4	DEMO PORTION OF WALL FOR NEW DOOR OR OPENING	DEMO
5	DEMO WALKWAY AREA AS SHOWN	DEMO
6	DEMO EXIST. CONDENSER	DEMO
7	EXIST. GENERATOR TO REMAIN	DEMO
8	<varies></varies>	DEMO
9	DEMO EXIST. FURNACES AS SHOWN	DEMO
10	DEMO EXIST. WATER HEATER	DEMO
11	DEMO EXIST. WATER SERVICE	DEMO

	NEW WALL
	EXISTING WALL TO REMAIN
	DEMO WALL
	RATED WALL
	INSULATED WALL
XXXX	CMU WALL
	CONCRETE WALL

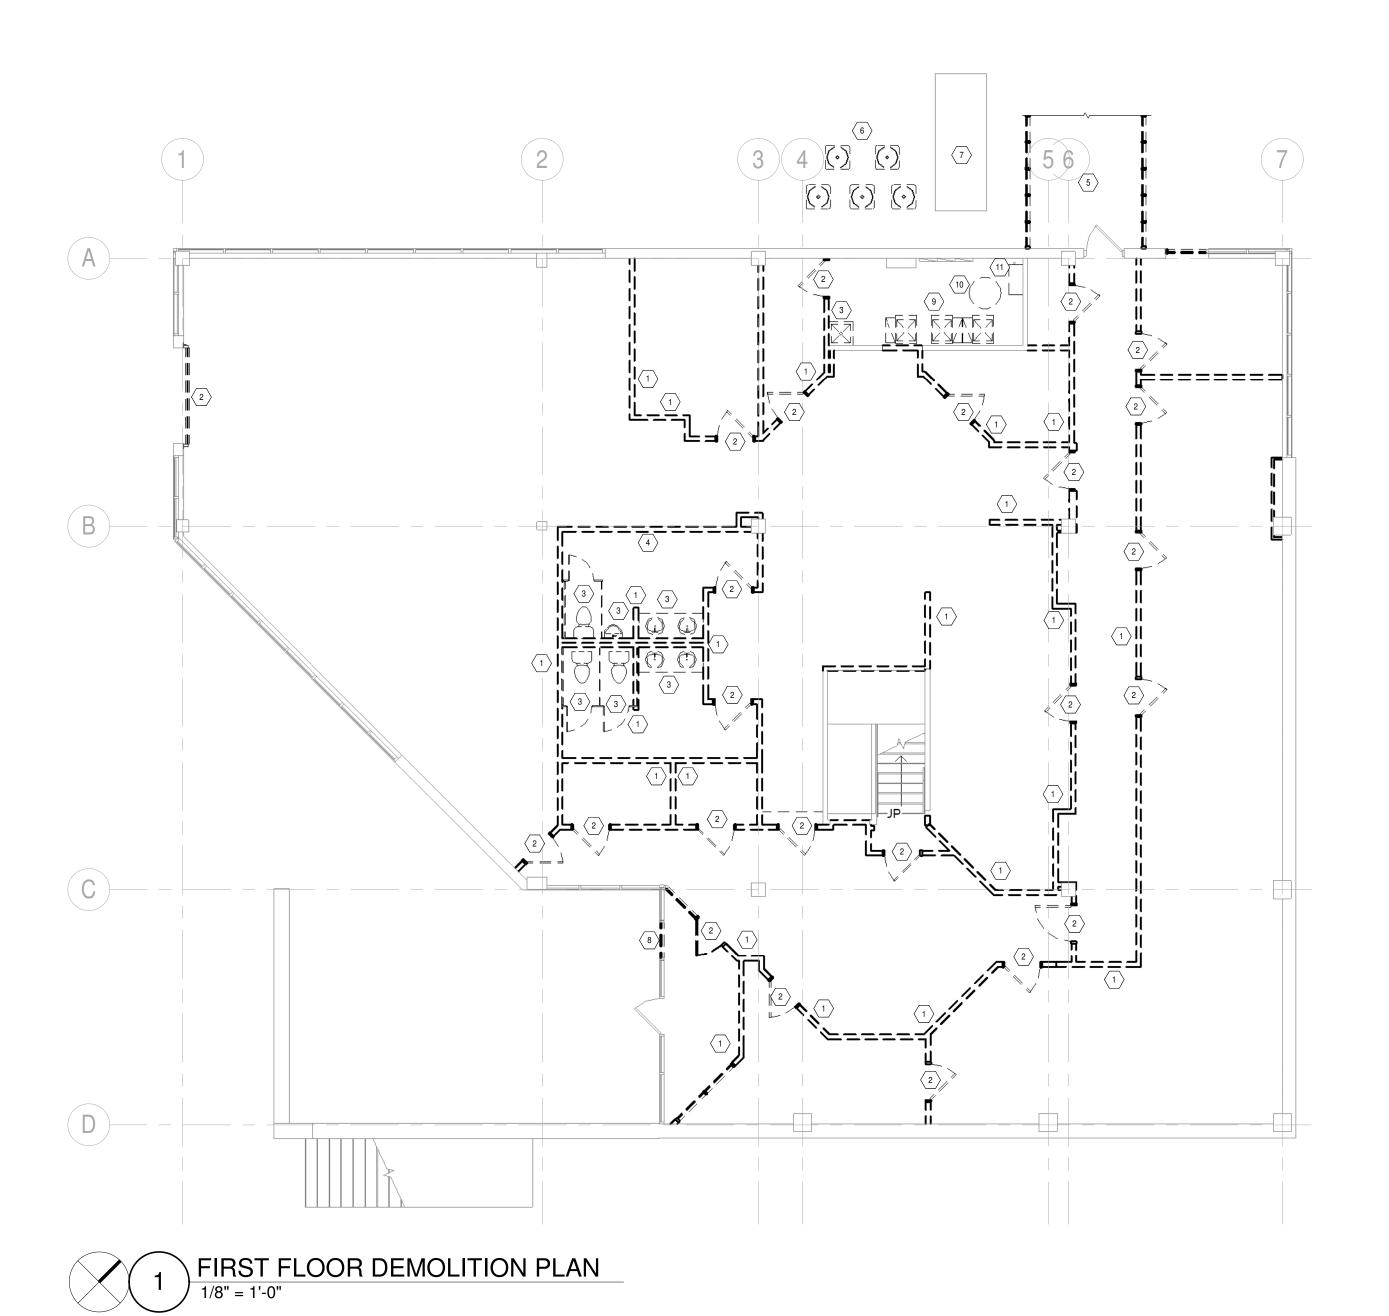

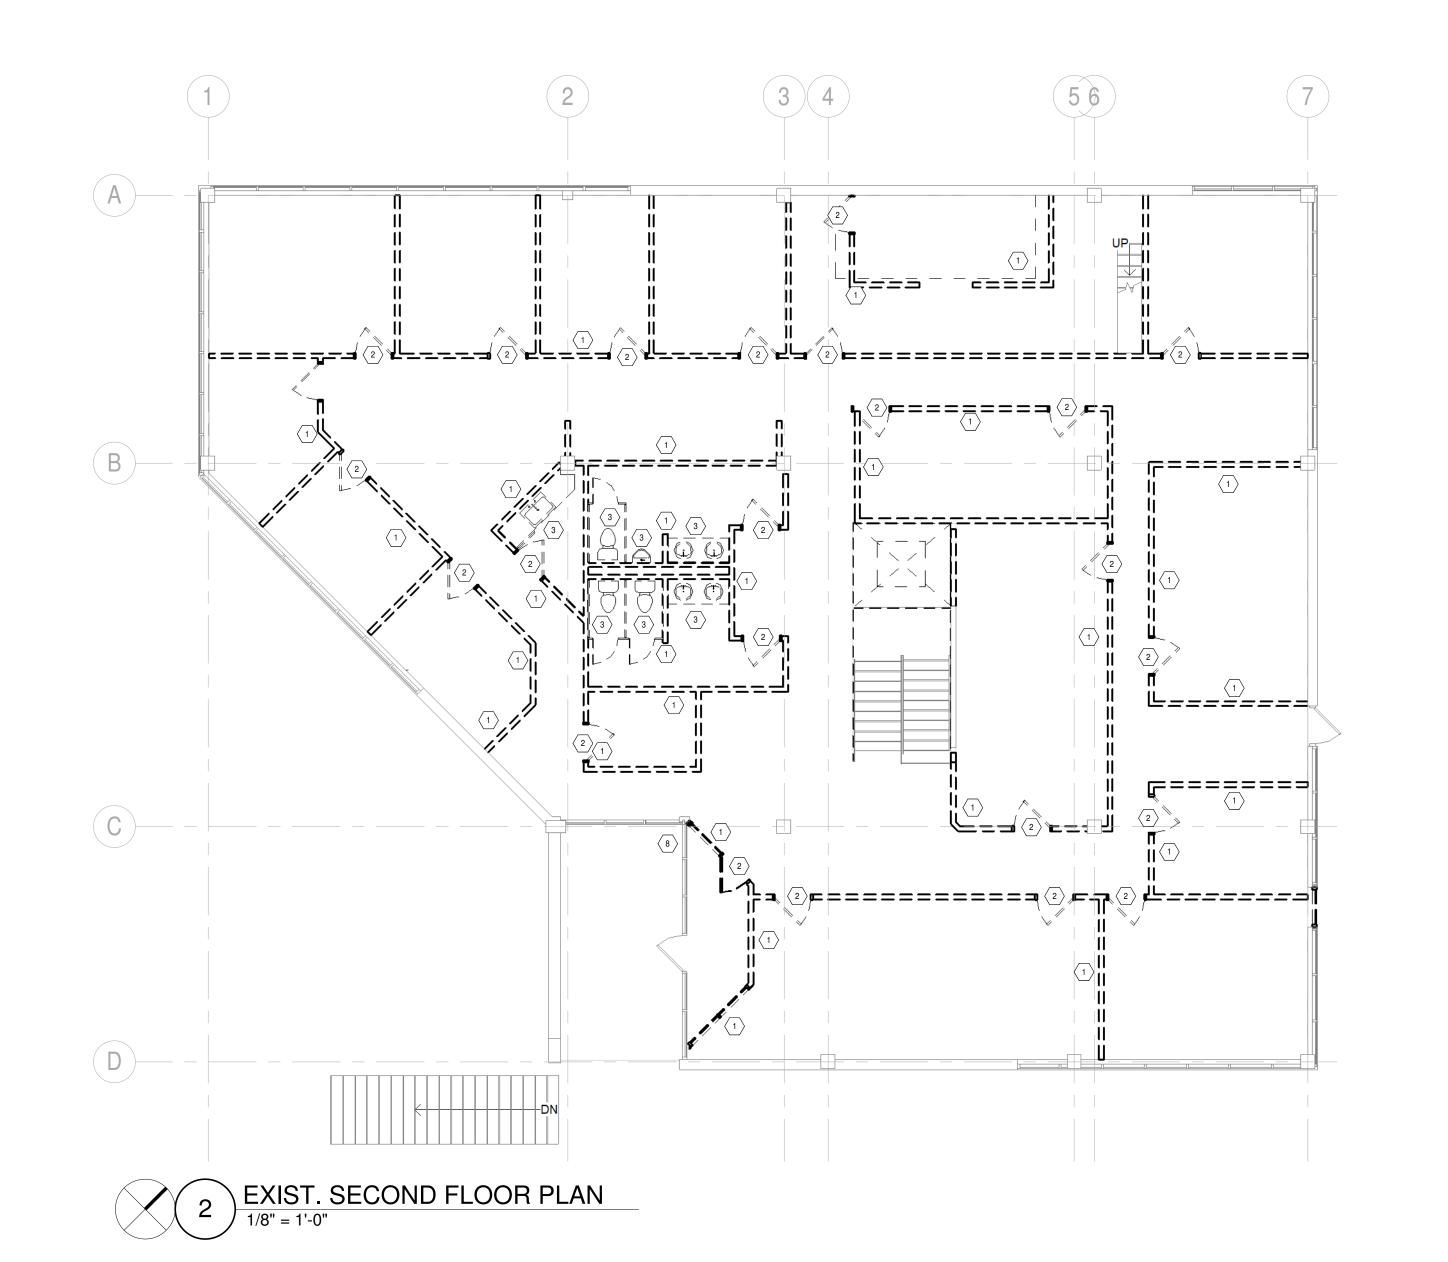

ALLEN PEP

A R C H I T E C T

INFO@ALLENPEPA.COM

TEL: (630) 578-1105

215 FULTON ST., GENEVA, IL 60134

HIGHER GROUND - MINETONKA


Schematic Design:
Design Development
Bidding:
Permit:
ISSUE DATE: 02/19/24
POST BID/PERMIT REVISIONS:

PROJECT NO. 24-002
DRAWN BY OS / YL
CHECKED BY EP

DEMOLITION PLAN

A0-1

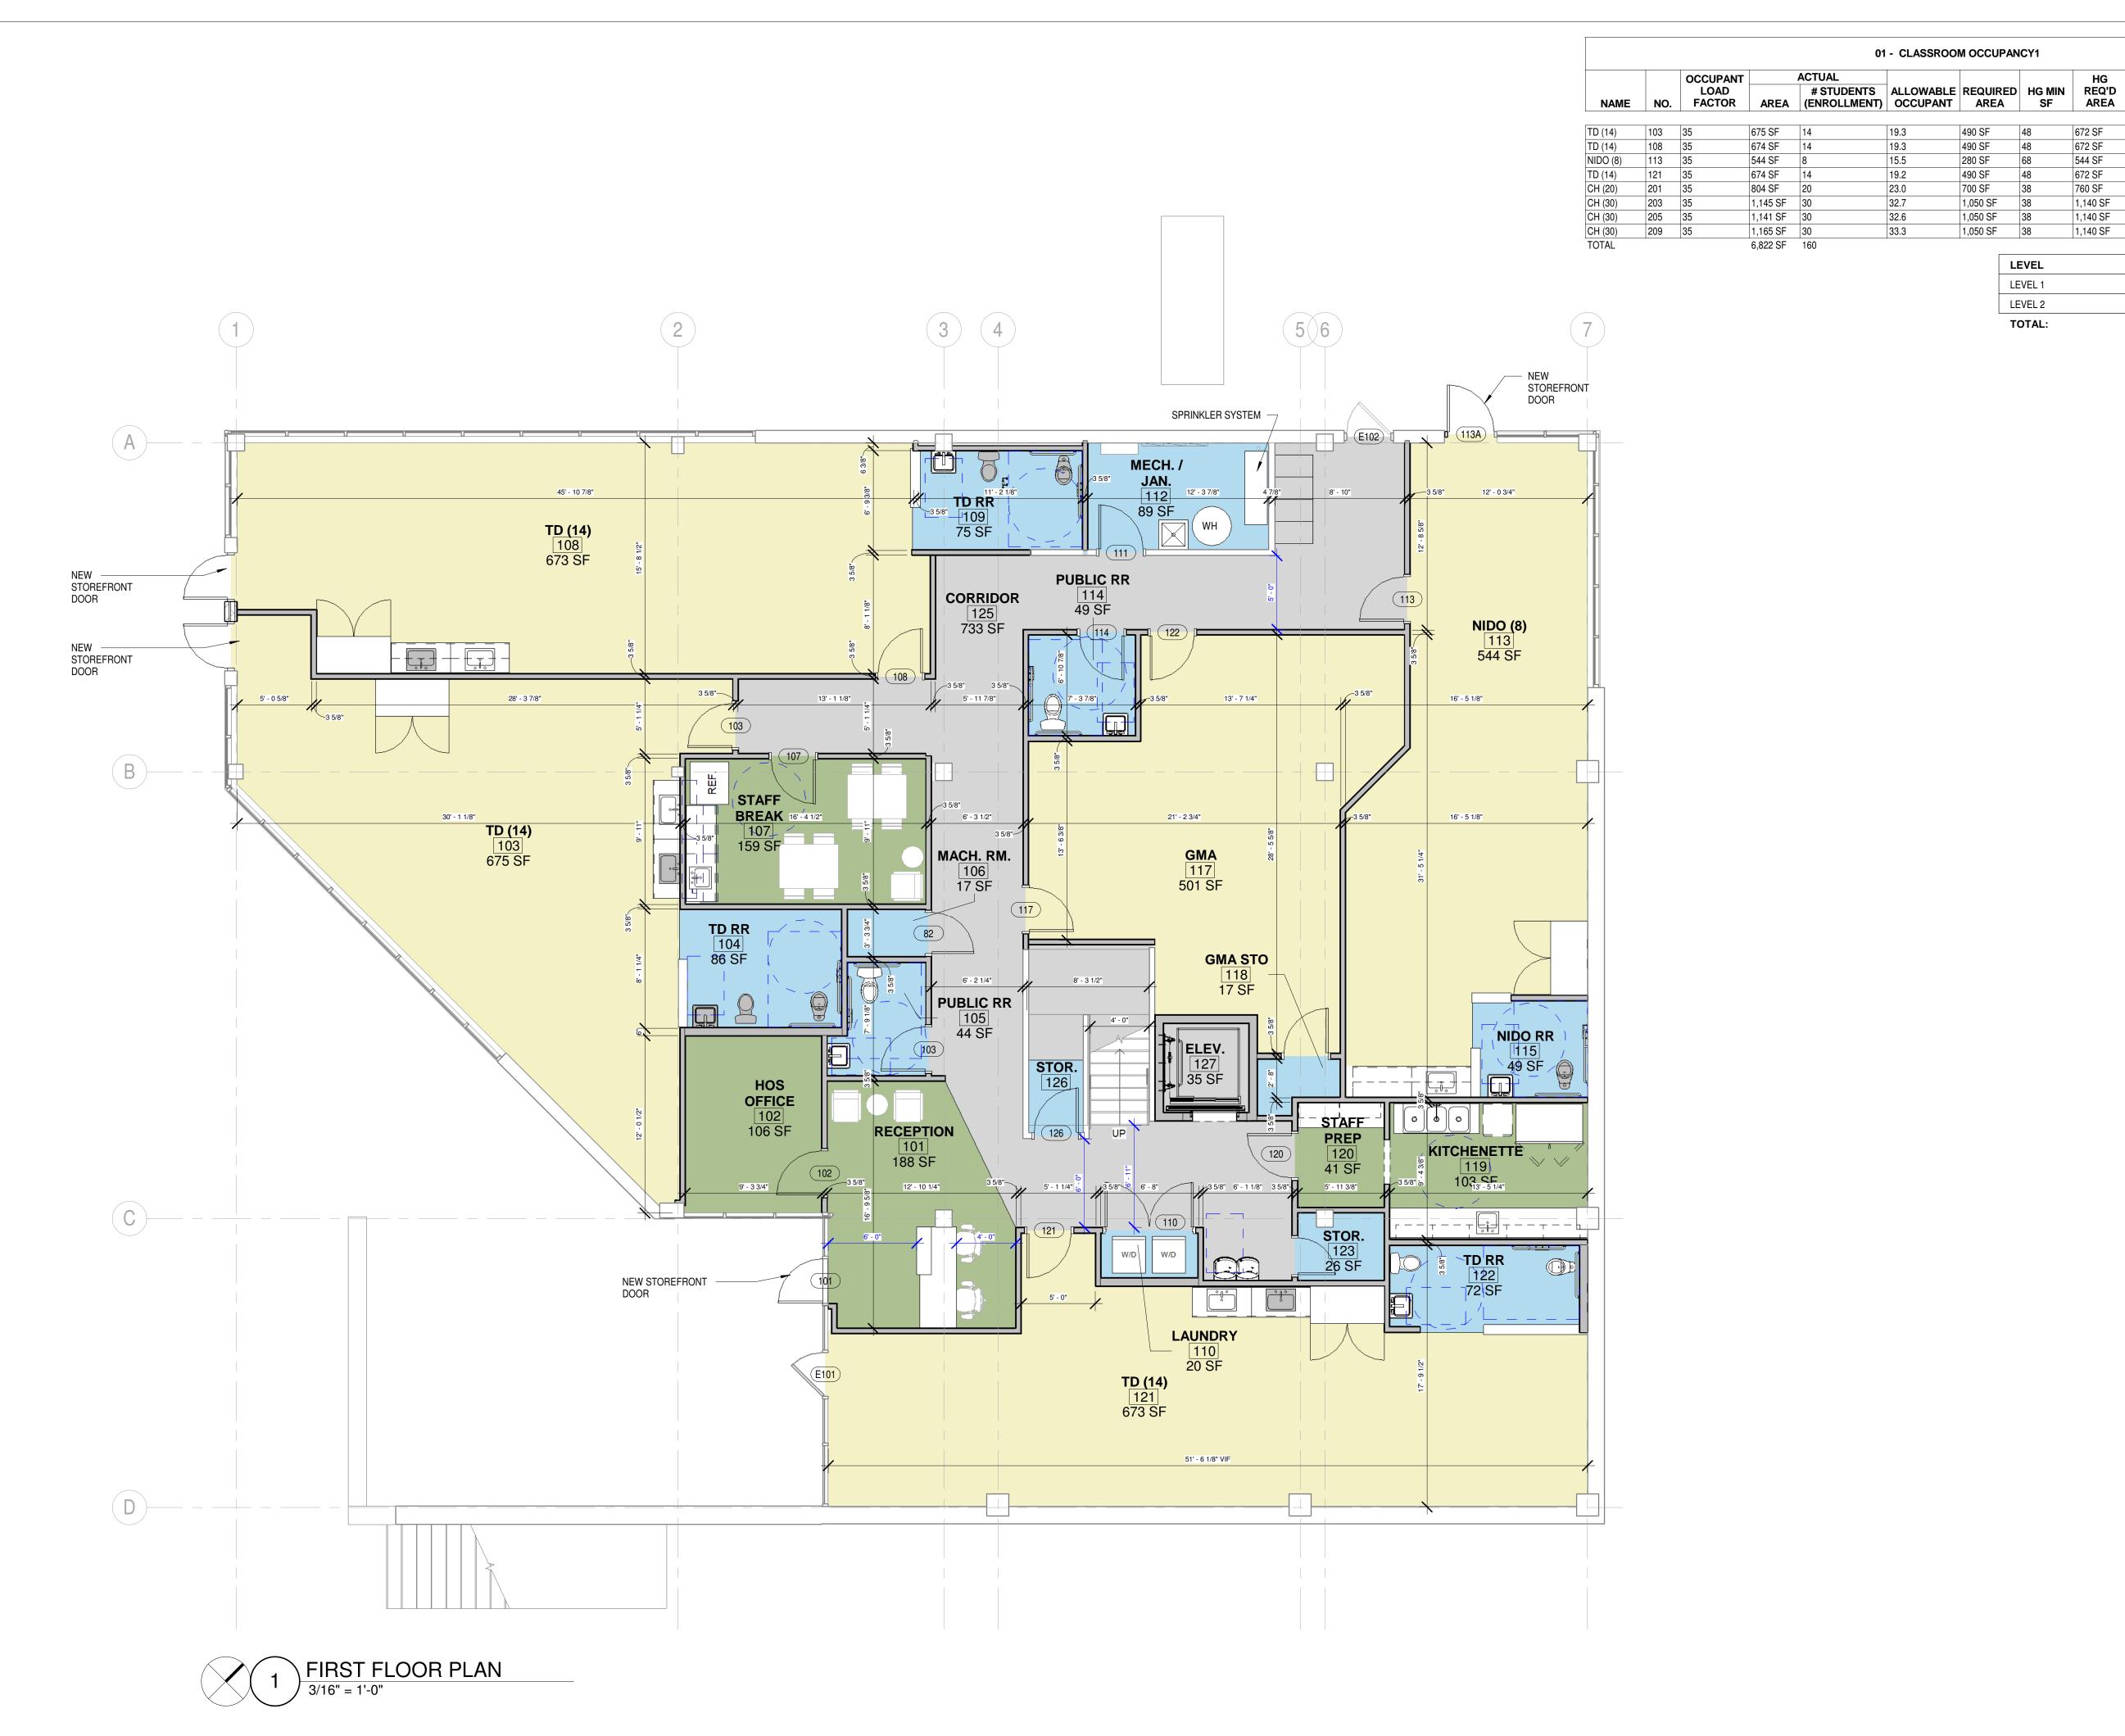SD 2-23-24 (NFC)



MINETONKA GROUND

MINNETONKA

PEPA E C T S

ALLEN

ENGINEERS

14 TODDLERS (24-36 MO.) FIRST FLOOR
14 TODDLERS (24-36 MO.) FIRST FLOOR
8 INFANTS (2 WK. - 24 MO.) FIRST FLOOR

 672 SF
 14 TODDLERS (24-36 MO.)
 FIRST FLOOR

 760 SF
 20 CHILDREN (3-6 YRS.)
 SECOND FLOOR

 1,140 SF
 30 CHILDREN (3-6 YRS.)
 SECOND FLOOR

 1,140 SF
 20 CHILDREN (3-6 YRS.)
 SECOND FLOOR

 1,140 SF
 30 CHILDREN (3-6 YRS.)
 SECOND FLOOR

 1,140 SF
 30 CHILDREN (3-6 YRS.)
 SECOND FLOOR

AREA

5,686 SF

5,643 SF

11,329 SF

01 - CLASSROOM OCCUPANCY1

280 SF

490 SF

700 SF 1,050 SF 1,050 SF 1,050 SF

LEVEL

LEVEL 1

LEVEL 2

TOTAL:

ACTUAL

675 SF 674 SF 544 SF

674 SF


804 SF 20 1,145 SF 30 1,141 SF 30 1,165 SF 30

6,822 SF 160


CIR DR, HIGHER YELLOW Schematic Design: Design Development ISSUE DATE: 02/19/24


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2 OF 3 FIRST FLOOR PLAN

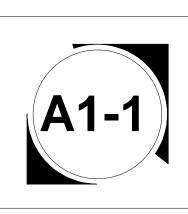

SECOND FLOOR PLAN
3/16" = 1'-0"



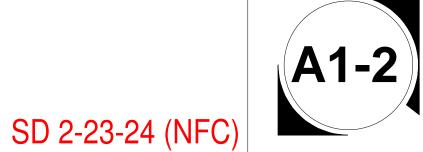

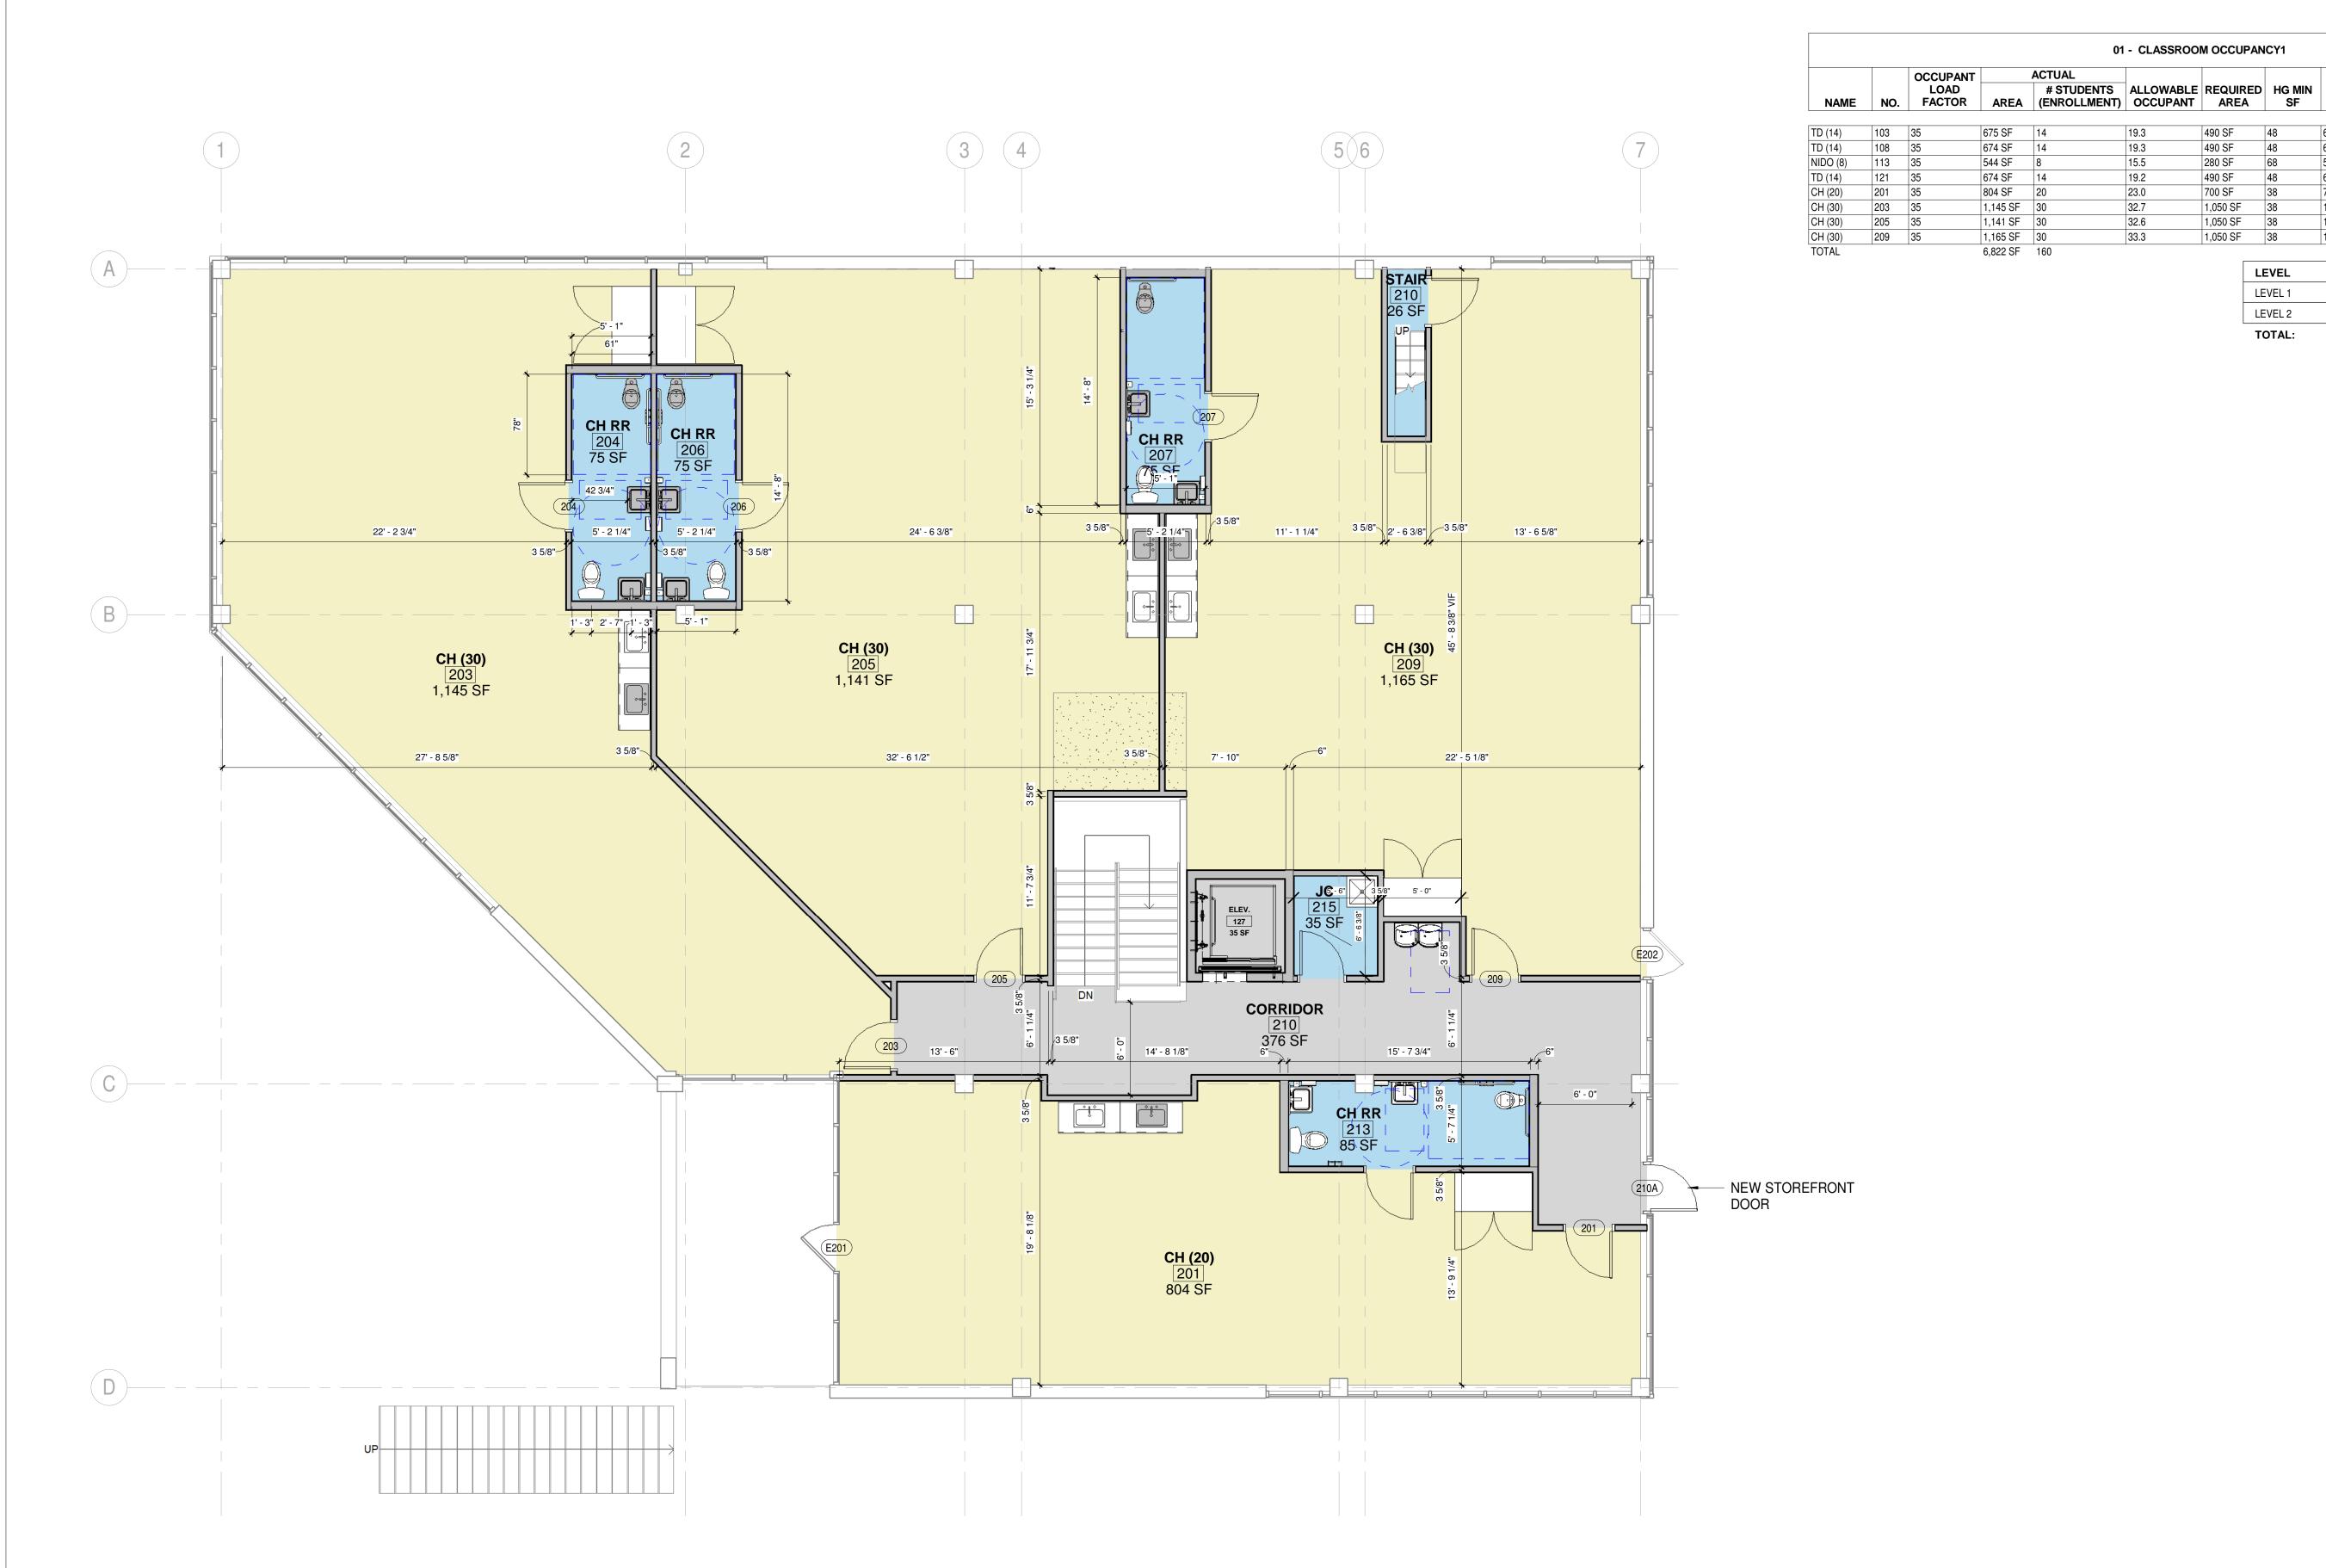MINETONKA GROUND HIGHER

Schematic Design: Design Development

ISSUE DATE:

PROJECT NO.

DRAWN BY

CHECKED BY

POST BID/PERMIT REVISIONS: No. Date Description

SECOND FLOOR PLAN

02/19/24

OS / YL

3 OF 3

CIR DR,

PEPA E C T S ALLEN

ENGINEERS

01 - CLASSROOM OCCUPANCY1

490 SF

490 SF 280 SF 490 SF

700 SF

1,050 SF 1,050 SF

1,050 SF 38

LEVEL

LEVEL 1

LEVEL 2

TOTAL:

32.7 32.6

33.3

675 SF 14 674 SF 14 544 SF 8 674 SF 14

804 SF 20

1,145 SF 30 1,141 SF 30 1,165 SF 30 6,822 SF 160

HG REQ'D AREA

14 TODDLERS (24-36 MO.) FIRST FLOOR

 672 SF
 14 TODDLERS (24-36 MO.)
 FIRST FLOOR

 672 SF
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 544 SF
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 1,140 SF
 30 CHILDREN (3-6 YRS.)
 SECOND FLOOR

 1,140 SF
 30 CHILDREN (3-6 YRS.)
 SECOND FLOOR

AREA

5,686 SF

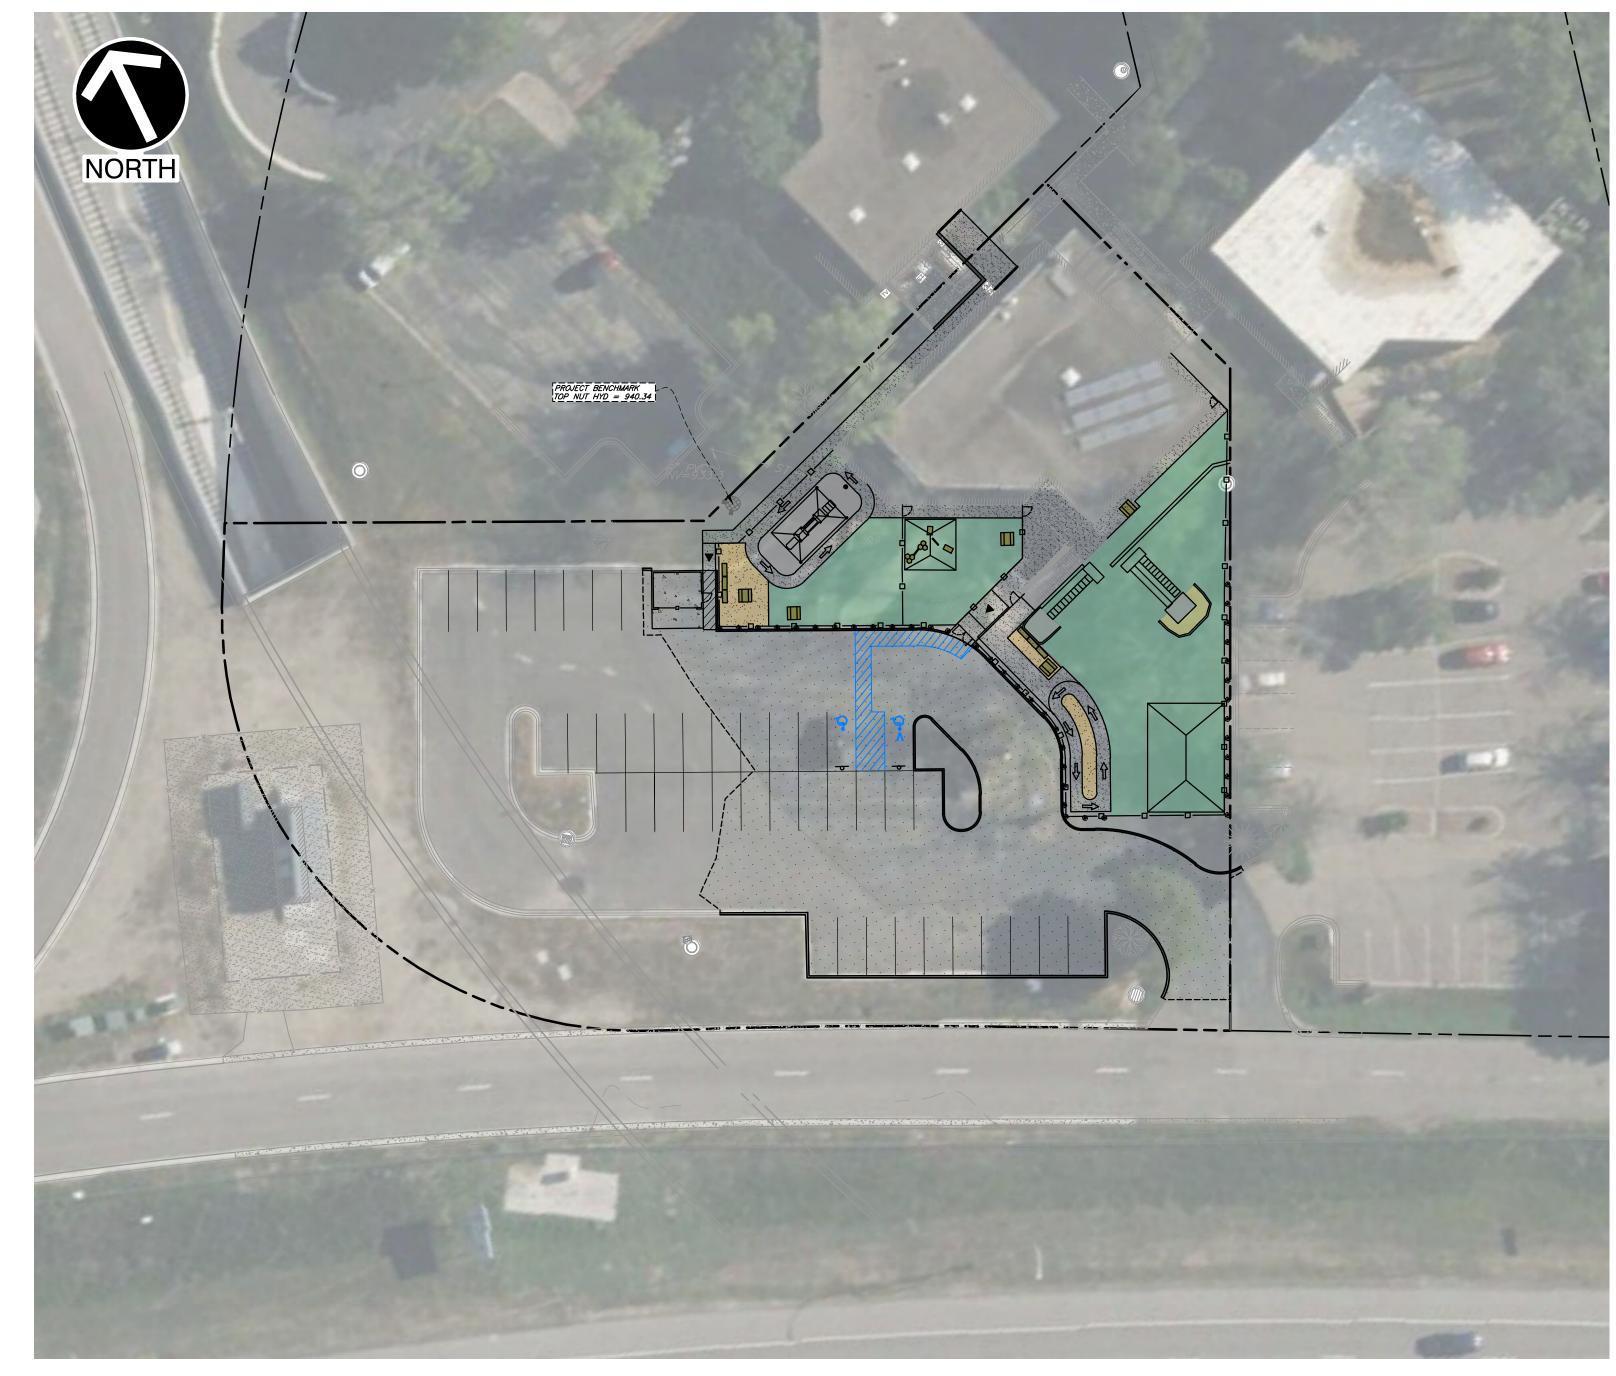
5,643 SF

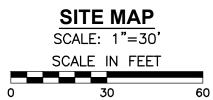
11,329 SF



HIGHER GROUND EDUCATION

A TRACT OF LAND BEING LOT 2, BLOCK 1, OPUS 2 SIXTH ADDITION, HENNEPIN COUNTY, MINNESOTA





PROJECT AREA	23,053	0.53	
DISTURBED AREA*	4,231	0.10	
DISTURBANCE AREA BREA	KDOWN		
	AREA (SF)	AREA (AC)	
MILL & OVERLAY	12,114	0.28	(not included in disturbance)*
REPLACED CONCRETE	1,915	0.04	(not included in disturbance)*
SIDEWALKS / TRAILS	918	0.02	(not included in disturbance)*
IMPERVIOUS TO GRASS (SUBGRADE TO REMAIN)	3,248	0.07	
GRASS TO REMAIN	3,875	0.09	(not included in disturbance)
IMPERVIOUS	983	0.02	
TOTAL DISTURBED AREA	4,231	0.10	

APPLICABLE VOLUME RETENTION AREA

1.29

Per City of Minnetonka and Nine Mile Creek Watershed District stormwater management requirements, no permit is required for disturbances under 5,000 sq.ft.

*Per NMWSD, Disturbance does not include:

1. Rehabilitation, including mill and overlay, of paved surfaces.

2. Trails, sidewalks and retaining walls that do not exceed 10 feet in width and are bordered downgradient by a pervious area extending at least half the width of the trail, sidewalk or

IMPROVEMENT AREA

TOTAL SITE AREA

ELEVATIONS BASED ON INFORMATION AS SHOWN ON THE MNDOT GEODETIC WEBSITE. SURVEY DISK HEART WITH AN ELEVATION OF 962.10 WAS USED TO ESTABLISH VERTICAL CONTROL FOR THIS SURVEY (NAVD 88).

PROJECT BENCHMARK SHOWN GRAPHICALLY.

https://www.gopherstateonecall.org/

TOPOGRAPHIC INFORMATION BASED UPON THE SURVEY CONDUCTED BY CORNERSTONE LAND SURVEYING, INC. DATED FEBRUARY 2024.

NOTE TO CONTRACTOR: PRIOR TO ANY EXCAVATION FOR UNDERGROUND UTILITIES, CONTRACTOR SHALL EXPOSE AND VERIFY LOCATIONS (HORIZONTAL AND VERTICAL) OF ALL EXISTING UTILITIES INCLUDING BUT NOT LIMITED TO GAS, WATER, BROADBAND, PHONE, SANITARY AND STORM SEWERS. ANY CONFLICT SHALL BE REPORTED IMMEDIATELY TO THE ENGINEER AND APPROPRIATE AUTHORITIES

SURVEYOR **CORNERSTONE LAND** SURVEYING, INC 1970 NORTHWESTERN AVE STILLWATER, MN 55082

PHONE: (651) 275-8969

DEVELOPER **NVS PROPERTIES 39, INC.** 227 W. MONROE, STE 5040 CHICAGO, IL 60606

CIVIL ENGINEER CIVIL & ENVIRONMENTAL CONSULTANTS, INC.

3000 LITTLE HILLS EXPRESSWAY SUITE 102 ST. CHARLES, MO 63301 PH: (314) 656-4566 FX: (314) 656-4595 CONTACTS: PATRICK BENNETT

ARCHITECT ALLEN + PEPA ARCHITECTS 215 FULTON STREET GENEVA, IL 60134 PH: (630) 578-1105 CONTACTS: ERIC PEPA

EPEPA@ALLENPEPA.COM

SIE

U.S.G.S. 7.5 TOPOGRAPHIC MAP, HOPKINS QUADRANGLE, MN DATED 2022.

DEVELOPMENT NOTES:

HOPKINS MN, 55343 I-1 INDUSTRIAL DISTRICT OPUS OVERLAY DISTRICT 4. ZONING:

5. SITE USE:

EXISTING = OFFICE

PROPOSED = CHILD CARE FACILITY

6. COMPREHENSIVE PLAN EXISTING LAND USE = OFFICE

SIDE/REAR 30 FEET 9. MAX. BUILDING HEIGHT

AS SHOWN ON FEMA FLOOD INSURANCE RATE MAP NUMBER 27053CO343F DATED NOVEMBER 4, 2016, THIS PROPERTY LIES WITHIN THE UNSHADED ZONE X, AREAS DETERMINED TO BE OUTSIDE THE 0.2% ANNUAL CHANCE FLOODPLAIN.


11.	PARKING REQUIREM	ENTS:		
		CODE DECLUDEMENT	FLOOR AREA	PARKING
		CODE REQUIREMENT	(SQ.FT.)	REQUIRED
	EDUCATIONAL FACILITY	2.5 per 1,000 sq.ft. of gross floor area	10,880	28
	PARKING F	PROVIDED INCLUDING 2 AD	A SPACES	42


Sheet Description

Sheet Number Sheet Title Sheet Description


01	C000	COVER SHEET
02	C100	EXISTING CONDITIONS / DEMO PLAI
03	C200	SITE & UTILITY PLAN
04	C300	GRADING PLAN
05	C301	GRADING PLAN
06	HYD	DRAINAGE AREA MAPS

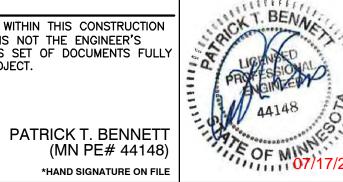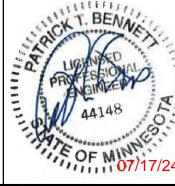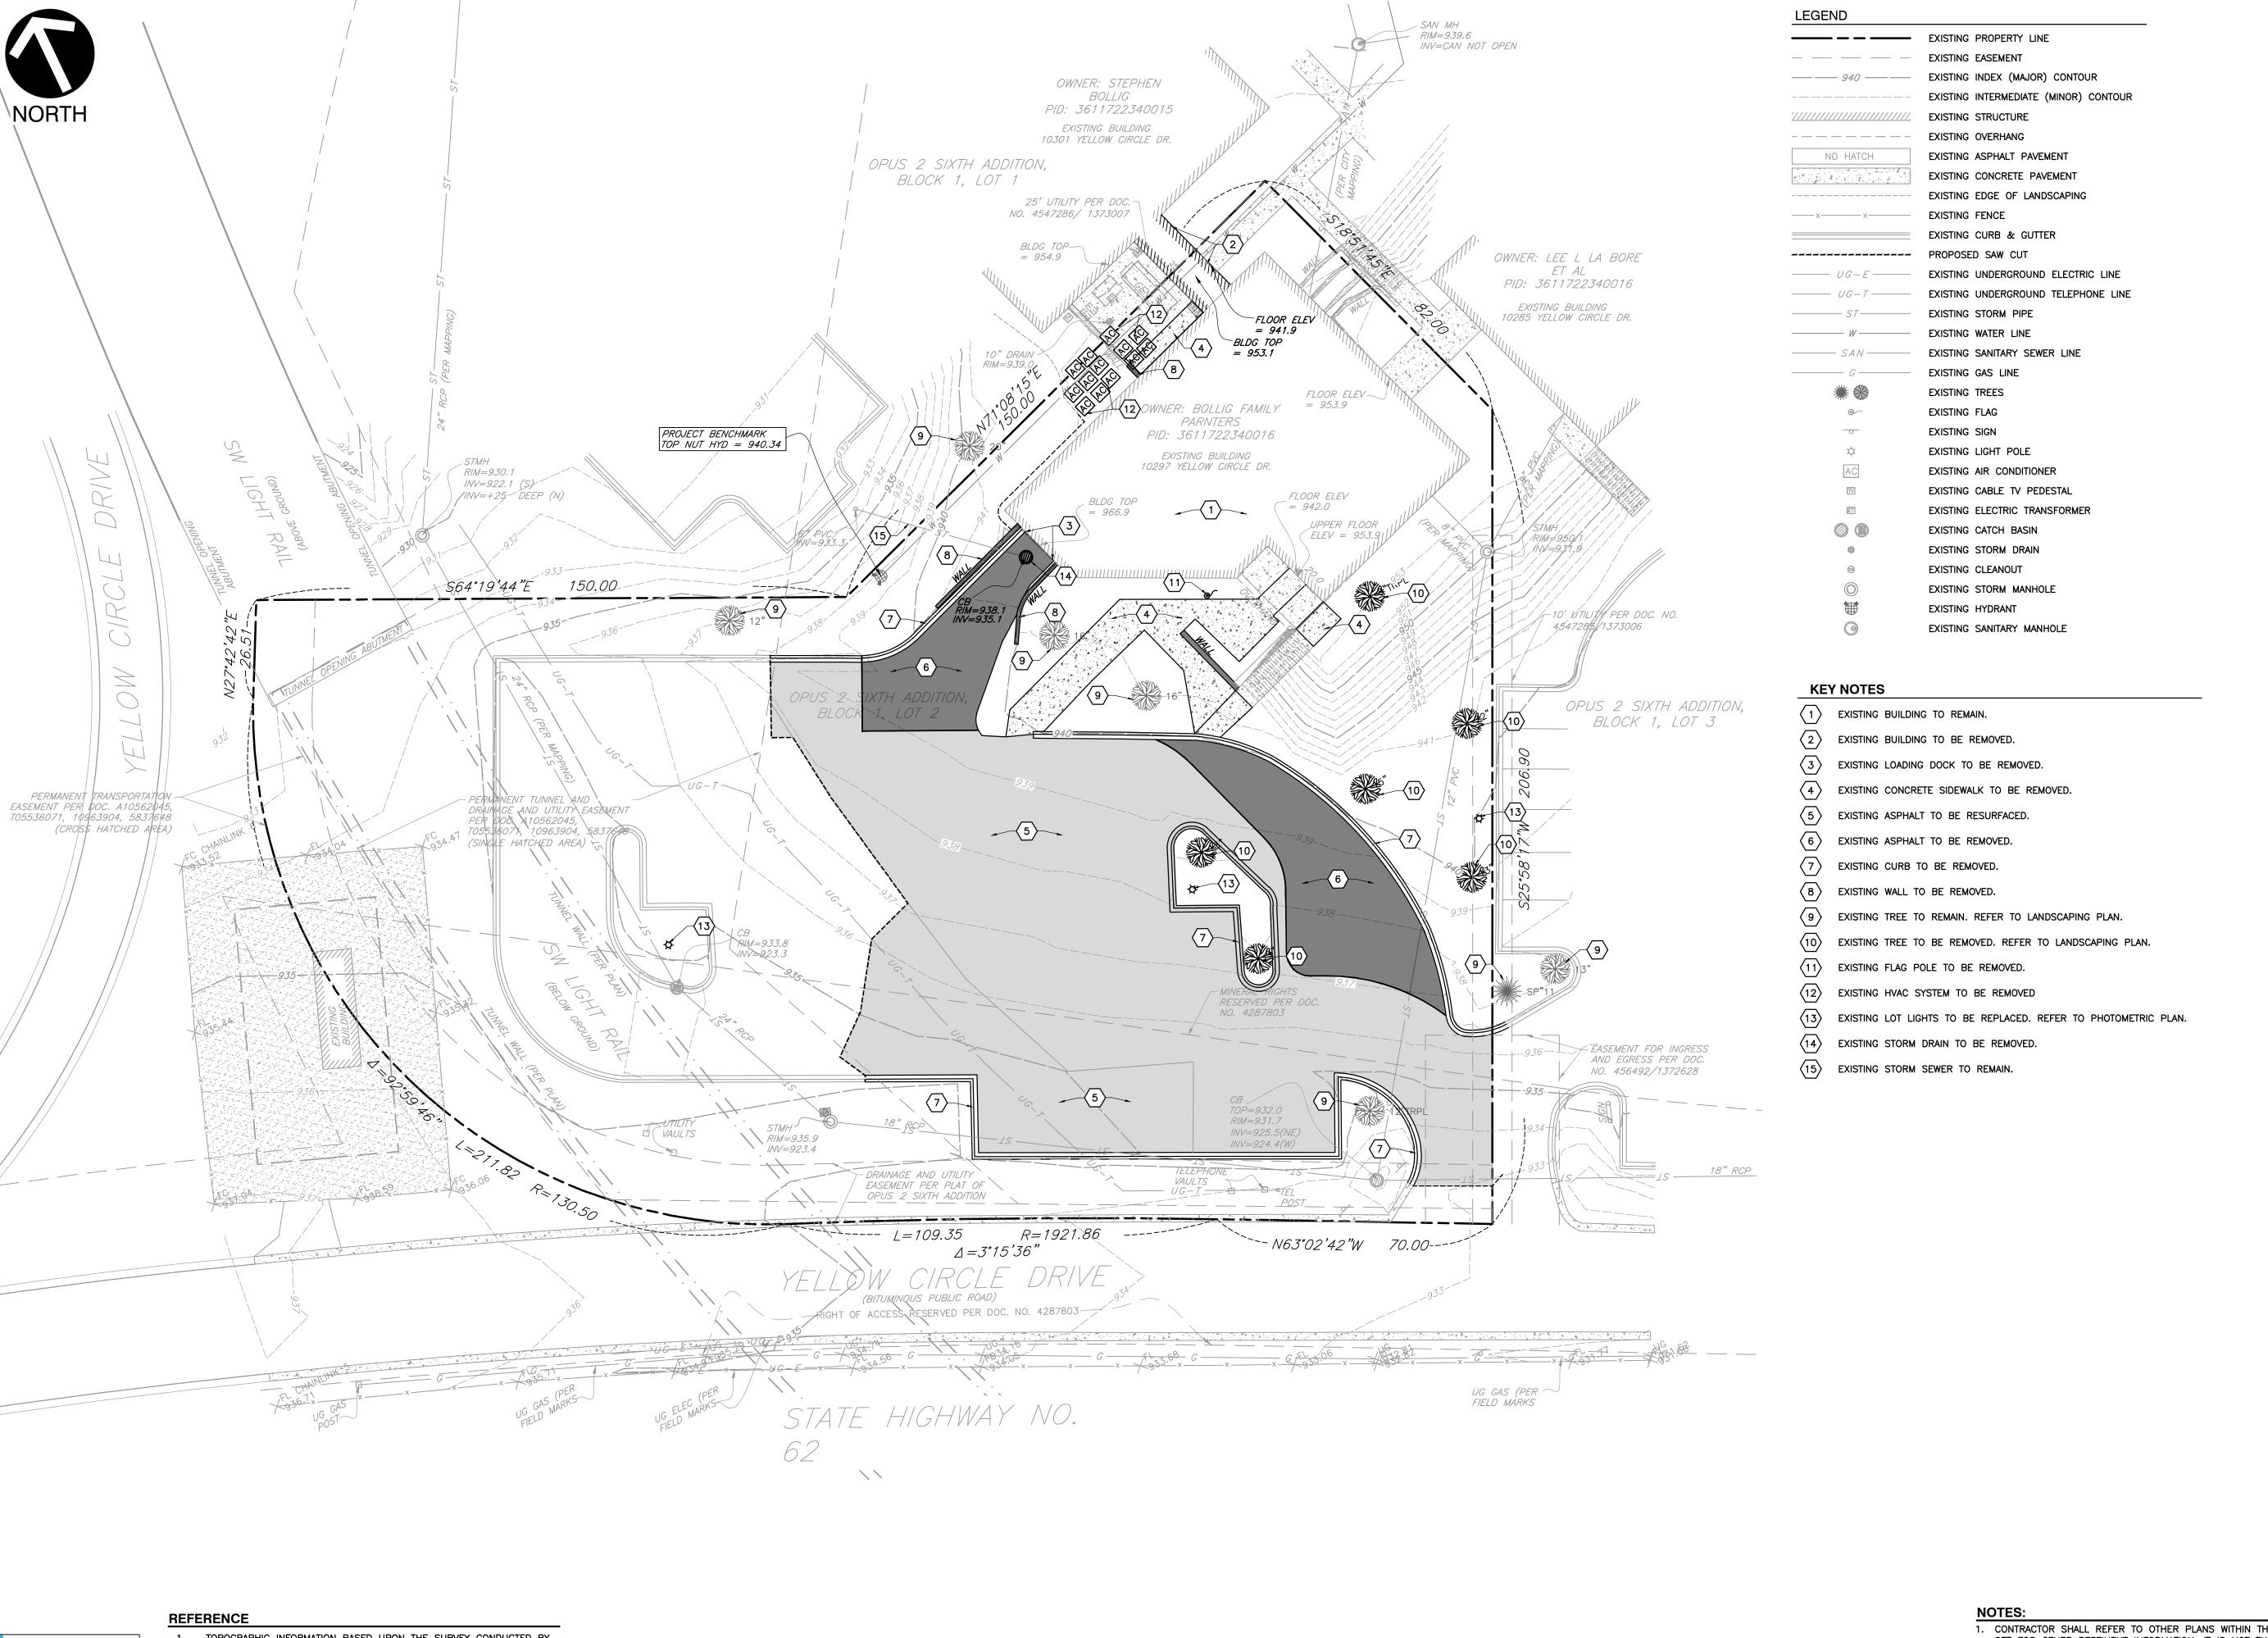. CONTRACTOR SHALL REFER TO OTHER PLANS WITHIN THIS CONSTRUCTION SET FOR OTHER PERTINENT INFORMATION. IT IS NOT THE ENGINEER'S INTENT THAT ANY SINGLE PLAN SHEET IN THIS SET OF DOCUMENTS FULLY DEPICT ALL WORK ASSOCIATED WITH THIS PROJECT.









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9. 2024 DRAWN BY: 1"=20' CHECKED BY CONDITIONS / DRAWING NO.:

3000 L Suite | St. Cha Ph: 3 L

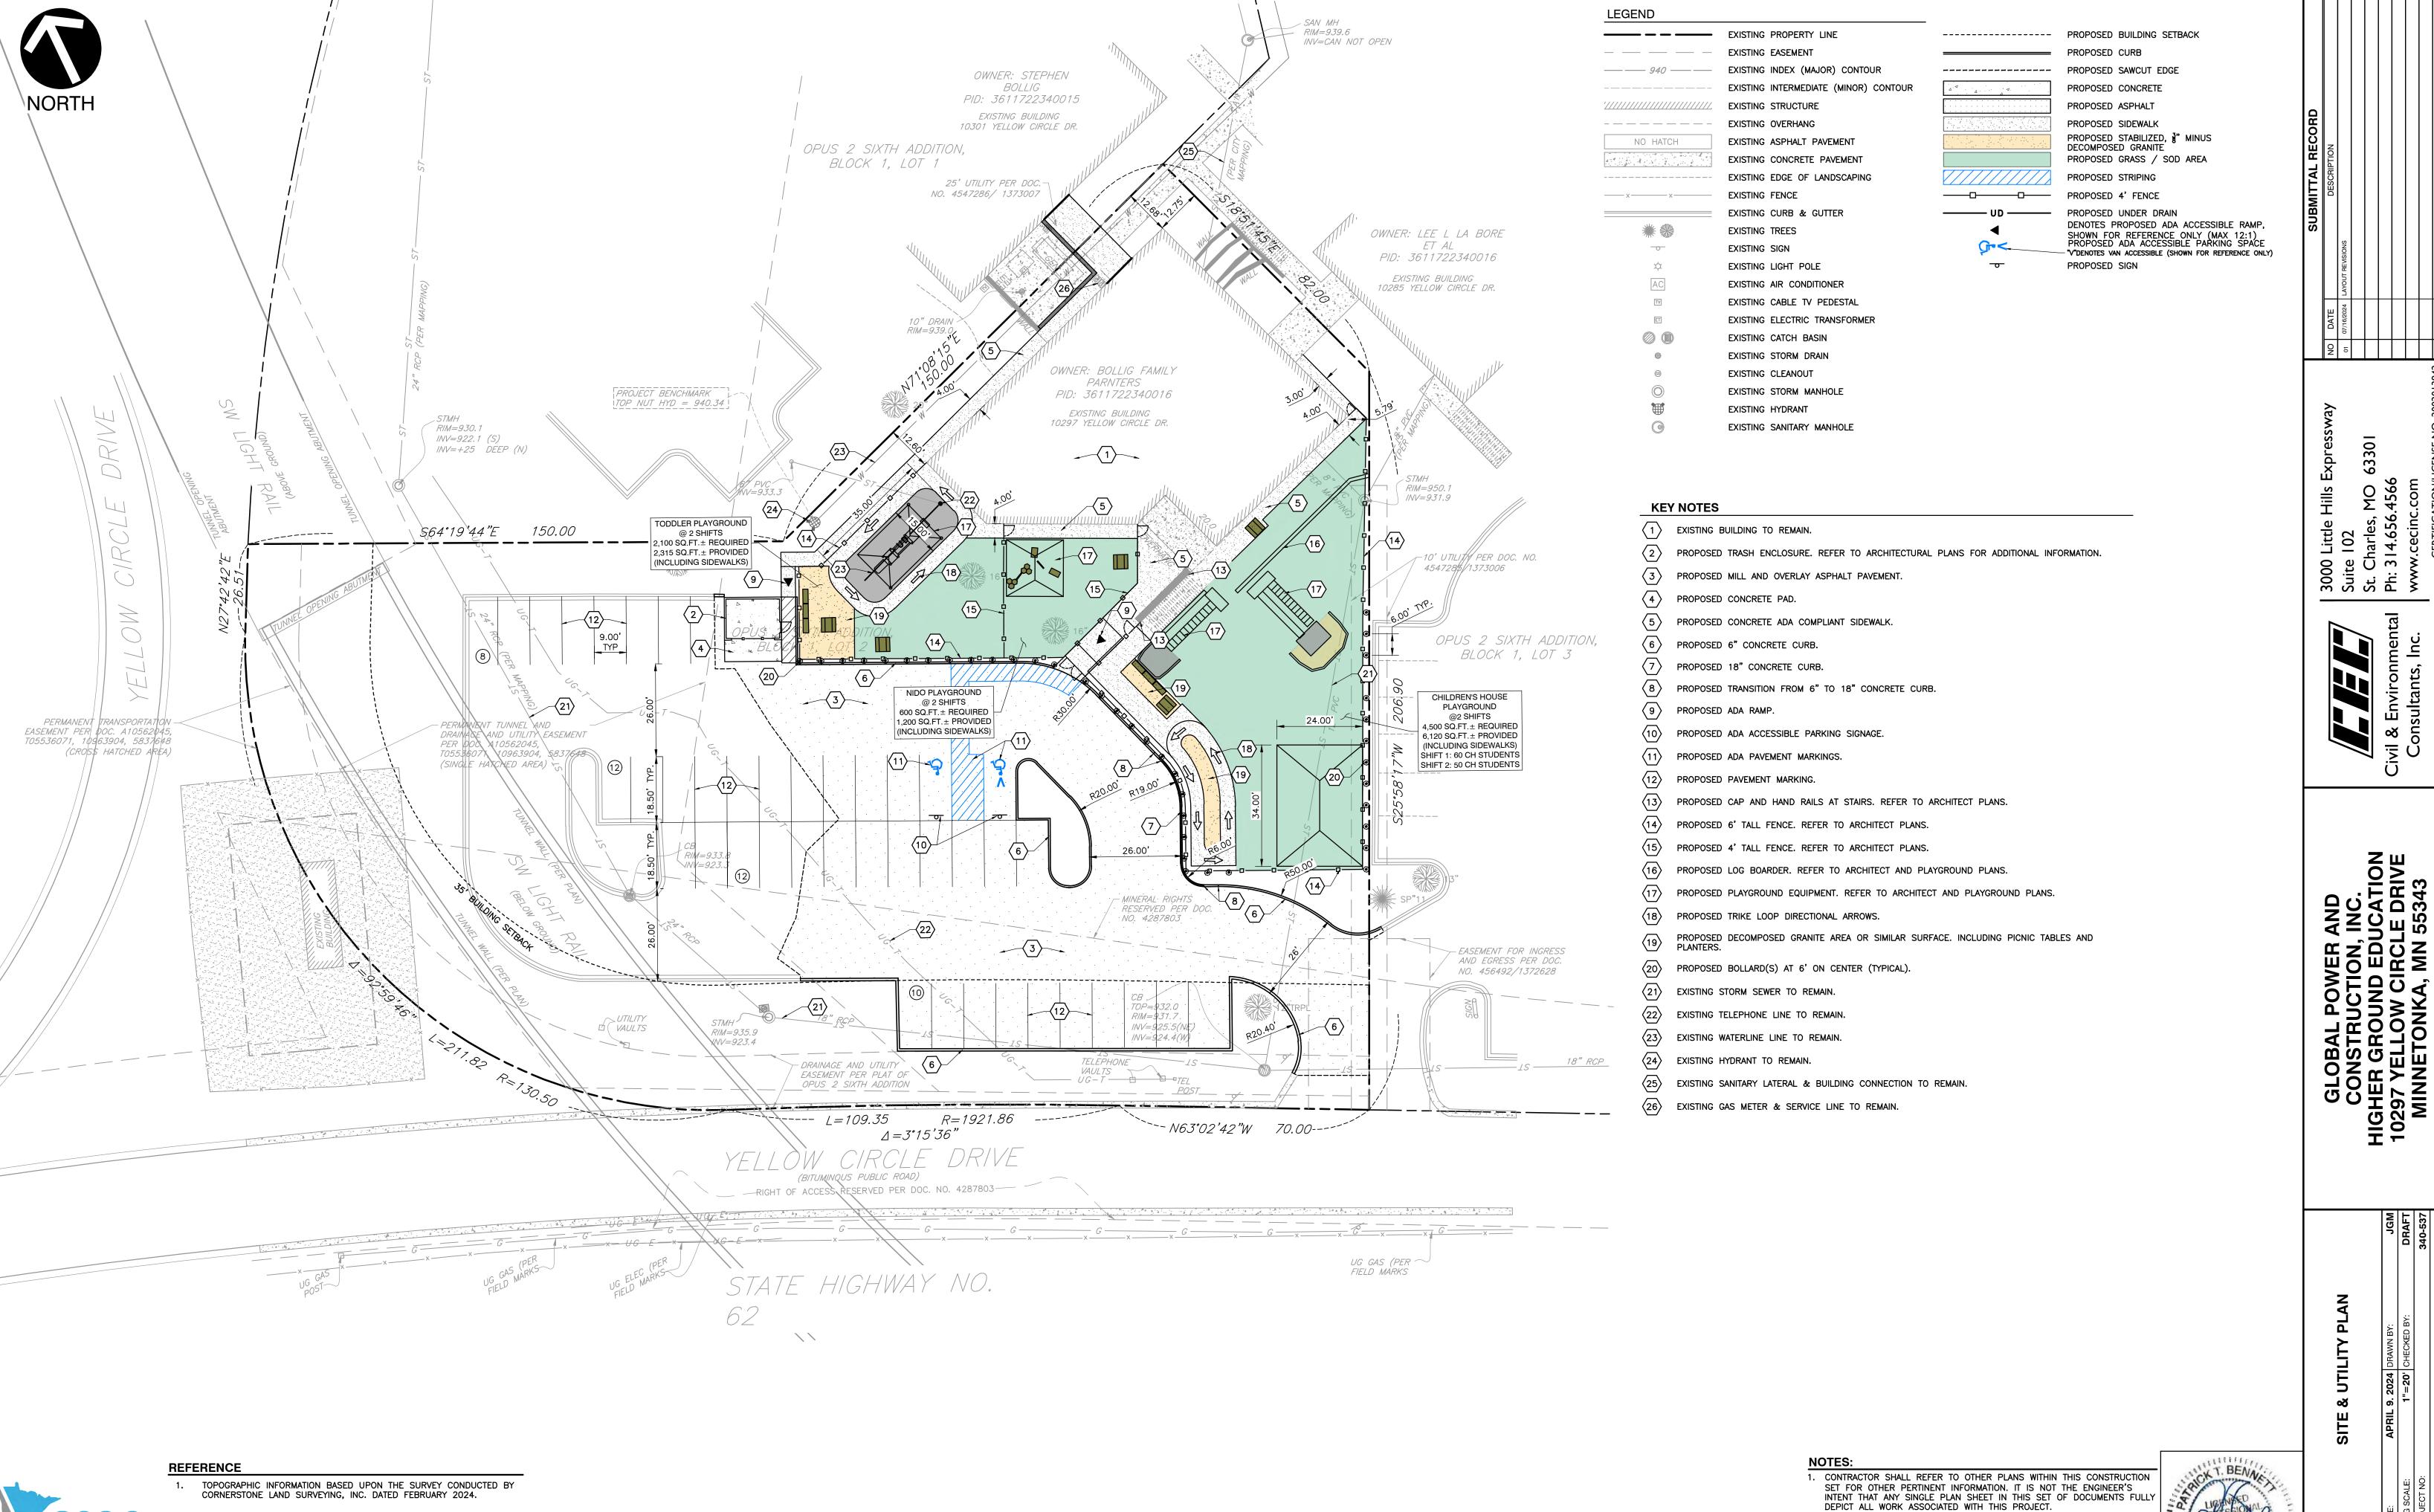
GLOBAL POWER AND CONSTRUCTION, INC. HIGHER GROUND EDUCATION 10297 YELLOW CIRCLE DRIVE MINNETONKA, MN 55343

C100 SHEET **02** OF **06**

TOPOGRAPHIC INFORMATION BASED UPON THE SURVEY CONDUCTED BY CORNERSTONE LAND SURVEYING, INC. DATED FEBRUARY 2024.

GOPHER STATE ONE CAL

NOTE TO CONTRACTOR: PRIOR TO ANY EXCAVATION FOR UNDERGROUND UTILITIES, CONTRACTOR SHALL EXPOSE AND VERIFY LOCATIONS (HORIZONTAL AND VERTICAL) 811 or 1-800-252-1166
https://www.gopherstateonecall.org/




NOTE TO CONTRACTOR: PRIOR TO ANY EXCAVATION FOR UNDERGROUND UTILITIES,


CONTRACTOR SHALL EXPOSE AND VERIFY LOCATIONS (HORIZONTAL AND VERTICAL) OF ALL EXISTING UTILITIES INCLUDING BUT NOT LIMITED TO GAS, WATER, BROADBAND,

https://www.gopherstateonecall.org/

PATRICK T. BENNETT (MN PE# 44148) *HAND SIGNATURE ON FILE

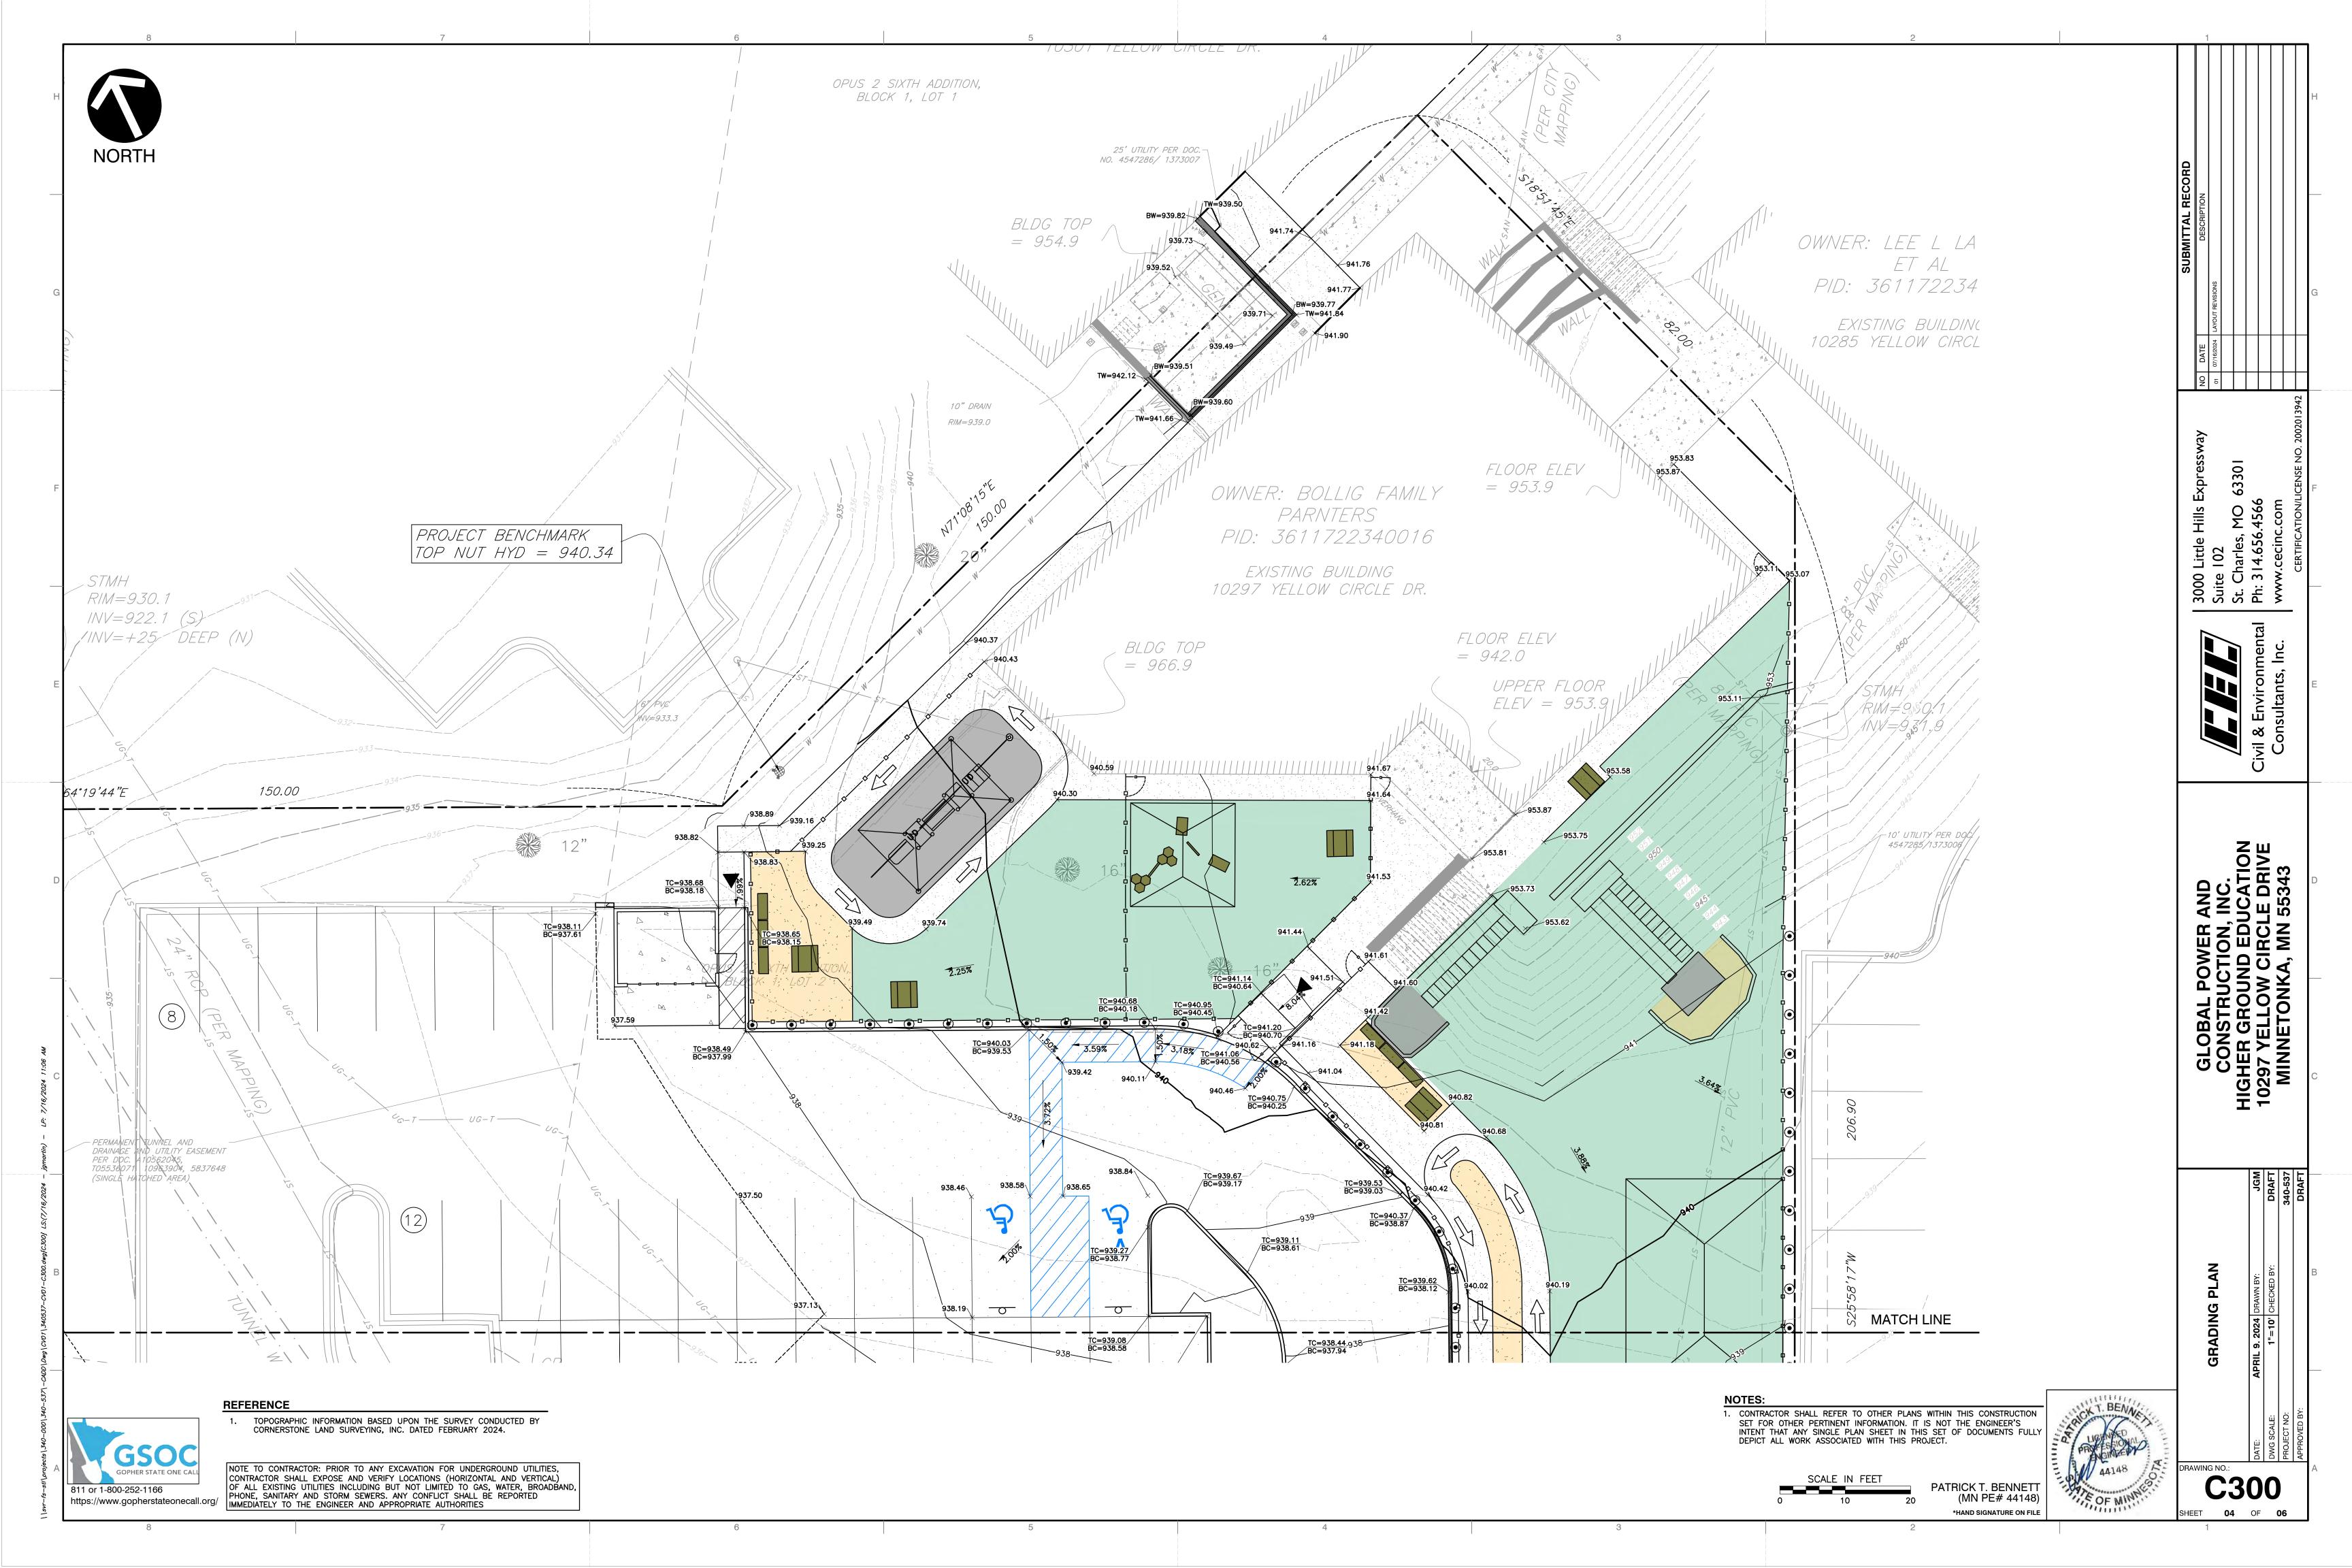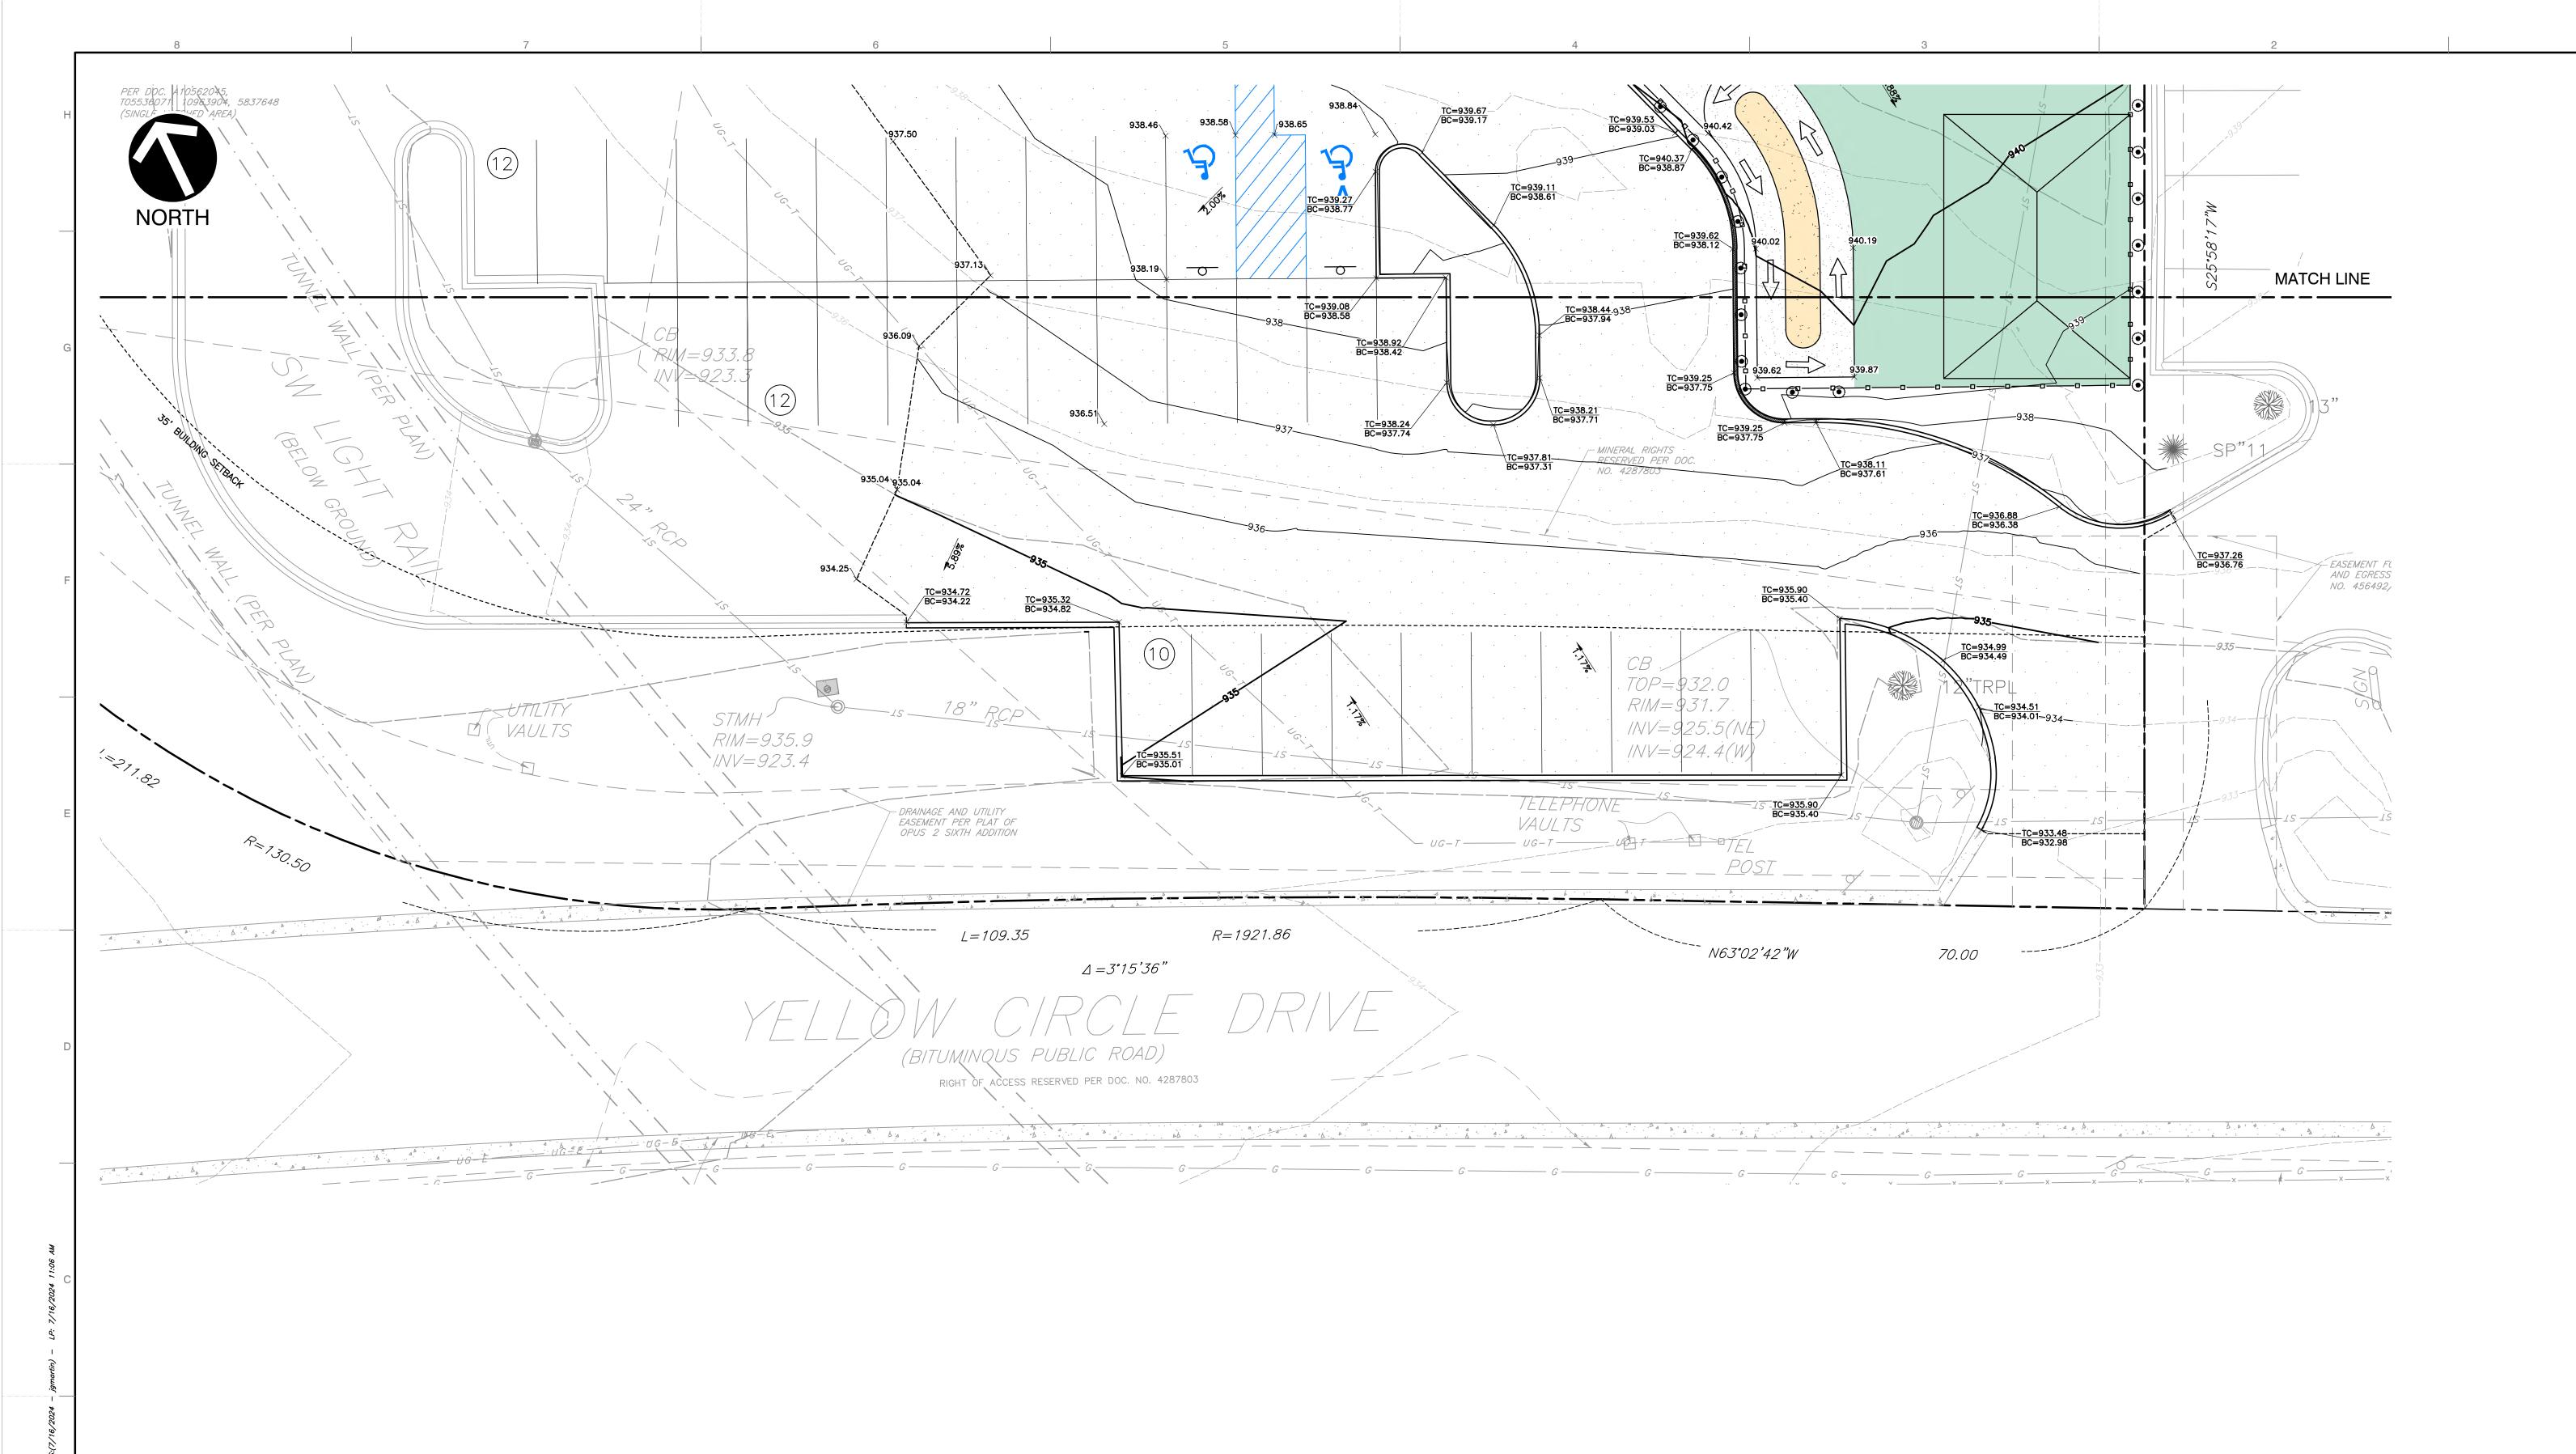DRAWING NO.: SHEET **03** OF **06**






TOPOGRAPHIC INFORMATION BASED UPON THE SURVEY CONDUCTED BY CORNERSTONE LAND SURVEYING, INC. DATED FEBRUARY 2024.

B11 or 1-800-252-1166
https://www.gopherstateonecall.org/

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PATRICK T. BENNETT (MN PE# 44148) *HAND SIGNATURE ON FILE

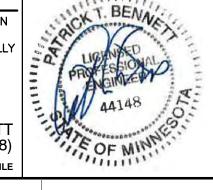

DRAWING NO.: SHEET **05** OF **06**

GRADING PLAN


9. 2024 DRAWN BY: 1"=10' CHECKED BY

3000 Little Hills Essuite 102
St. Charles, MO 6
Ph: 314.656.4566

GLOBAL POWER AND CONSTRUCTION, INC. HIGHER GROUND EDUCATION 10297 YELLOW CIRCLE DRIVE MINNETONKA, MN 55343

EXISTING DRAINAGE AREA MAP

	EXISTING TOTAL	DRAINAGE AREAS				2	YR	10	OYR	10	OYR
DRAINAGE AREA	Description	Subareas	Area (SF)	Area (AC)	С	I (in)	Q (cfs)	1	Q (cfs)	1	Q (cfs)
	7.4.4.4	IMPERVIOUS	1,523	0.03	0.86		0.09		0.13		0.22
XDA#1	WEST RUNOFF	PERVIOUS	8,631	0.20	0.17		0.10		0.14		0.25
		TOTALS	10,154	0.23		2.87	0.18	4.28	0.27	7.46	0.48
	100000000000000000000000000000000000000	IMPERVIOUS	24,931	0.57	0.86		1.41		2.11		3.67
XDA#2	RUNOFF TO EX. CURB INLET	PERVIOUS	4,500	0.10	0.17		0.05		0.08		0.13
		TOTALS	29,431	0.68		2.87	1.46	4.28	2.18	7.46	3.80
	RUNOFF TO EX. GRATE INLET	IMPERVIOUS	192	0.00	0.86		0.01		0.02		0.03
XDA#3		PERVIOUS	3,816	0.09	0.17		0.04		0.06		0.11
		TOTALS	4,008	0.09		2.87	0.05	4.28	0.08	7.46	0.14
		IMPERVIOUS	6,537	0.15	0.86		0.37		0.55		0.96
XDA#4	EAST RUNOFF	PERVIOUS	6,236	0.14	0.17		0.07		0.10		0.18
		TOTALS	12,773	0.29		2.87	0.44	4.28	0.66	7.46	1.14
		TOTALS	56,366	1.29			2.14	1000	3.19		5.56

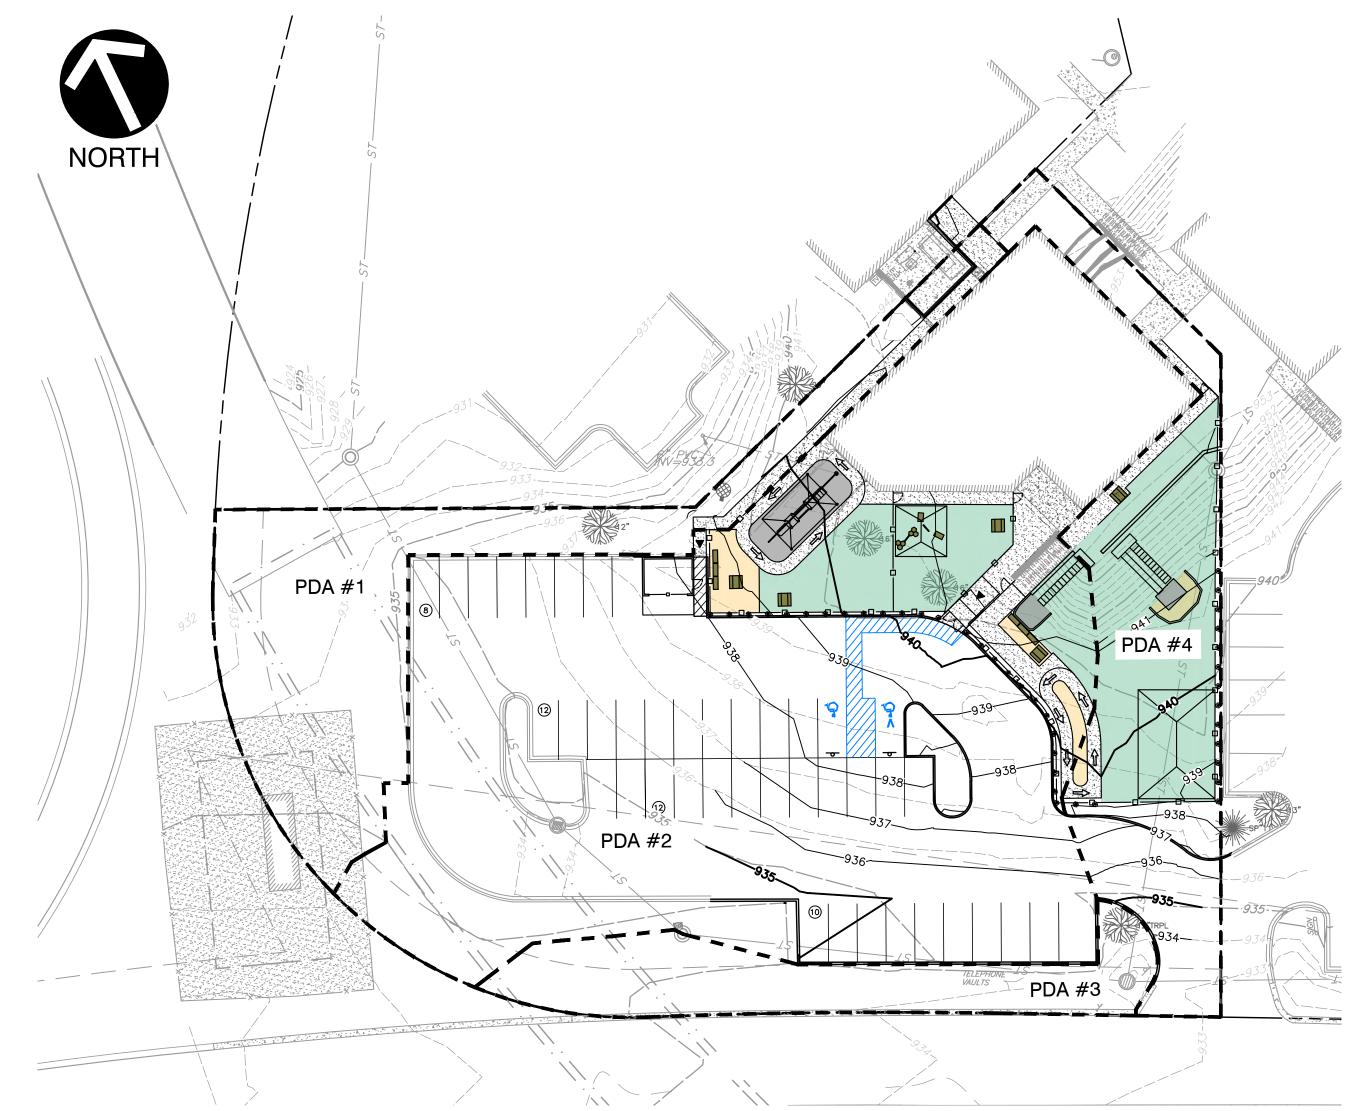

PROPOSED DRAINAGE AREA MAP


	PROPOSED TOTAL	DRAINAGE AREAS			- 0	2	YR	10	OYR	10	OYR
DRAINAGE AREA	Description	Subareas	Area (SF)	Area (AC)	С	1 (in)	Q (cfs)	1	Q (cfs)	1	Q (cfs)
		IMPERVIOUS	803	0.02	0.86		0.05		0.07		0.12
PDA#1	WEST RUNOFF	PERVIOUS	7,931	0.18	0.17		0.09		0.13		0.23
		TOTALS	8,734	0.20		2.87	0.13	4.28	0.20	7.46	0.35
PDA#2A	RONOFF TO EX. CURB INLET	IMPERVIOUS	28,274	0.65	0.86		1.60		2.39		4.16
		PERVIOUS	7,105	0.16	0.17		0.08		0.12		0.21
		TOTALS	35,379	0.81		2.87	1.68	4.28	2.51	7.46	4.37
	RUNOFF TO EX. GRATE INLET	IMPERVIOUS	192	0.00	0.86		0.01		0.02		0.03
PDA#3		PERVIOUS	3,828	0.09	0.17		0.04		0.06		0.11
		TOTALS	4,020	0.09		2.87	0.05	4.28	0.08	7.46	0.14
		IMPERVIOUS	2,666	0.06	0.86		0.15		0.23		0.39
PDA#4	EAST RUNOFF	PERVIOUS	5,566	0.13	0.17		0.06		0.09		0.16
	V-12-12-12-12-12-12-12-12-12-12-12-12-12-	TOTALS	8,232	0.19		2.87	0.21	4.28	0.32	7.46	0.55
		TOTALS	56,365	1.29			2.08		3.11		5.41

TOPOGRAPHIC INFORMATION BASED UPON THE SURVEY CONDUCTED BY CORNERSTONE LAND SURVEYING, INC. DATED FEBRUARY 2024.

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DRAINAGE AREA MAP

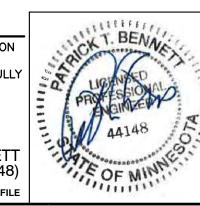DRAWING NO.: SHEET **06** OF **06**

GLOBAL POWER AND CONSTRUCTION, INC. HIGHER GROUND EDUCATION 10297 YELLOW CIRCLE DRIVE MINNETONKA, MN 55343