



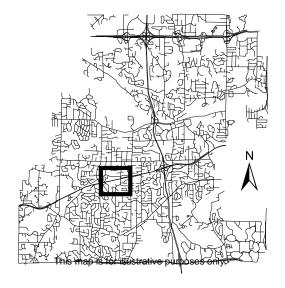



Location Map


Project: Louisiana Residence Address: 4546 Highland Rd

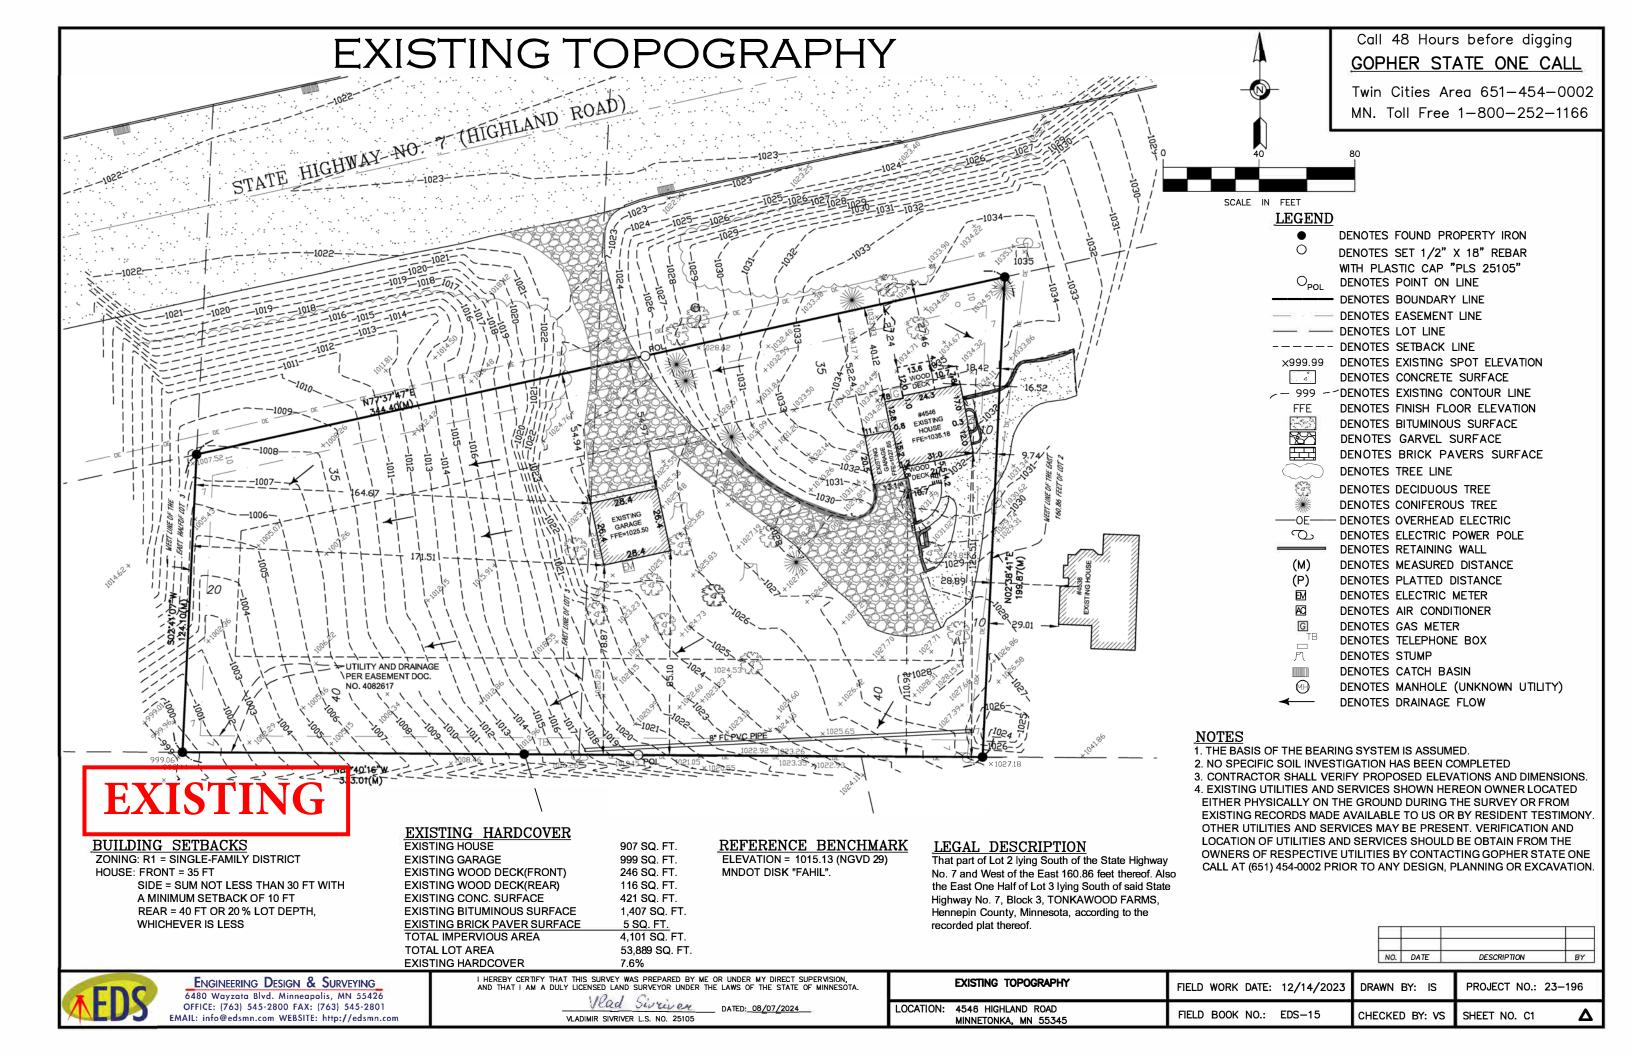




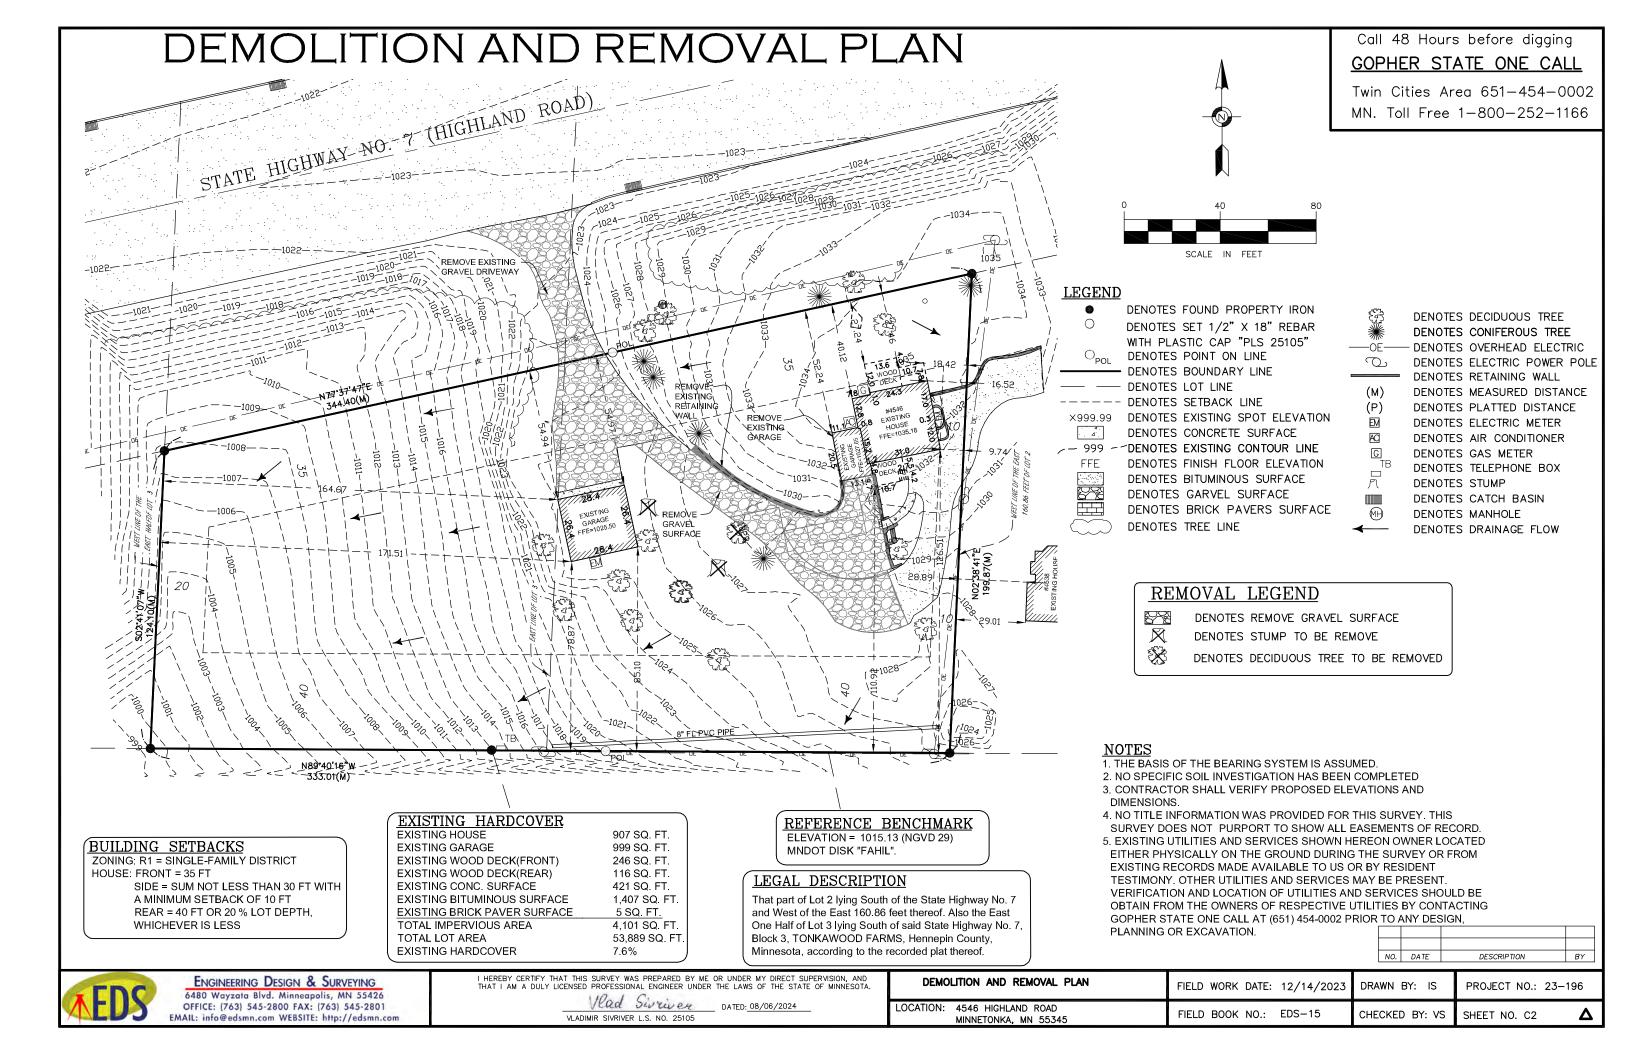

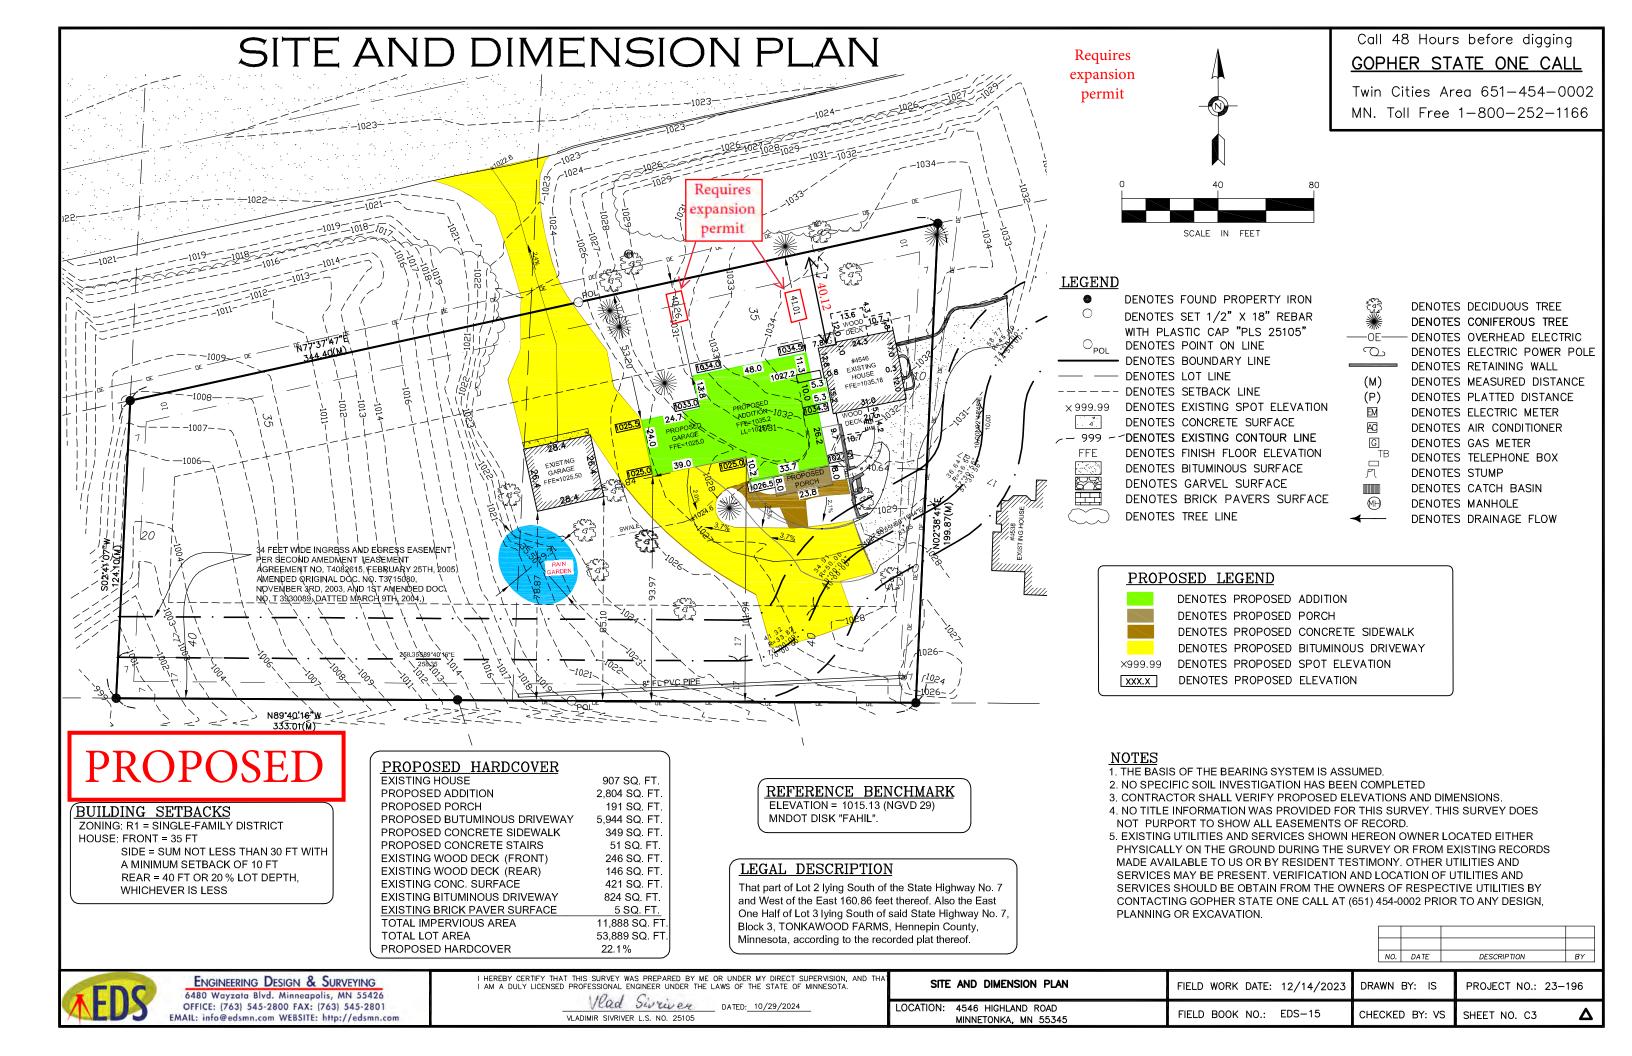

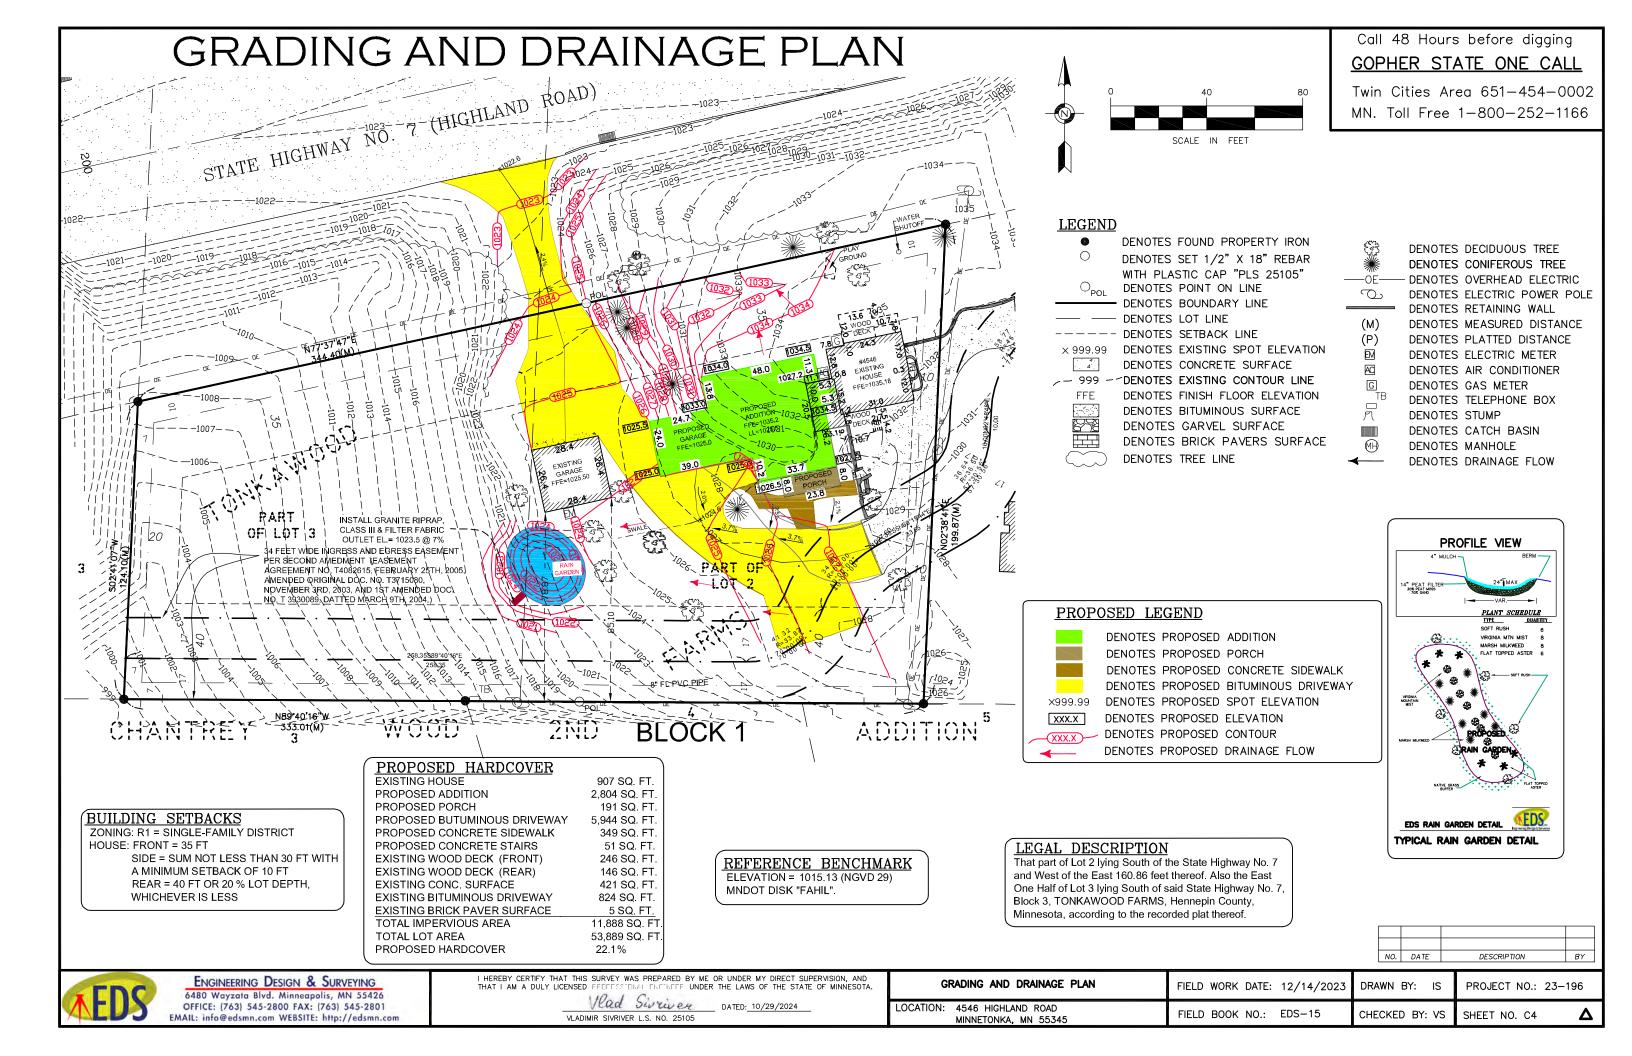

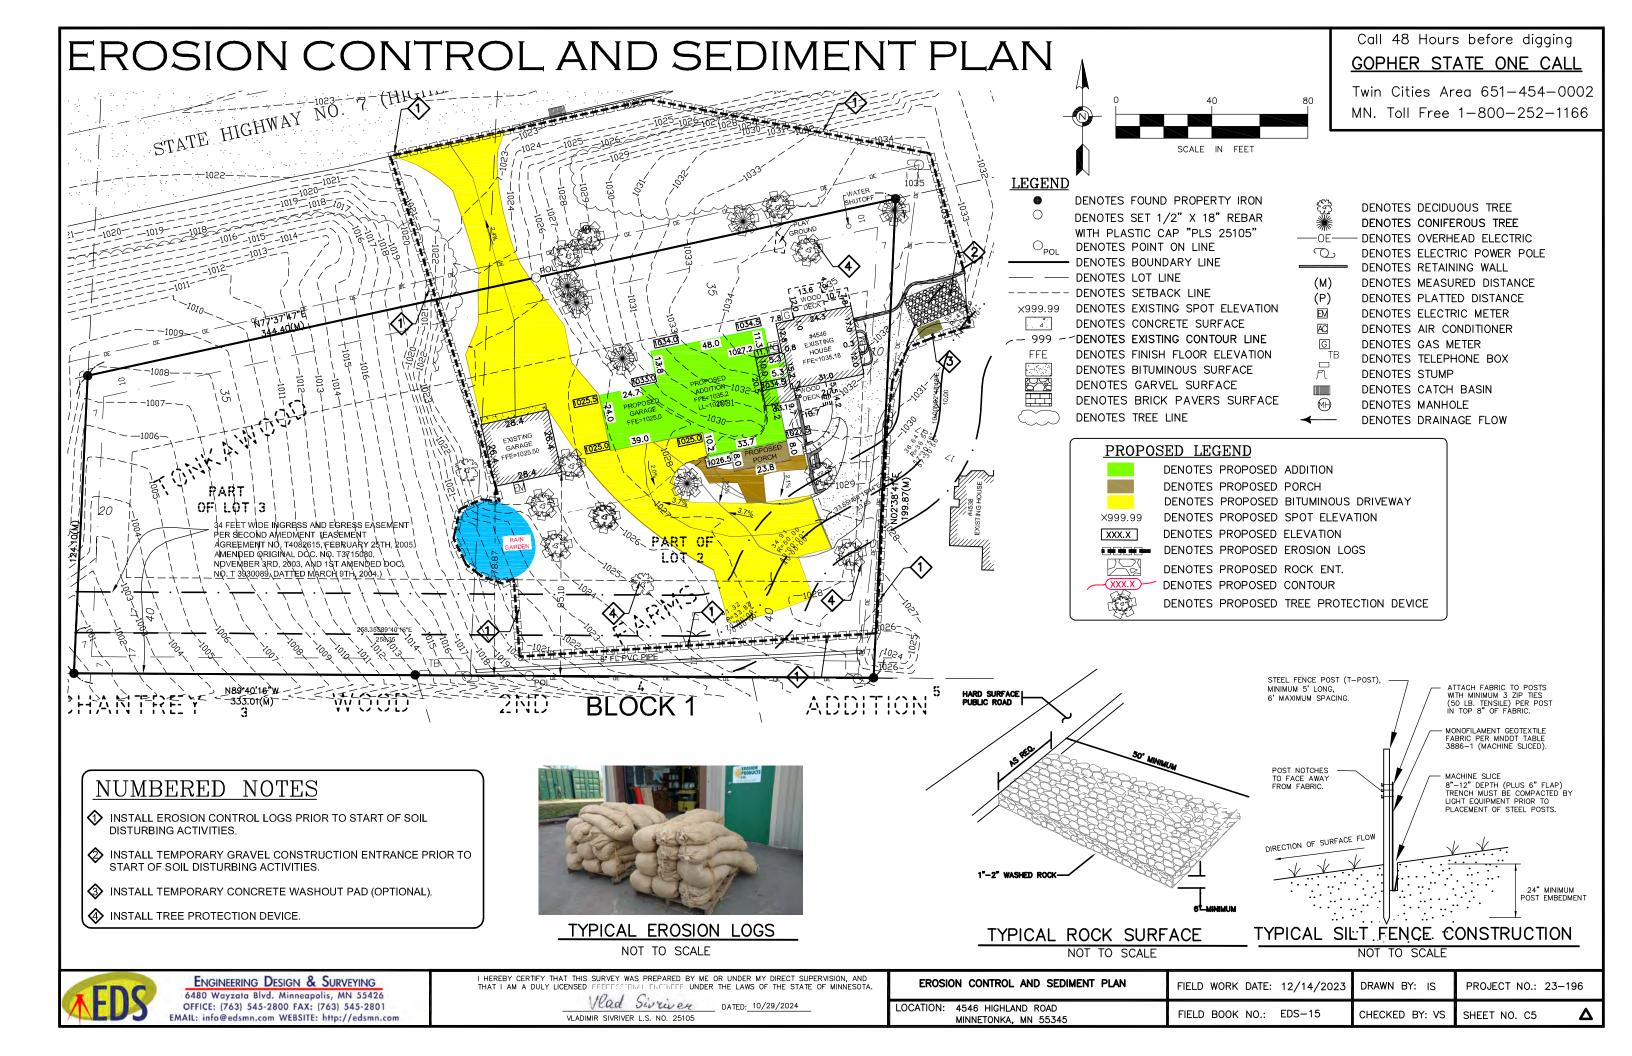

GRADING, DRAINAGE AND EROSION CONTROL NOTES

GRADING NOTES

- 1. CONTRACTOR SHALL FIELD VERIFY THE LOCATIONS AND ELEVATIONS OF EXISTING UTILITIES AND TOPOGRAPHIC FEATURES PRIOR TO START OF SITE GRADING. THE CONTRACTOR SHALL IMMEDIATELY NOTIFY THE PROJECT ENGINEER OF ANY DISCREPANCIES OR VARIATIONS.
- 2. SUITABLE GRADING MATERIAL SHALL CONSIST OF ALL SOIL ENCOUNTERED ON THE SITE WITH EXCEPTION OF TOPSOIL DEBRIS. ORGANIC MATERIAL AND OTHER UNSTABLE MATERIAL. STOCKPILE TOPSOIL AND GRANULAR FILL AT LOCATIONS DIRECTED BY CONTRACTOR.
- 3. SUBGRADE EXCAVATION SHALL BE BACKFILLED IMMEDIATELY AFTER EXCAVATION TO HELP OFFSET ANY STABILITY PROBLEMS DUE TO WATER SEEPAGE OR STEEP SLOPES. WHEN PLACING NEW SURFACE MATERIAL ADJACENT TO EXISTING PAVEMENT. THE EXCAVATION SHALL BE BACKFILLED PROMPTLY TO AVOID UNDERMINING OF THE EXISTING PAVEMENT.
- 4. CONTRACTOR SHALL BE RESPONSIBLE FOR ALL HORIZONTAL AND VERTICAL CONTROL.
- 5. GRADES SHOWN ARE FINISHED GRADES, CONTRACTOR SHALL ROUGH GRADE TO SUBGRADE ELEVATION.
- 6. ALL EXCESS MATERIAL, BITUMINOUS SURFACING, CONCRETE ITEMS, ANY ABANDONED UTILITY ITEMS, AND OTHER UNSTABLE MATERIALS SHALL BECOME THE PROPERTY OF THE CONTRACTOR AND SHALL BE DISPOSED OFF THE CONSTRUCTION SITE
- 8. COMPLETION OF SITE GRADING OPERATIONS SHALL RESULT IN ALL AREAS BEING GRADED TO 'PLAN SUBGRADE ELEVATION'. THE PARKING LOT AND DRIVEWAY AREAS SHALL BE DETERMINED BY REFERRING TO THE SITE PLAN AND PAVEMENT SECTION DETAILS FOR LOCATION AND LIMITS OF BITUMINOUS PAVEMENT SECTIONS.
- 9. THE MINIMUM GRADED SLOPE FROM EDGE OF BUILDING SHALL BE 6 INCHES IN 10 FEET.
- 10. FINISHED GROUND AND SOD ELEVATION ADJACENT TO BUILDING SHALL BE 6" BELOW FLOOR ELEVATION. SLOPE GROUND AWAY FROM BUILDING A MINIMUM OF 6" IN 10 FEET BEYOND 10 FEET REFER TO PLAN GRADES.
- 11. CONTRACTOR IS RESPONSIBLE FOR GRADING AND SLOPING THE FINISHED GROUND SURFACE TO PROVIDE SMOOTH & UNIFORM SLOPES. WHICH PROVIDE POSITIVE DRAINAGE AWAY FROM BUILDINGS AND PREVENT PONDING IN LOWER AREAS. CONTACT ENGINEER IF FIELD ADJUSTMENTS TO GRADING PLANS ARE REQUIRED.
- 12. CONTRACTOR SHALL REMOVE ONLY THOSE TREES MARKED IN THE FIELD VERIFY WITH ENGINEER PRIOR TO
- 13. ALL GRADING SHALL BE ACCORDING TO MnDOT 2105.
- 14. EXISTING CURB CUTS SHALL BE REMOVED AND REPLACED WITH CURB AND GUTTER PER CITY STANDARD DETAILS (AND SPECIFICATIONS)

GRADING. TURF ESTABLISHMENT & EROSION CONTROL SPECIFICATIONS

TURF ESTABLISHMENT

ALL TURF ESTABLISHMENT SHALL BE ACCORDING TO MnDOT 2575 AND SHALL TAKE PLACE WITHIN 10 DAYS OF THE COMPLETED GRADING

CONTRACTOR SHALL STRIP, STOCKPILE AND RE-SPREAD SUFFICIENT TOPSOIL TO PROVIDE A MINIMUM 4 INCH DEPTH (COMPACTED) TO ALL DISTURBED AREAS, TO BE SODDED OR SEEDED.

SOD SHALL BE ACCORDING TO MnDOT 3878.

SEED MIX SHALL BE MINDOT 50B AT 100# PER ACRE. DORMANT SEEDING AFTER NOVEMBER 1, AT TWICE THE NORMAL RATE.

MULCH SHALL BE MnDOT TYPE 1. STRAW SHOULD BE SPREAD UNIFORMLY AT A RATE OF 2 TONS PER ACRE AND ANCHORED WITH EITHER NETTING OR A STRAIGHT DISC.

FERTILIZER

TYPE 20-0-10 AT 400# PER ACRE.

ALL GRADING SHALL BE ACCORDING TO MnDOT 2105.

SEDIMENT & EROSION CONTROL NOTES

- 1. LARRY LOUSIANA IS RESPONSIBLE FOR THE CLEANLINESS OF THE SITE AND THE MAINTENANCE OF THE EROSION AND SEDIMENT CONTROLS AND CAN BE REACHED AT 612-999-5486.
- 2. THE STREET WILL BE SWEPT CLEAN BEFORE THE END OF EACH DAY OF ACTIVE CONSTRUCTION, WHEN SEDIMENT IS TRACKED INTO THE STREET.
- 3. AREAS WITH SLOPES GREATER THAN 3 TO 1 AND AREAS NEXT TO WETLANDS/WATERBODIES GRADED OR EXPOSED DURING CONSTRUCTION SHALL BE PROTECTED WITH TEMPORARY VEGETATION, MULCHING, OR OTHER MEANS AS SOON AS PRACTICAL.
- 4. ALL EXPOSED SOIL AREAS WILL BE STABILIZED AS SOON AS PRACTICAL. UNWORKED SOILS THAT REMAIN EXPOSED AND NOT IN USE FOR LONGER THAN 14 DAYS WILL BE COVERED WITH TEMPORARY SEED (GRASS, OATS, OR WHEAT).
- 5. NO CONCRETE WASHOUT SHALL OCCUR ON SITE UNLESS IT IS DONE WITH AN APPROVED MINNESOTA POLLUTION CONTROL AGENCY (MPCA) DEVICE OR STANDARD.
- 6. STOCKPILES SHALL BE SURROUNDED WITH ADEQUATE PERIMETER CONTROL TO PREVENT SEDIMENTATION AND EROSION.
- 7. INLET PROTECTION FOR ALL STORM SEWER INLETS DOWNSTREAM OF THE SITE WITHIN ONE BLOCK OR AS DIRECTED BY THE CITY.
- 8. SITE SHALL BE KEPT CLEAN AT ALL TIMES AND REFUSE PROPERLY CONTROLLED.
- 9. TEMPORARY PUMPING SHALL NOT BE PERMITTED WITHOUT THE USE OF AN APPROVED MINNESOTA POLLUTION CONTROL AGENCY (MPCA) DEVICE OR STANDARD.
- 10. SOIL COMPACTION SHALL BE MINIMIZED; AREAS OF COMPACTED SOIL WILL BE REMOVED OR LOOSENED VIA TILLING TO A DEPTH OF NO LESS THAN 6-INCHES.
- 11. THE CONTRACTOR SHALL INSPECT ON A WEEKLY BASIS AND AFTER ANY RAINFALL GREATER THAN 1" ALL EROSION CONTROL DEVICES AND MAKE ANY REPAIRS IMMEDIATELY. AN INSPECTION LOG SHALL BE KEPT ON SITE DETAILING THESE INSPECTIONS AND REPAIRS PERFORMED.

GENERAL NOTES


- 1. ALL EROSION CONTROL MEASURES MUST BE INSTALLED AT THE INITIAL STAGES OF CONSTRUCTION AND MAINTAINED UNTIL ALL AREAS ALTERED HAVE BEEN RESTORED.
- 2. ALL REAR YARD AREAS OF LOTS AT SETBACK LINE ARE TO BE MULCHED AND SEEDED WITHIN 14 DAYS OF GRADING BY GRADING CONTRACTOR. ALL AREAS BETWEEN THE CURB AND SETBACK LINE ARE TO BE MULCHED AND SEEDED WITHIN 14 DAYS OF PRIVATE UTILITY INSTALLATION BY THE UTILITY CONTRACTOR.
- 3. STREET SWEEPING MUST BE UNDERTAKEN ON AN AS-NEEDED BASIS.
- 4. PERFORM SEEDING FOR FINAL STABILIZATION OF DISTURBED AREA AS FOLLOWS: a. REPLACE TOPSOIL TO PROVIDE A UNIFORM THICKNESS. LOOSEN TOPSOIL TO MINIMUM
- b. APPLY COMMERCIAL GRADE SLOW RELEASE FERTILIZER PER 1,000 SQUARE FEET.
- c. INCORPORATE FERTILIZER INTO SOIL BY USE OF HARROW OR
- OTHER MEANS TO PLACE FERTILIZER BELOW GROUND LEVEL.










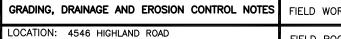

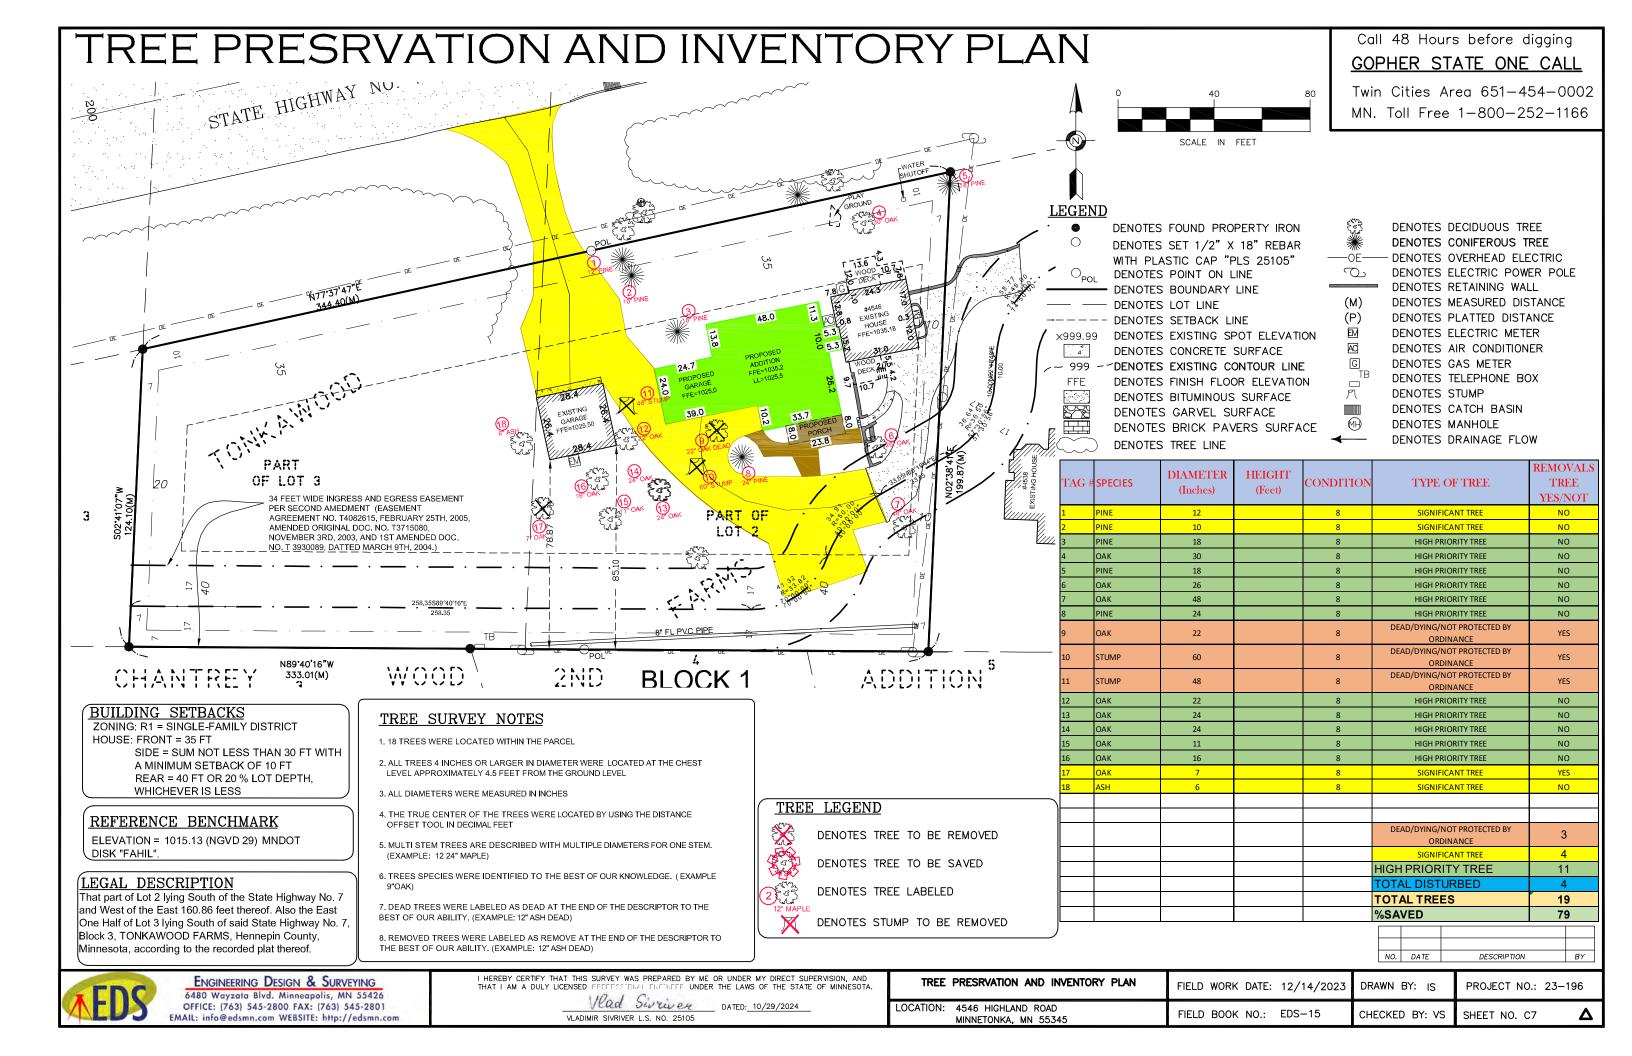

PROPOSED ADDITION FOR:

LOUISIANA RESIDENCE

4546 HIGHLAND ROAD MINNETONKA, MN 55345 HENNEPIN COUNTY

GENERAL NOTES:

GENERAL CONDITIONS:

- A. These drawings are an instrument of service and remain the property of the Architect to use as he sees fit. These drawings shall not be used without the Architect's consent. Drawings shall not be used for issue of building permit unless signed and sealed by the Architect. Drawings shall not be prototyped without authorization from the Architect. Unless stated specifically by letter, these drawings may be used to construct only one of the structure/building delineated herein.
- These drawings represent an overall design concept. They are prepared with the intent to demonstrate the overall design arrangement and method of assembly of the various components. The drawings do not indicate extensive details. The Contractor shall have reviewed these plans, seen the subject property and be capable of executing the detail work necessary to achieve the intended result in a manner consistent with quality workmanship within the region. It is incumbent upon the Contractor to report in writing to the Architect prior to submission of the bid any questionable error or omission in intent or method of construction.
- These contract documents were prepared in accordance with the 2021 International Residential Code Minnesota Edition and the Minnesota State Uniform Construction Code as amended. The contractor shall conform to this and other applicable local, county, state and federal codes, laws, regulations, ordinances and requirements. All construction shall conform to accepted good practice as defined by the latest editions of "The National Building Code," 2021 International Residential Code Minnesota Edition and F.H.A. min. property standards. All are readily available to the trades.
- These contract documents were prepared to comply with the 2021 IECC
- Sleeping room windows shall comply with the requirements of the 2021 International Residential Code Minnesota Edition Section R310, Emergency Escape and Rescue Openings. It is understood that the Architect will not be responsible for any additional cost because of conditions uncovered during construction. These drawings are prepared based upon information supplied by the Owner
- Modifications to these plans by the Owner or Contractor shall not be made without written permission by the Architect. A copy of such changes shall be filed with the construction official. Any modifications made
- without the Architect's written permission will be the sole responsibility of the party enacting such modifications. The Owner and Contractor shall hold harmless the Architect from and against all claims, damages, losses and expenses including legal fees arising out of or resulting from the performance of the work by the
- Construction shown and specified shall conform to all applicable building codes. Where local codes conflict with these drawings, code requirements take precedence. It is assumed that when a building permit is issued by the building inspector, that he has thoroughly examined the drawings and specifications according to the 2021 International Residential Code Minnesota
- Edition requirements. Any changes, additions, etc., made by any party other than the Architect during construction shall be the responsibility of the person making such changes. The following, unless provided for in these drawings, are to be furnished by the Owner:
 - Site grading, soil bearing capacity, drainage, and utilities.
 - Selection of interior material finishes, cabinetry and hardware.
 - Standards of quality and acceptable manufacturers for prefabricated items.
- The Contractor shall check and verify all the plans, dimensions and site conditions before proceeding with construction. DO NOT SCALE DRAWINGS. All written dimensions shall govern. Notify Architect of all deviations to the plan before proceeding with the work.
- Contractor or Owner shall obtain all necessary permits from the town and local authorities
- All Contractors to provide all necessary barricades and safety precautions and to strictly adhere to local, state and O.S.H.A. safety requirements.

ATTIC (HABITABLE WITH LIMITED STORAGE)

LIVE LOAD

LIVE LOAD

TOTAL LOAD

TOTAL LOAD

- All Contractors shall maintain Contractor's liability, property damage insurance and workman's compensations insurance to fully protect the Contractor and Owner against any claims. The Contractor shall furnish to the Owner certificates that these policies are in effect.
- The Contractors shall take necessary steps to protect the work and all materials and supplies on the construction site against loss or damage from fire, vandalism and malicious mischief at all times. The Architect has prepared these drawings based on discussions with the Owners and the Architect's own knowledge of construction techniques and building codes. It is incumbent upon the Owner to review the
- final plans to insure his intent has been met and to notify the Architect immediately (before commencing construction) of any changes he desires. All Contractors and Subcontractors are responsible for adhering to the requirements as spelled out in these notes. All parties must carefully study all notes for items which may pertain to their trades. Failure to read the notes does not permit the Contractor to deviate from their requirements. These specifications are intended to supplement the working drawings, which together are to be used for performing the work.
- Where the specifications disagree with the drawings, the drawings shall supercede. All Contractors and Subcontractors on this project shall be responsible for the proper performance of their work, coordination with other trades, methods, safety and security on the job site. The Architectural office and its agents and employees are not responsible or liable for the above and shall be held harmless and indemnified by all Contractors and Subcontractors from any and all claims, losses, suits and legal action
- whatsoever arising from the performance of the work on this project. All materials and equipment shall be approved for use as required by governing Municipal, State and/or Federal agencies and shall bear all required conditions. All existing conditions and dimensions shall be verified by the contractor prior to the start of construction. The contractor shall report in writing any discrepancies to the Architect immediately upon discovery of such conditions.

JOINT DESCRIPTION

RAFTER TO TOP PLATE (TOE-NAILED)

ABBREVIATIONS:

A.F.F. ABOVE FINISHED FLOOR AL ALUMINUM

JT JOINT

LT LIGHT

JST JOISTS

MAX MAXIMUM

MIN MINIMUM

MECH MECHANICAL

N/A NOT APPLICABLE

NTS NOT TO SCALE

O.C. ON CENTER

OPNG OPENING

PLYWD PLYWOOD

REF REFERENCE

RM ROOM

REQ'D REQUIRED

RR ROOF RAFTERS

RO ROUGH OPENING

STRUCT STRUCTURE

T.O.FTG TOP OF FOOTING

U.N.O. UNLESS NOTED OTHERWISE

T.O.S. TOP OF STEEL

W.C. WATER CLOSET

W.I.C. WALK IN CLOSET

W.W.M. WOVEN WIRE MESH

SF SQUARE FEET

SIM SIMILAR

SHR SHEAR

STL STEEL

THK THICK

T.O. TOP OF

VERT VERTICAL

W/ WITH

W/O WITHOUT

WD WOOD

WDW WINDOW

QC QUALITY CONTROL

N.I.C. NOT IN CONTRACT

OSB ORIENTED STRAND BOARD

M.O. MASONRY OPENING

- BD BOARD B.F.E. BASE FLOOD ELEVATION BLDG BUILDING BM BEAM BOT BOTTOM
- B.O.F. BOTTOM OF FOOTING BRG BEARING BSMT BASEMENT C.J. CEILING JOISTS
- CLG CEILING CLR CLEAR CMU CONCRETE MASONRY UNIT C.O. CLEAN OUT COMP COMPOSITE
- CONC CONCRETE CONT CONTINUOUS DIA DIAMETER DIM DIMENSION
- DIST DISTANCE DN DOWN EA EACH **ELEV ELEVATION** EXST'G EXISTING
- EXT EXTERIOR F.F.E. FINISHED FLOOR ELEVATION F.J. FLOOR JOISTS FLR FLOOR FT FOOT/FEET
- FTG FOOTING GALV GALVANIZED GYP GYPSUM
- HDR HEADER HM HOLLOW METAL HVAC HEATING VENTILATION & AIR
- HORZ HORIZONTAL INSUL INSULATION

PROJECT INFORMATION:

SITE INFORMATION: 4546 HIGHLAND ROAD MINNETONKA, MN 55345

HENNEPIN COUNTY

AREA INFORMATION: FIRST FLOOR

| EXIST LOWER LEVEL | 907 SF |
|----------------------|---------|
| | 1815 SF |
| ADDITION | |
| GARAGE | 969 SF |
| PROPOSED LOWER LEVEL | 1847 SF |
| FIRST FLOOR | 2111 SF |
| SECOND FLOOR | 2049 SF |

8791 SF **BUILDING INFORMATION:**

TYPE OF CONSTRUCTION: V-B OCCUPANCY USE GROUP: R-5

BUILDING CODE INFORMATION:

2020 MINNESOTA CONSERVATION CODE FOR EXISTING BUILDINGS

- 2020 MINNESOTA RESIDENTIAL CODE
- 2020 MINNESOTA ENERGY CODE
- 2020 MINNESOTA MECHANICAL AND FUEL GAS CODE
- 2020 MINNESOTA PLUMBING CODE
- MINNESOTA ELECTRICAL CODE

DRAWING LIST:

- **COVER SHEET**
- **AD-101 DEMOLITION PLANS**
- FOUNDATION PLAN
- A-101a ICF FOUNDATION WALL PLAN LOWER LEVEL PLAN
- FIRST FLOOR PLAN
- SECOND FLOOR PLAN
- **ROOF PLAN**
- **EXTERIOR ELEVATIONS**
- **EXTERIOR ELEVATIONS**
- **BUILDING SECTIONS**
- LOWER LEVEL ELECTRICAL PLAN
- FIRST FLOOR ELECTRICAL PLAN
- SECOND FLOOR ELECTRICAL PLAN

DENC

STUDIOS

ARCHITECTURE

E: ANNA@R2STUDIOSARCHITECTURE.COM

ANNA RYNDERS, RA

I HEREBY CERTIFY THAT THIS PLAN, SPECIFICATION, OR REPORT WAS PREPARED BY ME

SUPERVISION AND THAT I AM A DULY LICENSED ARCHITECT UNDER THE LAWS OF THE STATE

SIGNATURE: <u>Arra Lyndus</u> TYPED NAME: <u>ANNA RYNDERS</u> DATE: 05/31/24 LICENSE: 60582

1261 BRIAR STREET WAYZATA, MN 55391

P: (612) 619-5110

OR UNDER MY DIRECT

OF MINNESOTA.

COVER SHEET

JOB #: 2022 DWN: AR CHK: AR

DATE: 10/08/2022

NAILING SCHEDULE:


OF NAILS | NAIL SPACING

| - 1 | TOUT TELL TO TOUT ENTE (TOE TOUTED) | (0) od OOM. | I LIVIVII ILIV |
|-----|---|---------------------|-----------------|
| | CEILING JOIST TO TOP PLATE (TOE-NAILED) | (3) 8d COM. | PER JOIST |
| | CEILING JOIST TO PARALLEL RAFTER (FACE-NAILED) | (5) 16d COM. | EACH LAP |
| | CEILING JOIST LAPS OVER PARTITIONS (FACE-NAILED) | (5) 16d COM. | EACH LAP |
| | COLLAR TIE TO RAFTER (FACE-NAILED) | (3) 10d COM. | EACH END |
| | RAFTER TIE TO RAFTER (FACE-NAILED) | (8) 10d COM. | EACH END |
| | BLOCKING TO RAFTER (TOE-NAILED) | (2) 8d COM. | EACH END |
| | RIM BOARD TO RAFTER (END-NAILED) | (2) 16d | EACH END |
| | TOP PLATE TO TOP PLATE (FACE-NAILED) MIN. SPLICE LENGTH 3' | (2) 16d | PER FOOT |
| | DOUBLE TOP PLATES @ INTERSECTIONS (FACE-NAILED) | (4) 16d | EACH SIDE JOINT |
| | STUD TO STUD (FACE-NAILED) | (2) 16d | 24" O.C. |
| | HEADER TO HEADER (FACE-NAILED) | (1) 16d | 16" O.C EDGES |
| | TOP OR BOTTOM PLATE TO STUD (TOE-NAILED) | (3) 8d COM. | PER 2X4 STUD |
| | | (3) 16d COM. | PER 2X6 STUD |
| | BOTTOM PLATE TO FLOOR JOIST, TIM JOIST, END JOIST, BLOCKING (FACE NAIL) | (2) 16d | PER FOOT |
| | | (4) 16d | PER FOOT |
| | JOIST TO SILL, TOP PLATE, OR GIRDER (TOE-NAILED) | (4) 8d | PER JOIST |
| | BLOCKING TO JOIST (TOE-NAILED) | (2) 8d | EACH END |
| | BLOCKING TO SILL OR TOP PLATE (TOE-NAILED) | (3) 16d | PER BLOCK |
| | LEDGER STRIP TO BEAM (FACE-NAILED) | (3) 16d | EACH JOIST |
| | JOIST ON LEDGER TO BEAM (TOE-NAILED) | (3) 8d | PER JOIST |
| | RIM JOIST TO JOIST (END-NAILED) | (3) 16d | PER JOIST |
| | RIM JOIST TO SILL OR TOP PLATE (TOE-NAILED) | (2) 16d | PER FOOT |
| | ROOF SHEATHING - 5/8" PLYWOOD | (1) 8d | 6" E / 12" F |
| | CEILING SHEATHING - GYPSUM WALLBOARD | 5d COOLERS | 7" E / 10" F |
| | WALL SHEATHING - 1/2" PLYWOOD* | 8d | 6" E / 12" F |
| | WALL SHEATHING - GYPSUM WALLBOARD | 5d COOLERS | 7" E / 10" F |
| | FLOOR SHEATHING - 3/4" T&G PLYWOOD GLUED & NAILED | 8d | 6" E / 12" F |
| | ROOF TO WALL UPLIFT STRAPS (1-1/4" X 20 GAUGE STRAP) | (5) 8d COM. EA. END | PER MEMBER |
| | WALL TO WALL UPLIFT STRAPS (1-1/4" X 20 GAUGE STRAP) | (4) 8d COM. EA. END | PER MEMBER |
| | WALL TO FOUNDATION UPLIFT STRAPS (1-1/4" X 20 GAUGE STRAP) | (3) 8d COM. EA. END | PER MEMBER |
| | BOTTOM PLATE TO FOUNDATION | 5/8"%C | 48" O.C. |
| | | | |

NOTE: ALL FASTENERS IN CONTACT WITH PRESSURE PRESERVATIVE TREATED

WOOD SHALL BE STAINLESS STEEL OR HOT-DIP GALVANIZED

3D VISUALIZATION:

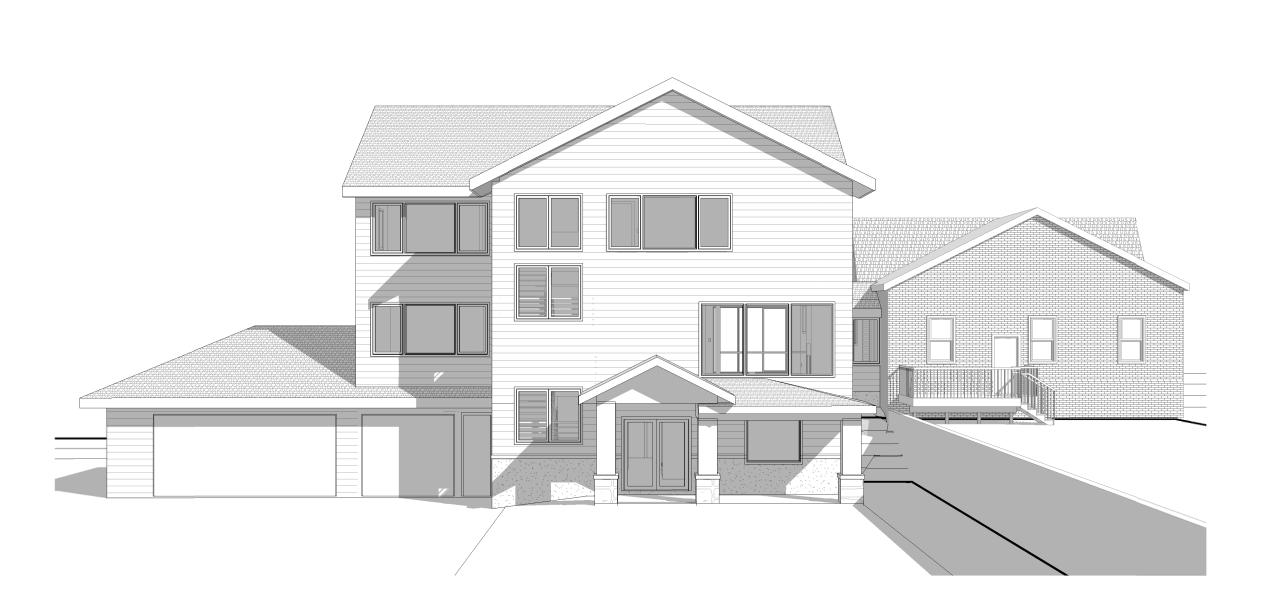

ZONE 1 21.8/-23.8 ZONE 2 23.6/-28.1 ZONE 3 23.6/-28.1 ZONE 4 20.4/-24.2

DESIGN LOADS:

LIVE LOAD

TOTAL LOAD

LIVE LOAD

TOTAL LOAD

ROOF ANGLE 26.5%D<45%D (118 MPH 3-SECOND GUST) IMPORTANT FACTOR 1.0

40 #/SF

30 #/SF

15 #/SF

45 #/SF

1ST FLOOR

2ND FLOOR

WINDOWS TO HAVE DP 50 RATING

ZONE 5 22.6/-26.9


WIND - COMPONENT & CLADDING

NO PROPOSED WORK —

PROPOSED LOWER LEVEL DEMOLITION

PLAN


1/4" = 1'-0"

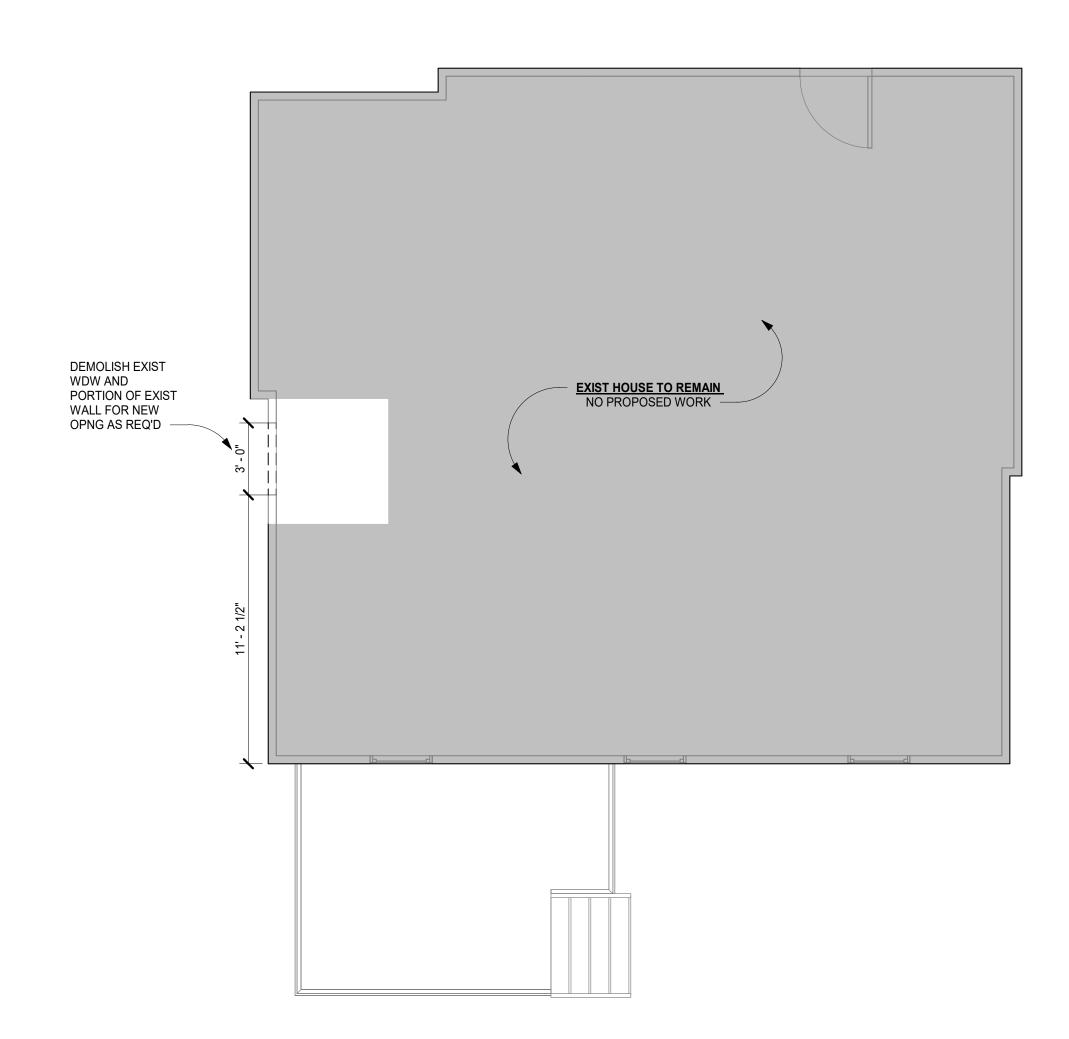

PROPOSED FIRST FLOOR DEMOLITION

PLAN

1/4" = 1'-0"

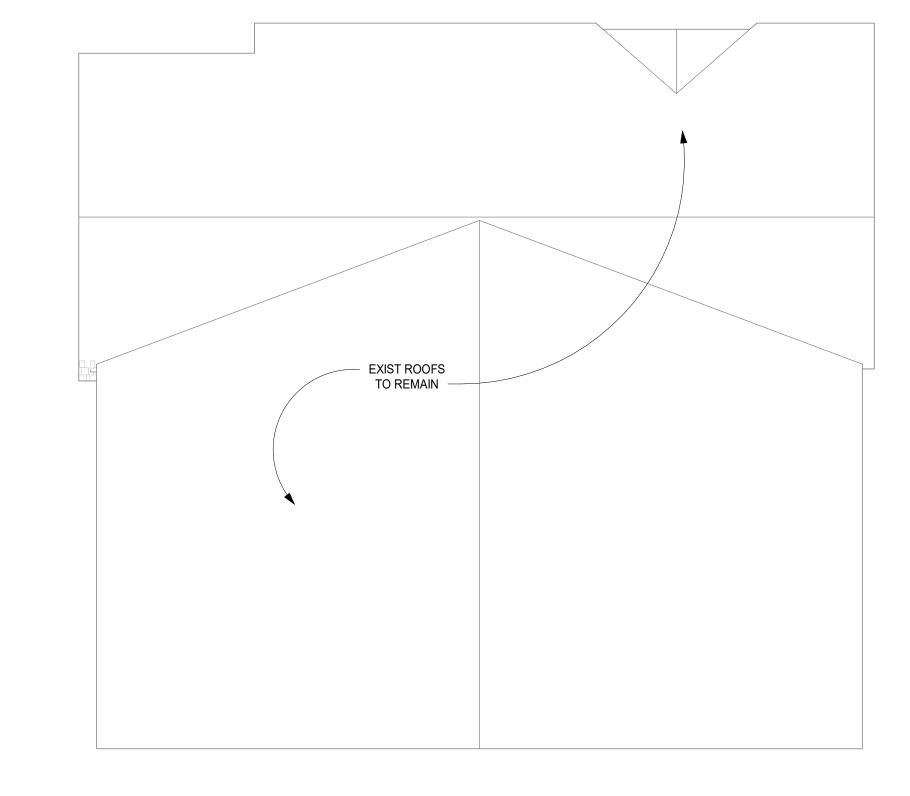

PROPOSED ROOF DEMOLITION PLAN
1/4" = 1'-0"

EXISTING WALL TO REMAIN

WALL TO BE DEMOLISHED

WALL LEGEND

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UNDER THE LAWS OF THE STATE
OF MINNESOTA.

SIGNATURE: <u>Arna fyndus</u> TYPED NAME: <u>ANNA RYNDERS</u> DATE: <u>05/31/24</u> LICENSE: <u>60582</u>

STUDIOS

ARCHITECTURE


1261 BRIAR STREET
WAYZATA, MN 55391
E: ANNA@R2STUDIOSARCHITECTURE.COM
P: (612) 619-5110

ANNA RYNDERS, RA

DENCE

DEMOLITION PLANS

JOB #: 2022 DWN: AR CHK: AR DATE: 10/08/2022 DRAWING NO.

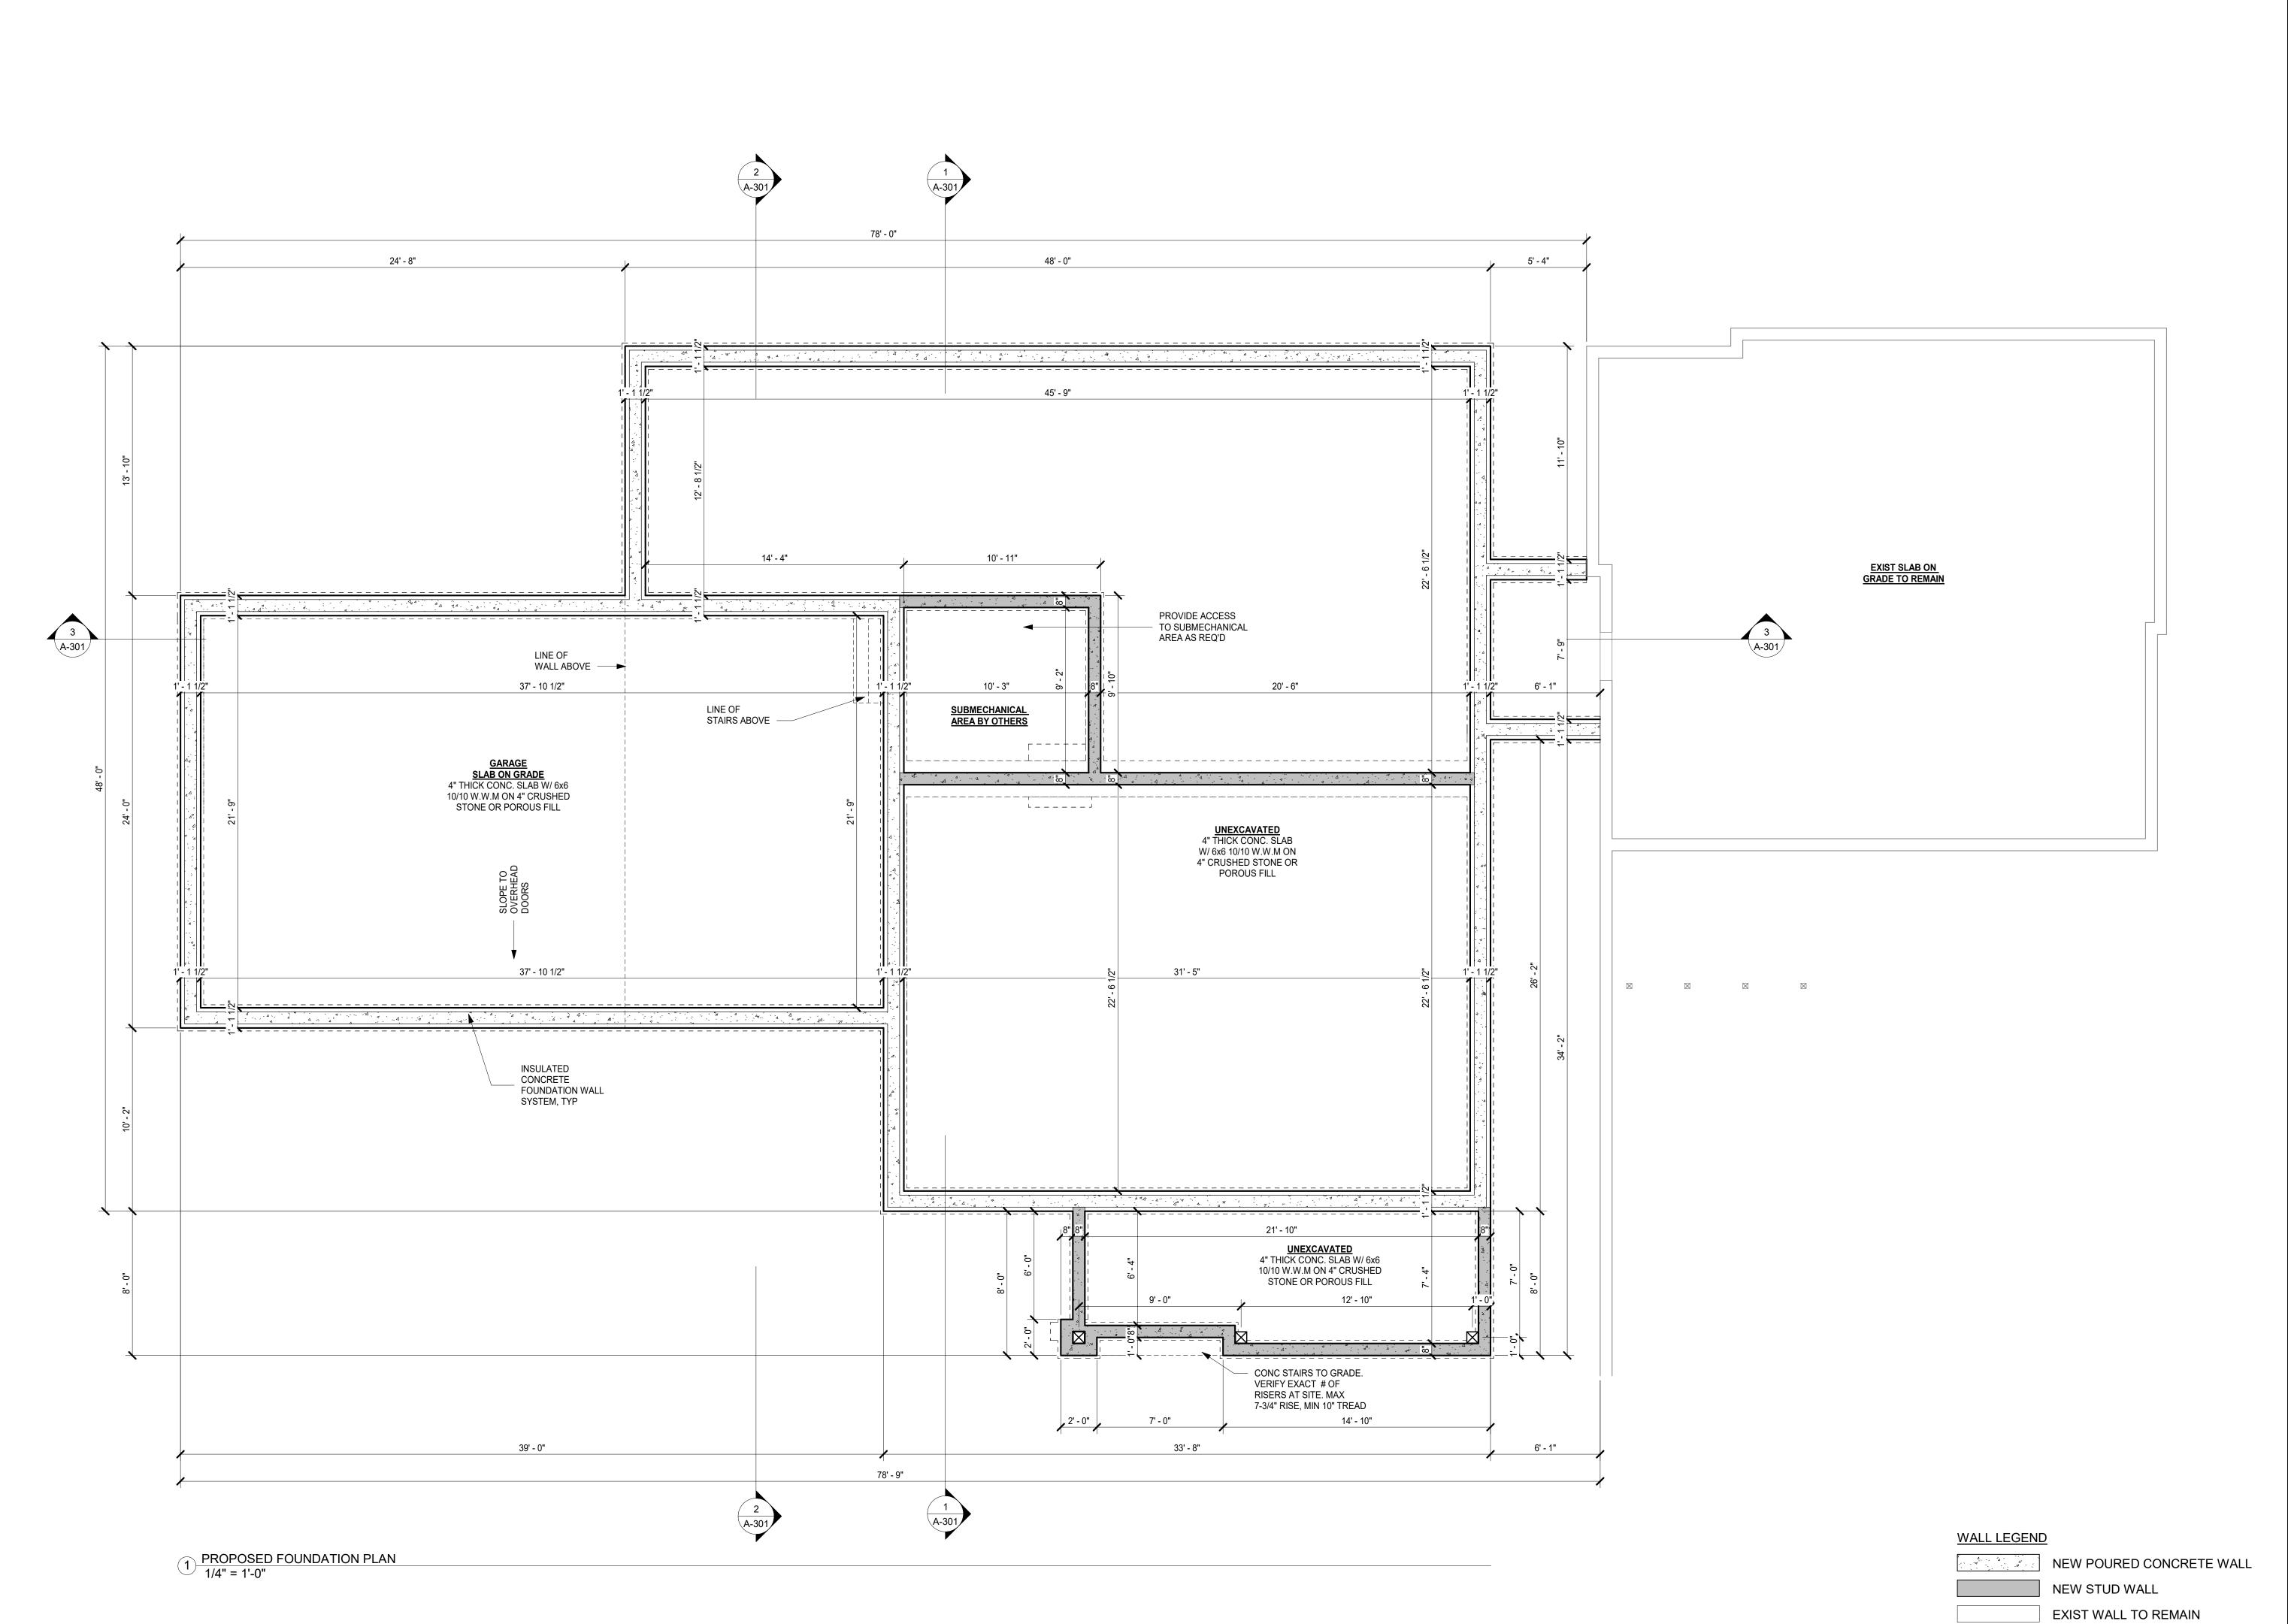

ANNA RYNDERS, RA 1261 BRIAR STREET WAYZATA, MN 55391
E: ANNA@R2STUDIOSARCHITECTURE.COM
P: (612) 619-5110

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DENCE

FOUNDATION PLAN

JOB #: 2022 DWN: AR CHK: AR DATE: 10/08/2022

DRAWING NO.

BEARING WALL ABOVE



ANNA RYNDERS, RA

1261 BRIAR STREET
WAYZATA, MN 55391
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P: (612) 619-5110


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SIGNATURE: <u>Arna Lyndurs</u> TYPED NAME: <u>ANNA RYNDERS</u> DATE: <u>05/31/24</u> LICENSE: <u>60582</u>

DENCE

ICF FOUNDATION WALL PLAN

JOB #: 2022 DWN: AR CHK: AR DATE: 10/08/2022

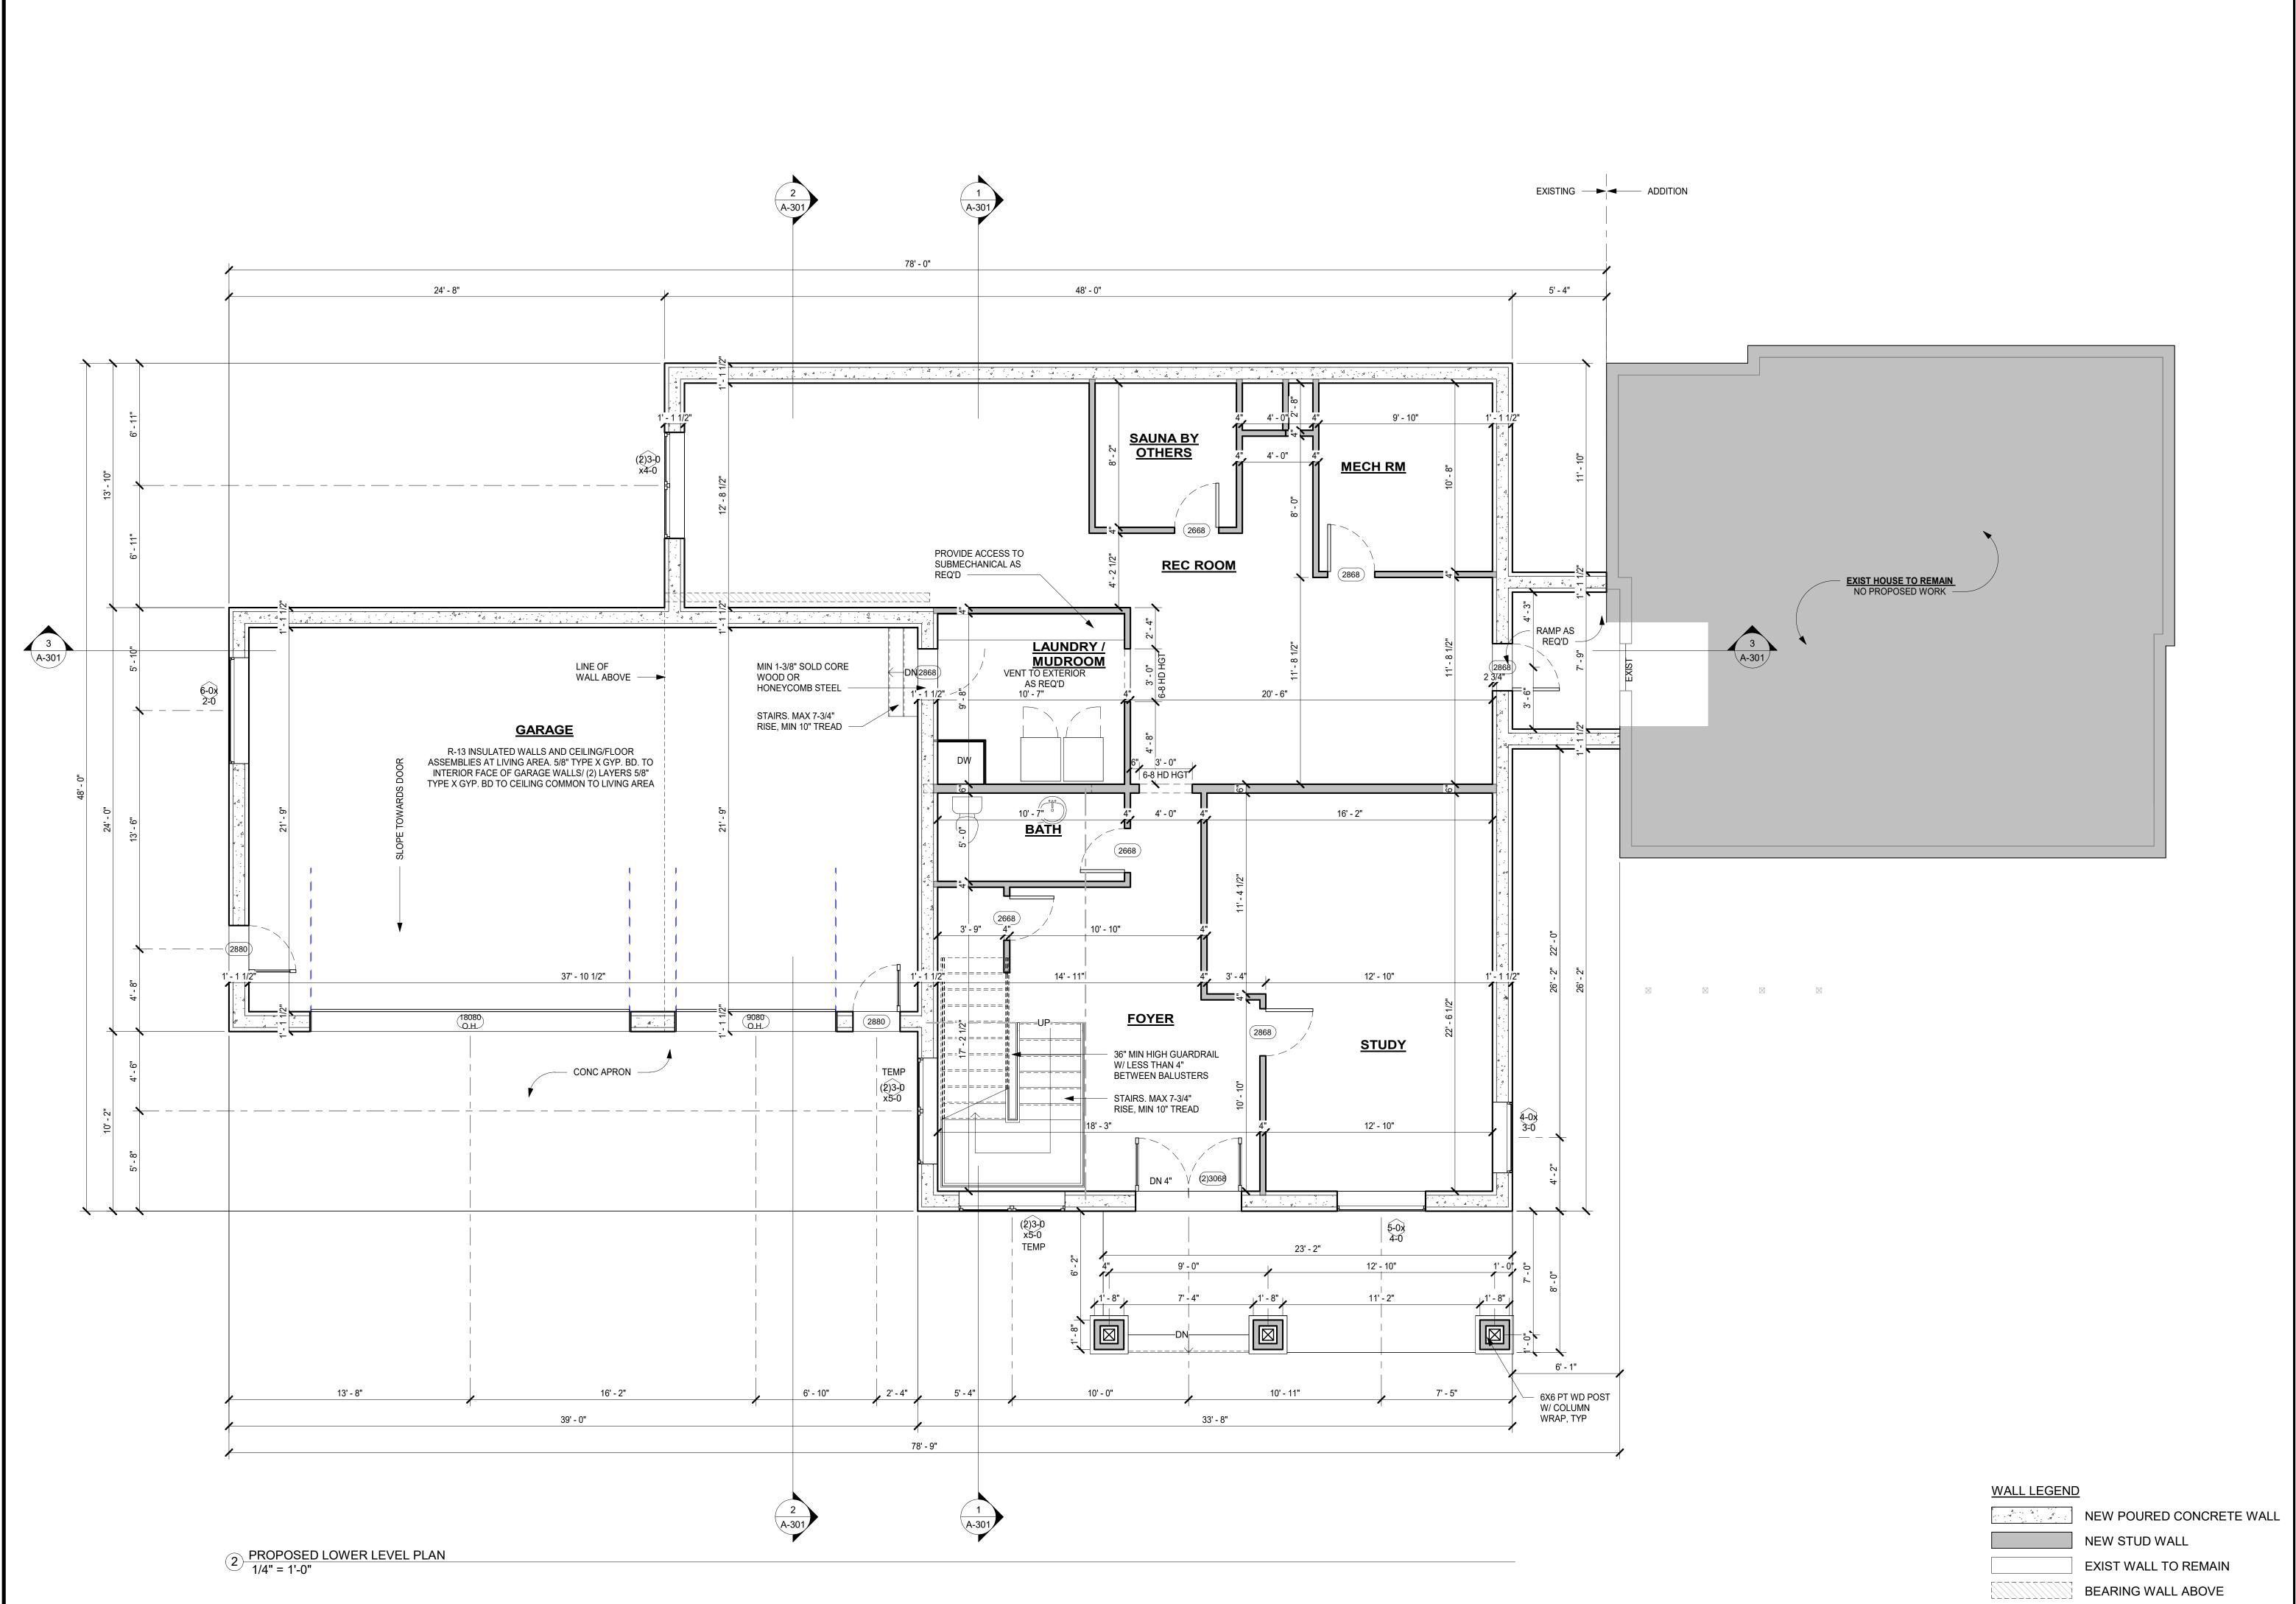

ANNA RYNDERS, RA
1261 BRIAR STREET

WAYZATA, MN 55391
E: ANNA@R2STUDIOSARCHITECTURE.COM
P: (612) 619-5110

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SIGNATURE: <u>Arna Fyndus</u> TYPED NAME: <u>ANNA RYNDERS</u> DATE: <u>05/31/24</u> LICENSE: <u>60582</u>

DITION FOR:

NA RESIDENCE

OUISIANA R

FOR PERMITS: **05/31/2024**V LEGEND

As Per:

LOWER LEVEL PLAN

JOB #: 2022

DWN: AR

CHK: AR

DATE: 10/08/2022

ANNA RYNDERS, RA

1261 BRIAR STREET WAYZATA, MN 55391 E: ANNA@R2STUDIOSARCHITECTURE.COM P: (612) 619-5110

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SIGNATURE: <u>Arra Lynders</u> TYPED NAME: <u>ANNA RYNDERS</u> DATE: <u>05/31/24</u> LICENSE: <u>60582</u>

DENCE

FIRST FLOOR PLAN

JOB #: 2022 DWN: AR CHK: AR DATE: 10/08/2022

DRAWING NO.

WALL LEGEND

NEW FRAMED WALL

EXIST WALL TO REMAIN

PROPOSED BEARING WALL SEE STRUCTURAL

ANNA RYNDERS, RA

1261 BRIAR STREET WAYZATA, MN 55391
E: ANNA@R2STUDIOSARCHITECTURE.COM
P: (612) 619-5110

I HEREBY CERTIFY THAT THIS
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UNDER THE LAWS OF THE STATE OF MINNESOTA.

SIGNATURE: <u>Arra Lynders</u> TYPED NAME: <u>ANNA RYNDERS</u> DATE: <u>05/31/24</u> LICENSE: <u>60582</u>

DENCE

SECOND FLOOR PLAN


JOB #: 2022 DWN: AR CHK: AR DATE: 10/08/2022

DRAWING NO.

1 PROPOSED SECOND FLOOR 1/4" = 1'-0"

WALL LEGEND

NEW FRAMED WALL EXIST WALL TO REMAIN

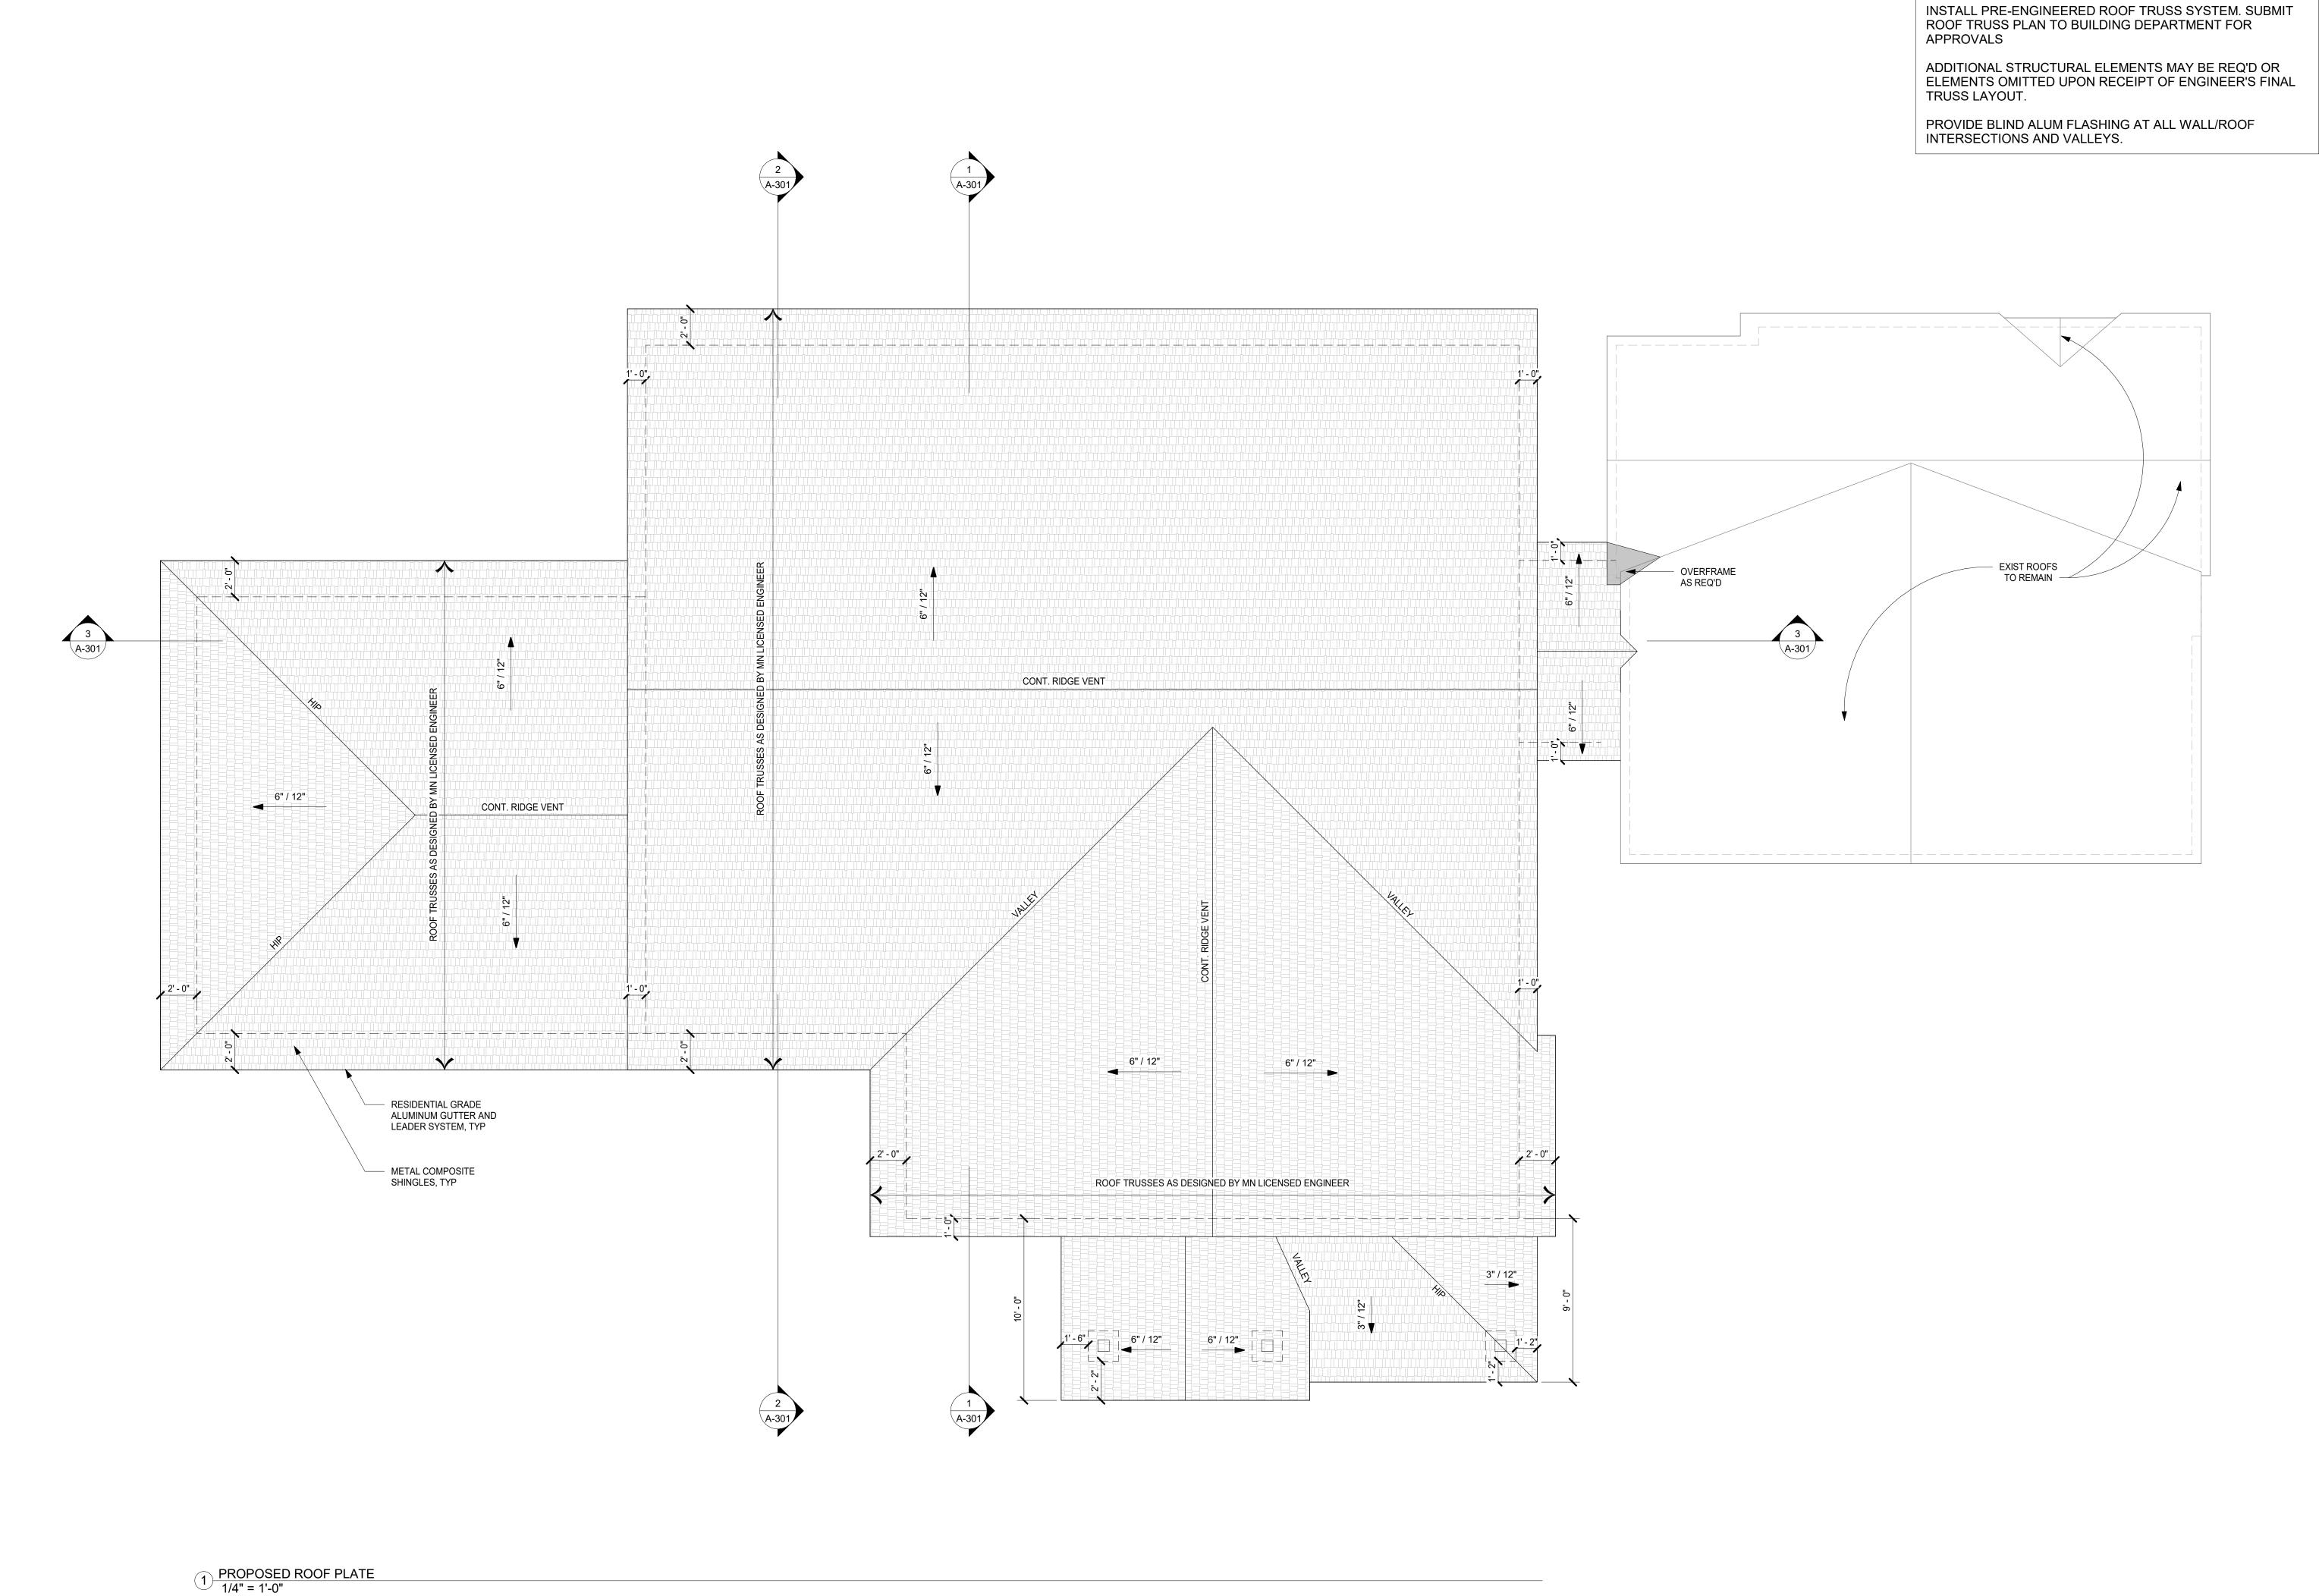

ROOF NOTES:

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A RESIDENCE

LOUISIANA 4546 HIGHLAND RO MINNETONKA, MN &

SSUED FOR PERMITS: 05/31/2024

REVISION LEGEND

Io. Date As Per:

ROOF PLAN

JOB #: 2022

DWN: AR

CHK: AR

DATE: 10/08/2022

DRAWING NO.

A-105

SIDING, AS SELECTED BY OWNER ———


PROPOSED ROOF
19' - 4"

PLATE

PROPOSED
SECOND FLOOR
11' - 4"

PROPOSED FIRST
FLOOR PLATE
10' - 0"

EXIST FIRST
FLOOR
0' - 0"
PROPOSED T.O.
ICF
-1' - 4"

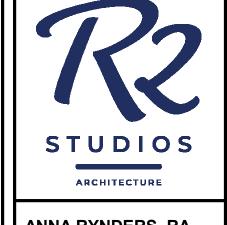

ADDITION — ► ■ EXISTING

- PT WD POST W/ COLUMN WRAP, TYP

-PROPOSED T.O.-- - - - - ICF -1' - 4"

PROPOSED T.O.

SLAB
-9' - 6"

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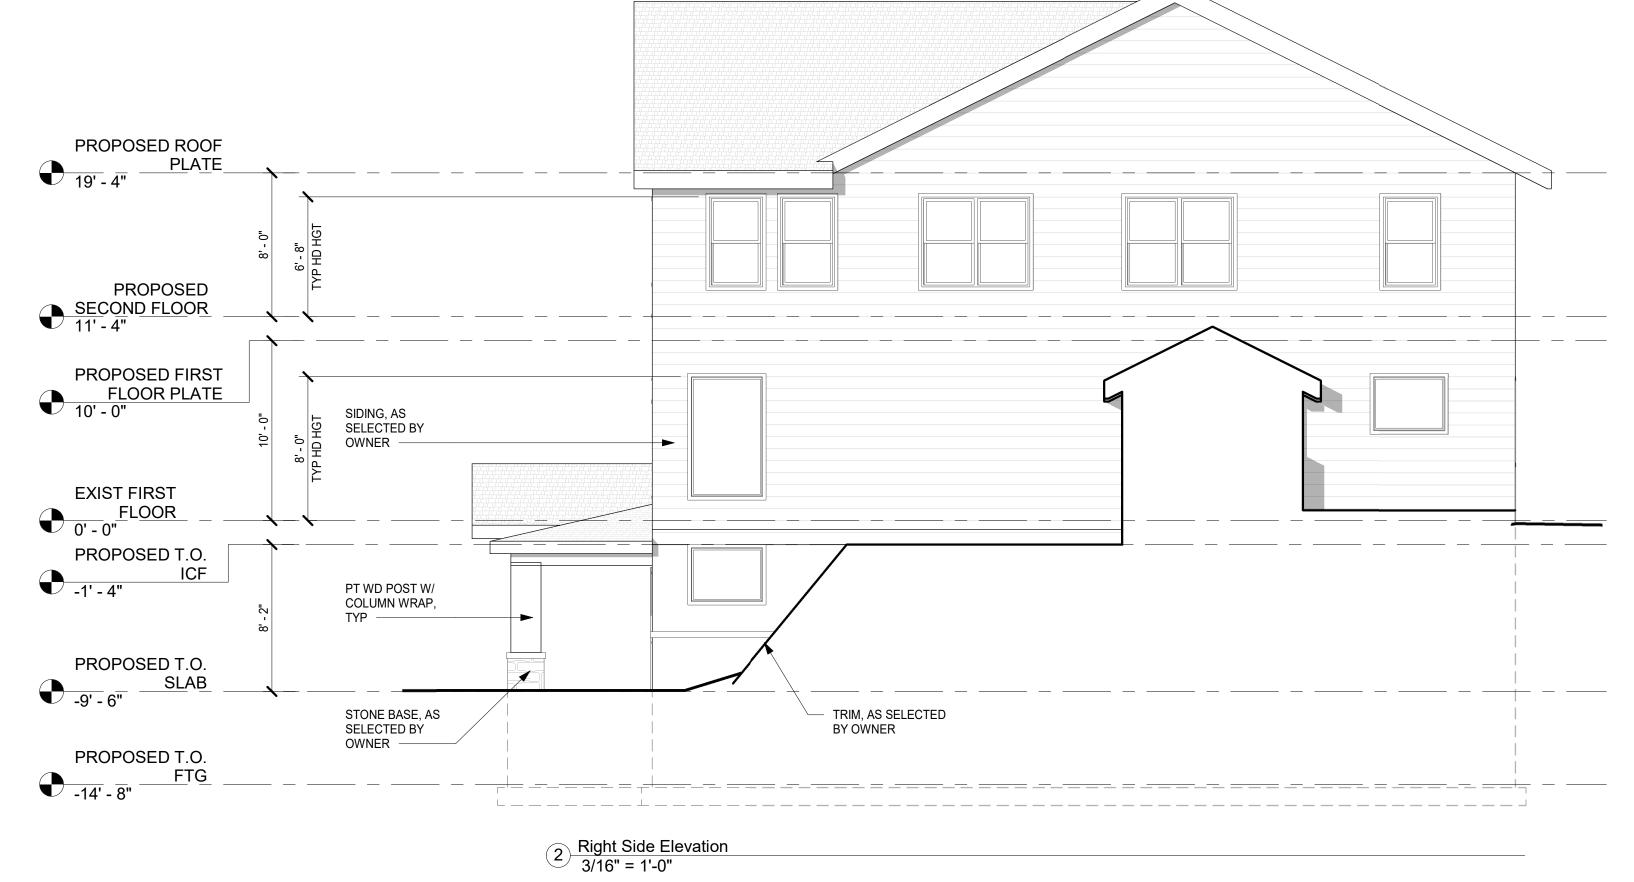
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SIGNATURE: <u>Arra fyndus</u> TYPED NAME: <u>ANNA RYNDERS</u> DATE: <u>05/31/24</u> LICENSE: <u>60582</u>

DENCE

EXTERIOR ELEVATIONS

JOB #: 2022 DWN: AR CHK: AR DATE: 10/08/2022





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NA RESIDENCE

LOUISIANA RES


SION LEGEND
ate As Per:

EXTERIOR ELEVATIONS

JOB #: 2022 DWN: AR CHK: AR DATE: 10/08/2022

DRAWING NO.

\-202

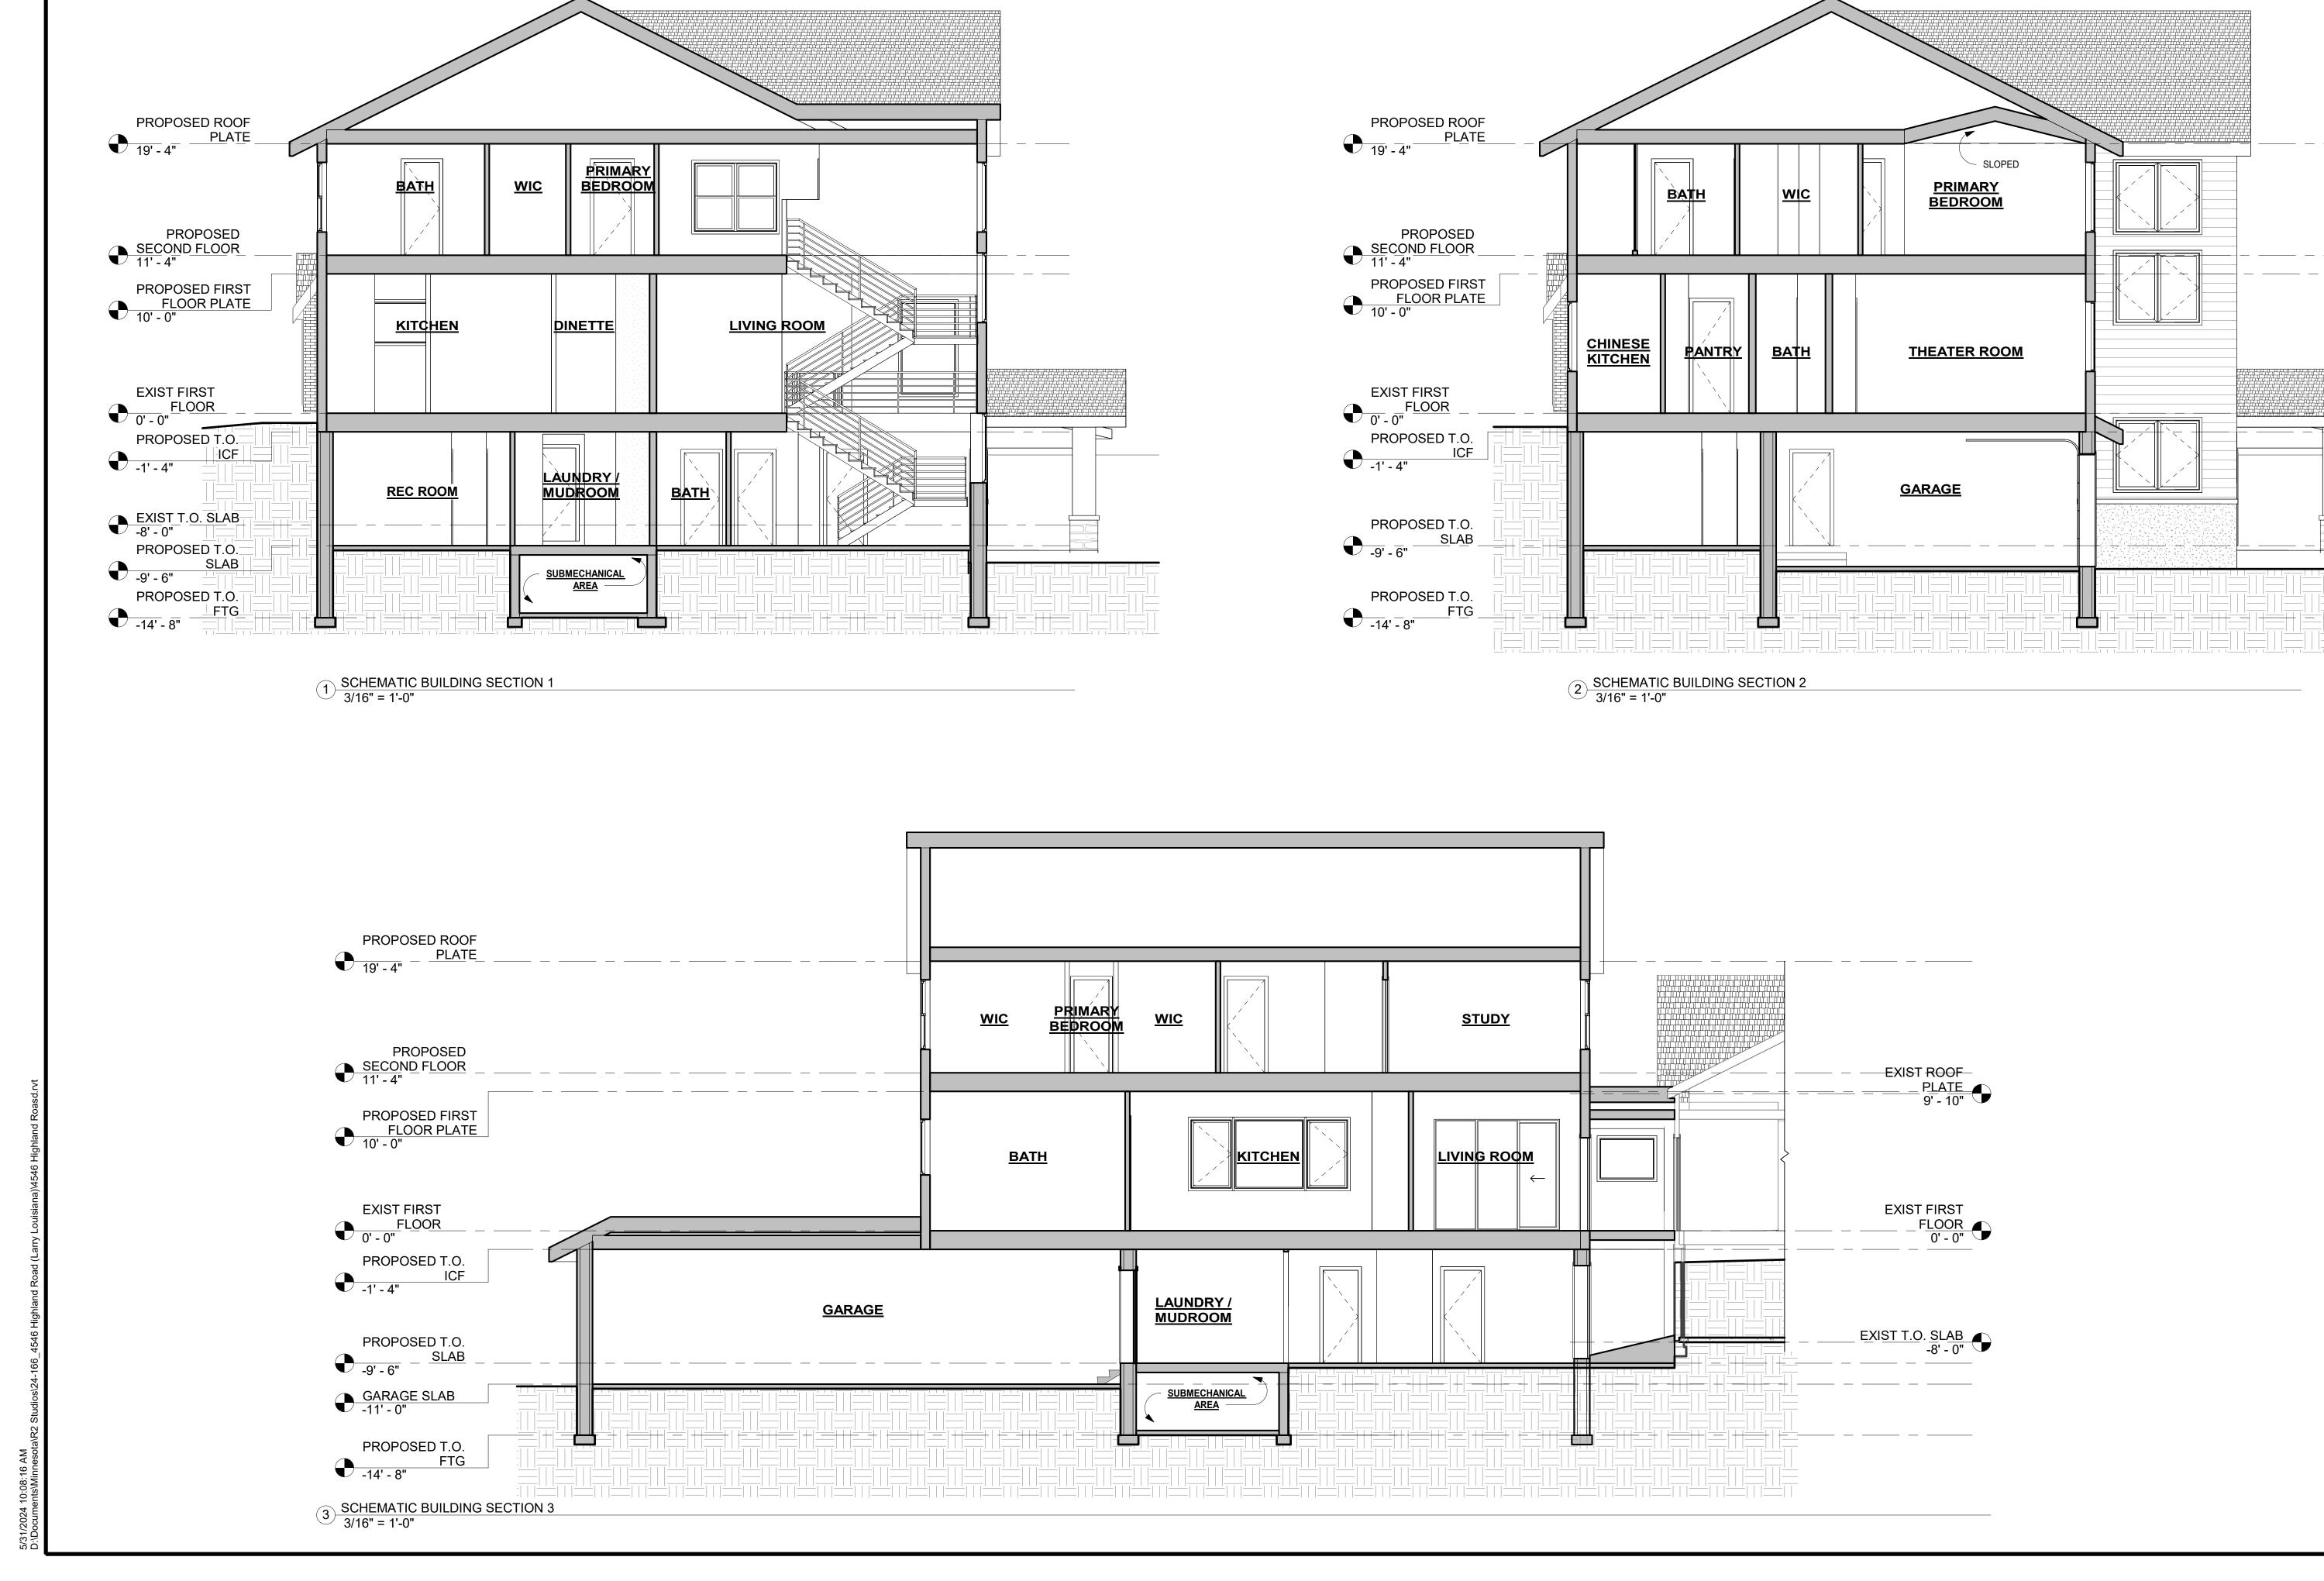

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4546 HIGHLAND ROAD
MINNETONKA, MN 55345 **BUILDING SECTIONS** JOB #: 2022 DWN: AR CHK: AR DATE: 10/08/2022 DRAWING NO.

STUDIOS

ARCHITECTURE

ANNA RYNDERS, RA

ELECTRICAL LAYOUT IS SUGGESTED ONLY- CONTRACTOR SHALL COORDINATE EXACT LAYOUT WITH OWNER PRIOR TO BEGINNING NEW WORK

ELECTRICAL CONTRACTOR SHALL COORDINATE W/ OWNER FOR LOCATIONS OF POSSIBLE TELEPHONE JACKS, COAXIAL CABLE OUTLETS, CATEGORY 5 WIRING, ALARM SYSTEMS, ETC NOT SPECIFIED ON PLANS COORDINATE WITH HVAC CONTRACTOR FOR POWER

WALL MOUNTED LIGHT FIXTURE (WP= WEATHERPROOF) PENDANT LIGHT FIXTURE HOOK-UP TO NEW AIR CONDITIONING CONDENSING UNITS.

RECESSED LIGHT FIXTURE

ELECTRICAL LEGEND

SURFACE FLUORESCENT FIXTURE

GFCI -DUPLEX WALL RECEPTACLE DUPLEX WALL RECEPTACLE

CEILING MOUNTED LIGHT FIXTURE AND/ OR CEILING FAN

SMOKE DETECTOR- DIRECT WIRED


COMBINATION SMOKE DETECTOR CARBON MONOXIDE DETECTOR COMBINATION SMOKE DETECTOR /

OO EXHAUST FAN -DUCT TO EXTERIOR

COMBINATION EXHAUST FAN / LIGHT FIXTURE- DUCT TO EXTERIOR

SINGLE POLE WALL SWITCH

THREE WAY WALL SWITCH

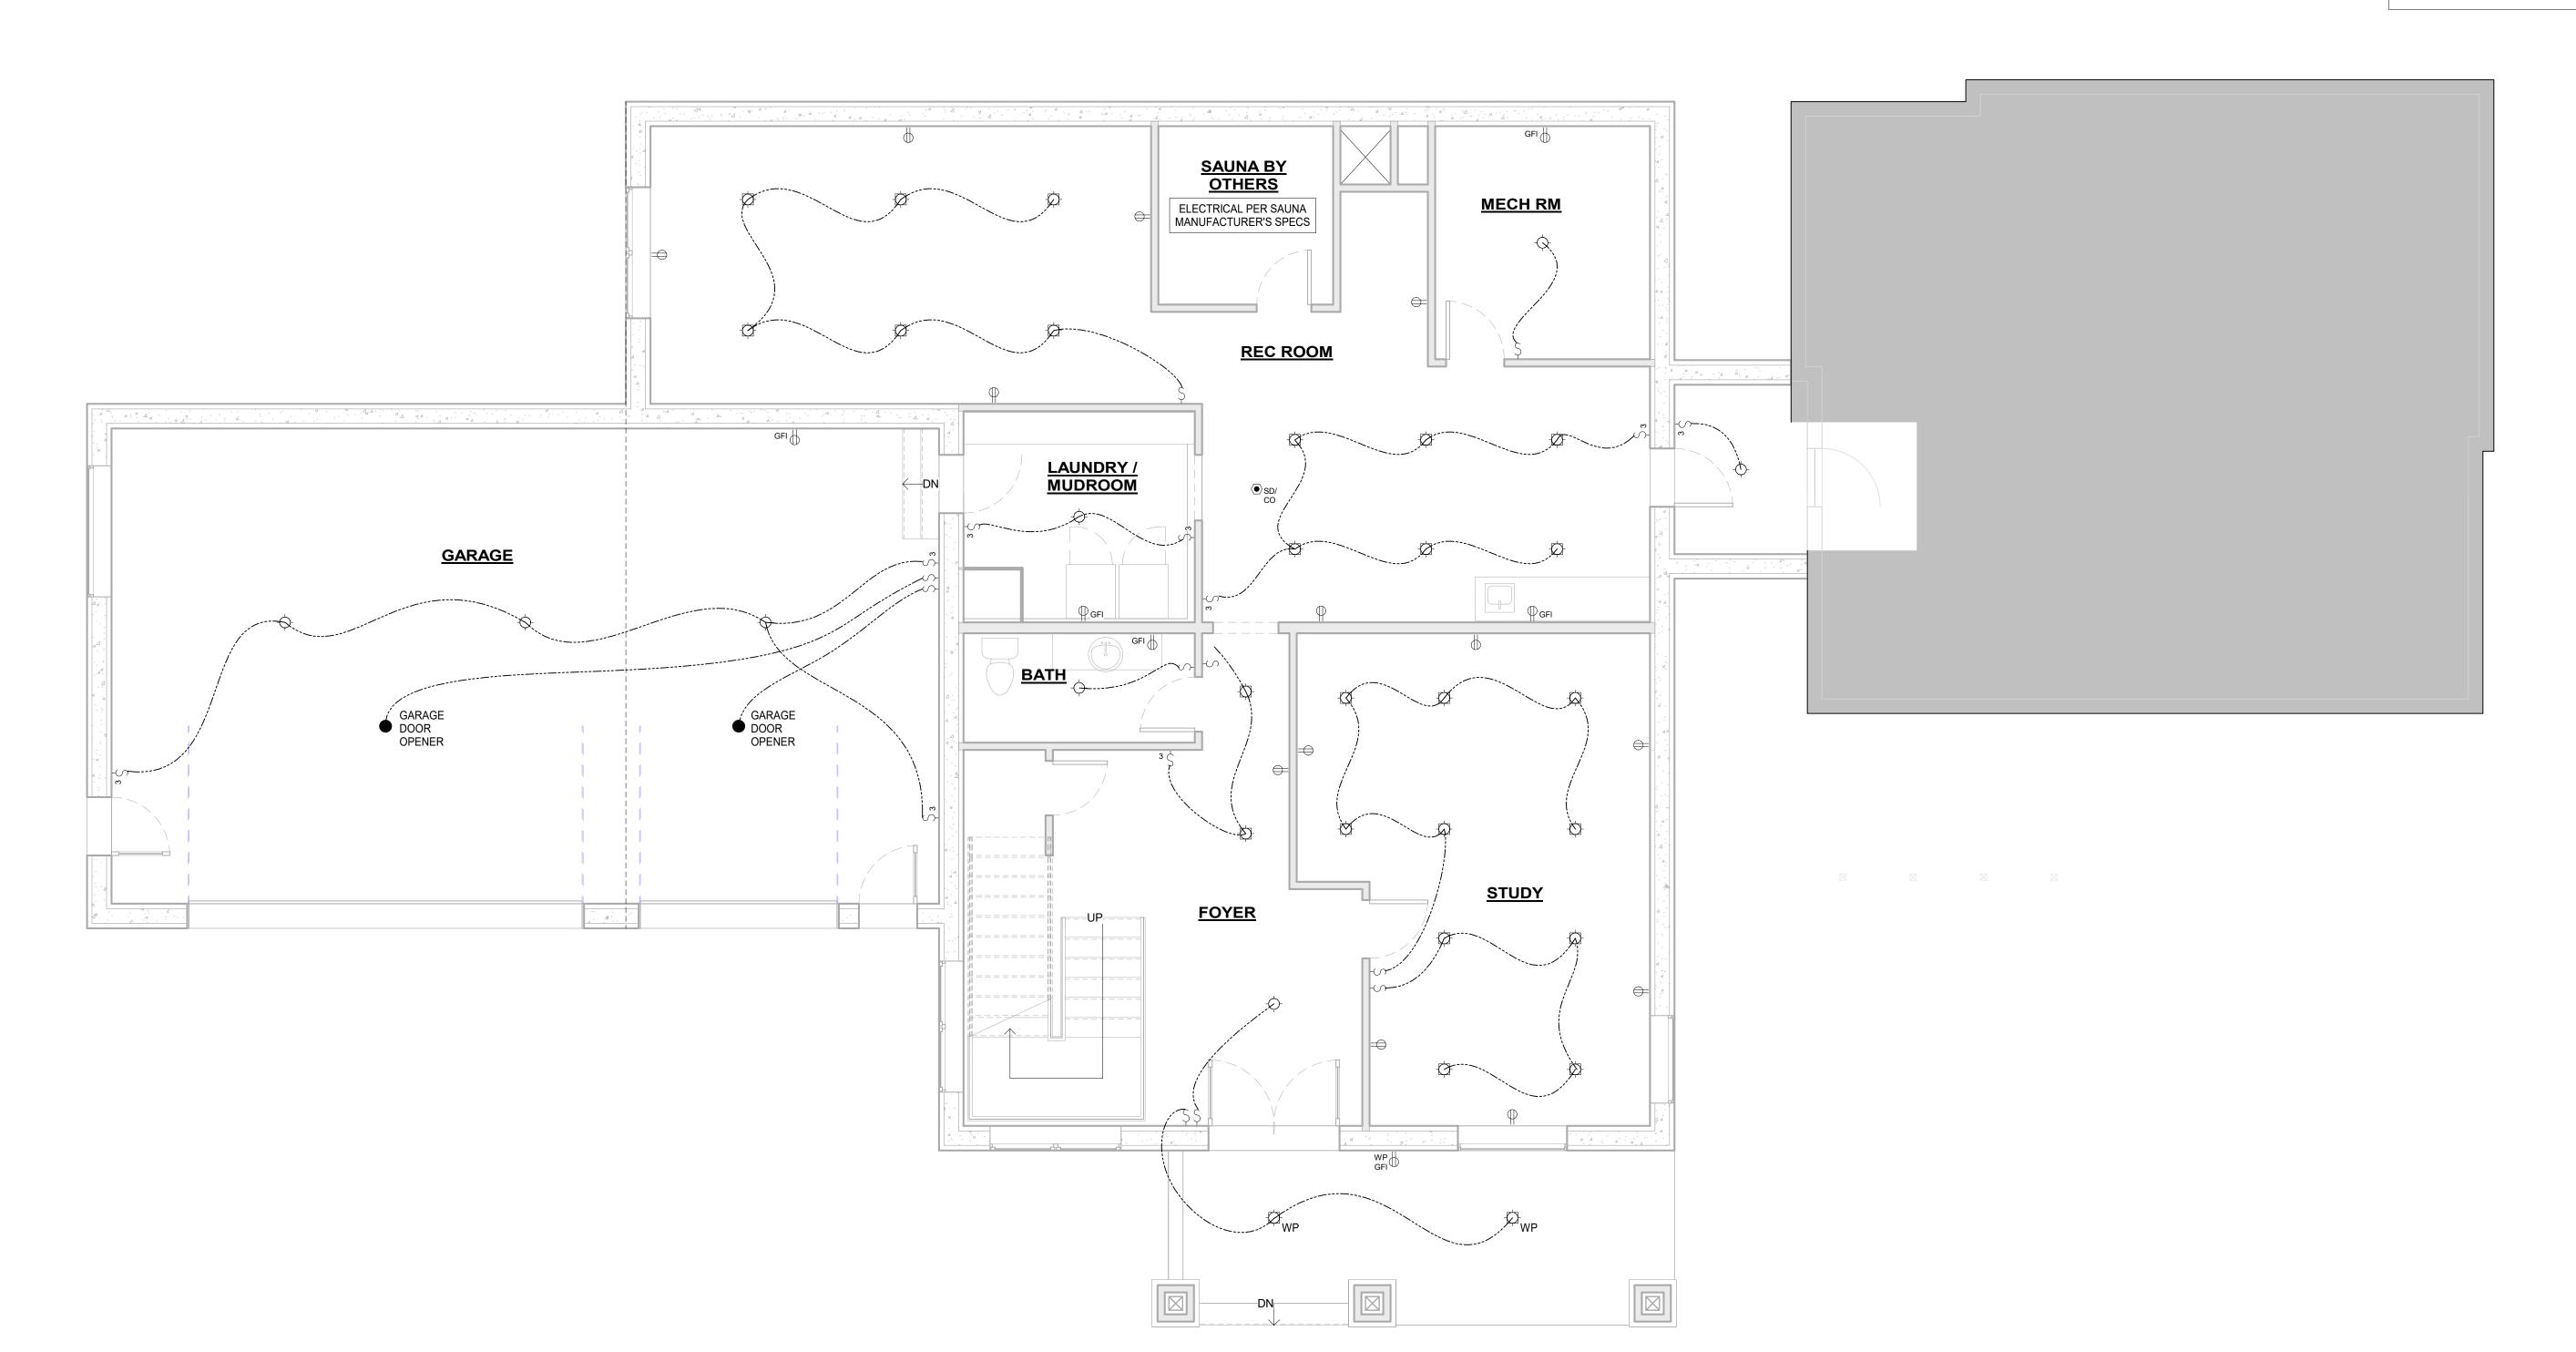

STUDIOS

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ARCHITECTURE

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LOWER LEVEL ELECTRICAL PLAN

JOB #: 2022 DWN: AR CHK: AR DATE: 10/08/2022

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DENCE

FIRST FLOOR ELECTRICAL PLAN

JOB #: 2022 DWN: AR CHK: AR

DATE: 10/08/2022 DRAWING NO.

1) FIRST FLOOR ELECTRICAL PLAN 1/4" = 1'-0"

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N RESIDENCE

PROPOSED ADDITIC

LOUISIANA
4546 HIGHLAND RO,

ISSUED FOR PERMITS: 05/31/2024

REVISION LEGEND

No. Date As Per:

SECOND FLOOR ELECTRICAL PLAN

JOB #: 2022 DWN: AR CHK: AR DATE: 10/08/2022

DATE: 10/08/20 DRAWING NO.

E-103

PROPOSED SECOND FLOOR

ELECTRICAL PLAN

1/4" = 1'-0"