City Council Agenda Item #12_ Meeting of April 30, 2018

Brief Description

Items concerning Bren Road Development, a multi-family residential development by Dominium, at 11001 Bren Road East.

Land Use

- 1) Ordinance rezoning the property from I-1, industrial, to PUD, planned unit development;
- 2) Master development plan;
- 3) Final site and building plan review;
- 4) Lot division; and
- 5) Environmental Assessment Worksheet declaration.

Finance

- 1) Tax Increment Financing
- 2) Contract for Private Development

Action Requested

Introduce the ordinance and refer it the planning commission

Background

In 2017, Dominium presented a concept plan for redevelopment of the 9.8-acre property at 11001 Bren Road. The plan contemplated removal of an existing office building and construction of three buildings containing a total of 454 apartment units. Two of the buildings would be dedicated to workforce housing, while the third building would be affordable, independent senior housing. The city council generally indicated support for the concept, but suggested to city staff that pedestrian connections and broader park planning in OPUS be considered.

Proposal

Dominium has now submitted formal applications for the redevelopment of the site. As proposed, it includes a total of 482 rental units constructed in three, new buildings. The westerly building (Building A) is a proposed four-story, 83-unit, workforce housing building. The southerly building (Building B) would contain 137 workforce units. This building would actually have the above-grade appearance of two, five-story buildings. However, the building would share one foundation and underground garage. The northerly building (Building C) would be six-stories in height and contain 262 affordable, independent senior units. All of the buildings would be served by underground parking, as well as surface parking lots. The future Southwest Light Rail Transit Opus Station will be located directly to east of the development site.

The proposal requires approval of:

- **Rezoning.** To facilitate the proposed development, Dominium is requesting that the property be rezoned to PUD.
- **Master Development Plan.** Under the zoning ordinance, a master development plan is required in conjunction with PUD zoning.
- **Final Site and Building Plans.** By city code, site and building plan review is required in conjunction with PUD zoning.
- Environmental Assessment Worksheet Declaration. Based on the number of living units proposed, an Environmental Assessment Worksheet (EAW) is required under state statute. An EAW includes a series of 20 questions, the answers to which suggest whether a proposal will have significant environmental impact. If the Responsible Government Unit (RGU), in this case the city, determines that a project will result in significant impact, the RGU may declare that an Environmental Impact Statement (EIS) is required. An EIS is a more in-depth environmental review. Staff is currently reviewing the EAW completed for the Dominium proposal.
- Tax Increment Financing. To assist with the production of affordable housing, Dominium is requesting that the city provide Tax Increment Financing (TIF) assistance in the amount of \$7,809,000 with a maximum term of 26 years. The Economic Development Advisory Commission (EDAC) and city council previously reviewed this request for assistance and found the request reasonable.
- Contract for Private Development. The EDAC reviewed a draft Contract for Private
 Development at its April 19 meeting. The contract outlines the key points of the TIF
 request as well as expectations for the development. The council will review the final
 contract at its June 4 meeting.

Issue Identification

The purpose of introducing an ordinance is to give the city council the opportunity to review a new application before sending it to the planning commission for a recommendation. Introducing an ordinance does not constitute an approval. The tentative planning commission date is May 10, 2018.

Based on preliminary review of the proposal, staff has identified the following issues for further analysis and discussion:

- **Parking.** The parking supply and anticipated demand will be considered.
- **Utilities.** The provision and location of sewer and water utilities location, type, etc. will be reviewed in detail.
- **Pedestrian Connections/Placemaking.** The provision and location of pedestrian connections will be evaluated. The council discussed placemaking at its April 23 study session.

Staff Recommendation

- 1) Introduce the attached ordinance and refer it to the planning commission.
- 2) Approve or modify the attached notification area. This is the same area used for the previous concept plan.

Submitted through:

Geralyn Barone, City Manager Julie Wischnack, AICP, Community Development Director Loren Gordon, AICP, City Planner

Originated by:


Susan Thomas, AICP, Assistant City Planner





Location Map

Project: Dominium Address: 11001 Bren Rd E

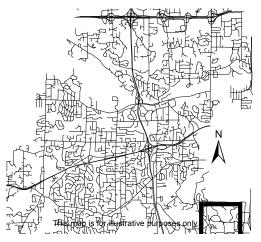



Bren Road Development





Bren Road Development Written Statement

The Bren Road Development is a proposed multi-family development that will include 482 units of housing for senior and general occupancy population. The site is currently zoned as I-1 Industrial, occupied by Digi International Inc., and is being used as a commercial- office space. The proposed zoning of the project is a PUD (Planned Unit Development) and the intended use of the project is multi-family housing.











<u>DESCRIPTION OF PROPERTY SURVEYED</u> (Per Schedule A of the herein referenced Title Commitment)

Lots 1 and 2, Block 1, Opus 2 Eighth Addition.

S88°53'47"E

Hennepin County, Minnesota

Torrens Property

TITLE COMMITMENT EXCEPTIONS

(Per Schedule B, Part II of the herein referenced Title Commitment)

The property depicted on this survey and the easements of record shown hereon are the same as the property and the easements described in the Commitment for Title Insurance issued by Commercial Partners Title, LLC, as agent for Old Republic National Title Insurance Company, File No. 53041, effective date May 19, 2017. The numbers below correspond to those in the title commitment.

1-8 do not require comment.

9. Subject to an easement for sanitary sewer purposes in favor of the City of Minnetonka as contained in CR Book 73, Page 3995823.

Partially vacated by Resolution No. 81-6541 adopted April 20, 1981, filed May 6, 1981, as Document No.1423875. [Partially vacated easements. Shown hereon as drainage and utility easements per the plat of OPUS 2 EIGHTH ADDITION.]

10. Together with the right of the owner of that part of Lots 1 and 2, Block 1, Opus 2 Eighth Addition embraced within Outlots D, G and F, The Townhouses of Shady Oak to an easement for road purposes over Ferndale Drive as provided in Document No.

1086026 (See Order Document No. 1293383), as shown by recital on the Certificate of Title. [Undefined area on property, Ferndale Drive is shown on available maps, west of the property, Not Shown hereon.]
1. Subject to a 30 foot sanitary sewer easement in favor of the City of Minnetonka as described in Parcel No. 25 in instrument filed January 12, 1973, as CR Document No. 3995823 (Now as to part of Lot 1), as shown by recital on the Certificate of Title.

/^\//27.7/\in².3\in/27.7/\in².3\in/27.7/\in².3\in/25.6//\in

prainage and Utility Easement Per Plat of OPUS 2 EIGHTH ADDITION

PID: 3611722310016

- Sanitary Easement Retained Per. Doc. No. 1423875

Partially vacated by Resolution No. 81-6541 adopted April 20, 1981, filed May 6, 1981, as Document No. 1423875. [Partially vacated easements. Shown hereon as drainage and utility easements per the plat of OPUS 2 EIGHTH ADDITION.]

12. Subject to a reservation unto Clover Drive, Inc., and its successors and assigns, of an easement for secondary road purposes. [Located along the south property line in the Southeast corner of the site, Shown hereon.]

13. Subject to a reservation unto Clover Drive, Inc., its successors and assigns, of an easement 2.00 feet in width for concrete edging purposes over, under and across that portion of said Lots 1 and 2 lying adjacent to the public right-of-way designated as Bren Road West and Bren Road on the recorded plat of Opus 2 Eighth Addition, as shown by recital on the Certificate of Title. [Alonge the Easterly and northerly property lines Shown hereon.]

4. Easements for utilities and drainage as shown on the recorded plat of Opus 2 Eighth Addition. [Located along the south, easterly and northerly property lines, Shown hereon.]
5. Easement for public right-of-way purposes, in favor of the City of Minnetonka, a municipal corporation, as created in document dated May 27, 1976, filed August 30, 1976, as Document No. 1188617. [Located in the Northeast side of the property, Shown hereon.]

16.Permanent easement reserved in Declaration of Industrial Standards and Protective Covenants dated April 7, 1981, filed April 8, 1981, as Document No. 1420987. Assigned as shown by Assignment dated September 6, 1983, filed April 3, 1984, as

Document No.1570465. [Easements defined per plat]
17. Easement for storm sewer purposes, in favor of the City of Minnetonka, a Minnesota municipal corporation, as created in document dated October 12, 1982, filed February 23, 1983, as Document No. 1502290. [Located at the southwest corner of the property, Shown hereon.]

Lot 1

PID: 3611722310015 11001 Bren Road Eas

Minnetonka, MN 55343

Owner: Digi International Inc.

shown per recital on certificate of title.

I = 290.68 $\Delta = 60^{\circ} 14'04''$

BITUMINOUS SURFACE

BITUMINOUS SURFACE

Easement for Secondary Purposes Shown

ALTA/NSPS OPTIONAL TABLE A NOTES

(The following items refer to Table A optional survey responsibilities and specifications)

- 1. Monuments placed (or a reference monument or witness to the corner) at all major corners of the boundary of the property, unless already marked or referenced by existing monuments or witnesses to the corner are shown hereon.
- 2. The address, if disclosed in documents provided to or obtained by the surveyor, or observed while conducting the fieldwork is 11001 Bren Road East, Minnetonka, MN 55343.

 3. This property is contained in Zone X (areas determined to be outside the 0.2% annual chance floodplain) per Flood Insurance Rate Map No. 27053C0343F, Community Panel No.
- 3. This property is contained in Zone X (areas determined to be outside the 0.2% annual chance floodplain) per Flood Insurance Rate Map No. 27053C0343F, Community Pan 0343F, effective date of November 4, 2016.
- 4. The Gross land area is 409,223 +/- square feet or 9.39 +/- acres.
- 6. (a) Any current zoning classification, setback requirements, height and floor space area restrictions, and parking requirements, shown hereon, are per a report or letter provided to the surveyor by the City of Minnetonka dated 7/13/2017, for the subject property are as follows:
- Setbacks: Front 35 feet from local neighborhood or collector streets or 50 feet from railroads and major collector streets or arterial roadways, Side & Rear 70 feet Zone R1, 50 feet from Zone R4;
- Height: thirty five (35) feet;

Floor Area Ratio: Lot coverage shall not exceed eighty five (85) percent of lot area.

- 7. (a) Exterior dimensions of all buildings are shown at ground level.
- 8. Substantial features observed in the process of conducting fieldwork, are shown hereon.
- 9. Striping of clearly identifiable parking spaces on surface parking areas and lots are shown hereon. The number and type of clearly identifiable parking stalls on this site are as follows: 427 Regular + 9 Disabled = 436 Total Parking Stalls.
- 11. We have shown underground utilities on and/or serving the surveyed property per Gopher State One-Call Ticket Nos. 171592945, 171592952 and 171841569. The following utilities and municipalities were notified:
 - CITY OF MINNETONKA (952)988-8400 COMCAST (800)762-0592 CENTURYLINK (855)742-6062
 CENTER POINT ENERGY (406)541-9571 SPRINT/LONG DISTANCE (800)521-0579 LEVEL3COMMUNICATIONS (877)366-8344
 XCEL ENERGY (800)848-7558 ZAYO BANDWIDTH (888)267-1063
- i. Utility operators do not consistently respond to locate requests through the Gopher State One Call service for surveying purposes such as this. Those utility operators that do respond, often will not locate utilities from their main line to the customer's structure or facility. They consider those utilities "private" installations that are outside their jurisdiction. These "private" utilities on the surveyed property or adjoining properties, may not be located since most operators will not mark such "private" utilities. A private utility locator may be contacted to investigate these utilities further, if requested by the client.
- ii. The locations of underground utility lines shown hereon is an approximation based on available maps, unless otherwise noted on the survey.
- iii. Maps provided by those notified above, either along with a field location or in lieu of such a location, are very often inaccurate or inconclusive. EXTREME CAUTION MUST BE EXERCISED BEFORE AN EXCAVATION TAKES PLACE ON OR NEAR THIS SITE. BEFORE DIGGING, YOU ARE REQUIRED BY LAW TO NOTIFY GOPHER STATE ONE CALL AT LEAST 48 HOURS IN ADVANCE AT 811 or (651) 454-0002.
- 13. The names of the adjoining owners, as shown hereon, are based on information obtained from current tax records.
- 16. We are not aware of any evidence of recent earth moving work, building construction or building additions observed in the process of conducting our field work.
- 17. We are not aware of any proposed changes in street right of way lines or evidence of recent street or sidewalk construction or repairs observed in the process of conducting our field work.
- 18. The location of wetland delineation markers, which have been determined by a qualified specialist, are shown hereon.
- 19. Plottable offsite (i.e., appurtenant) easements or servitudes disclosed in documents provided to or obtained by the surveyor are shown hereon.

SURVEY REPORT

- 1. The Surveyor was not provided utility easement documents for the subject property except for those shown on the Survey.
- 2. The bearings for this survey are based on the Hennepin County Coordinate System NAD 83 (1986 Adjust).
- 3. Benchmark: MnDOT name HEART, in Minnetonka, 1.0 mile west along trunk highway 62 from the junction of trunk highway 62 and trunk highway 169 in Eden Prairie, at trunk highway 62 mile point 104.75, 45.0 feet north of the westbound trunk highway 62 fog line, 76.3 feet south of the ramp from shady oak road to westbound trunk highway 62, 1.5 feet south of the witness post. Elevation = 962.095 (NAVD88)

Site Benchmark: Top nut of fire hydrant located south of the entrance to the site on the west side of Bren Road. Elevation = 897.41(NAVD88)

- 4. Curb and guard rail falls on the property along Bren Road E.
- 5. Bituminous path falls on the property along the south line.

CERTIFICATION


To Minnetonka Leased Housing Associates II, LLLP.; Digi International Inc. Commercial Partners Title, LLC; and Old Republic Title Insurance Company:

This is to certify that this map or plat and the survey on which it is based were made in accordance with the 2016 Minimum Standard Detail Requirements for ALTA/NSPS Land Title Surveys, jointly established and adopted by ALTA and NSPS, and includes Items 1 - 4, 6(a), 7(a), 8, 9, 11,13, 16, 17, 18 and 19 of Table A thereof. The field work was completed on July 06, 2017.

Date of Plat or Map: October 9, 2017

Max L. Stanislowski, PLS Minnesota License No. 48988 mstanislowski@loucksinc.com



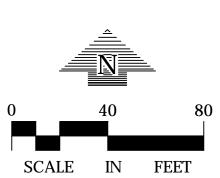

-----BSBL----- BUILDING SETBACK

SURVEY LEGEND

			JONVET LEGEN	10	
AS	ASH		HYDRANT		-STORM SEWER
ВА	BASSWOOD	\bowtie	GATE VALVE	>	-SANITARY SEWER
ВО	BOXELDER	Ø	POWER POLE	—— I ——	- WATERMAIN
СО	COTTONWOOD	Þ	LIGHT POLE	>	CULVERT
EL	ELM	Ö	YARD LIGHT	CTV	-UNDERGROUND CABLE T
FR	MISC FRUIT	\leftarrow	GUY WIRE	—— ELE ——	- UNDERGROUND ELECTRIC
LO	LOCUST	-0-	SIGN	—— го ——	- UNDERGROUND FIBER O
PI	PINE	_× 972.5	SPOT ELEVATION	——— GAS———	- UNDERGROUND GAS
SP	SPRUCE	E	ELECTRIC TRANSFORMER	TEL	- UNDERGROUND TELEPHO
TR	TREE (GEN)	∏	TELEPHONE PEDESTAL		- UNDERGROUND UTILITY
Ø Z	CATCH BASIN	E	ELECTRIC MANHOLE		OVERHEAD UTILITY
\bigcirc	STORM MANHOLE	©	GAS VALVE		FORCE MAIN
\bigcirc	SANITARY MANHOLE	(T)	TELEPHONE MANHOLE		
Ē	FIBER MANHOLE	(E)	ELECTRIC METER		- CHAIN LINK FENCE - CONCRETE CURB
0	GUARDPOST	_			
• _{RD}	ROOF DRAIN	©	GAS METER	4.4] CONCRETE
□ FC	FIRE CONNECTION		ENOTES 1/2 INCH X 14 ICH IRON MONUMENT	_872	CONTOUR
□E0	ELECTRIC OUTLET	S	ET, MARKED "LS 48988"	0 0 0	∘ GUARDRAIL
H	HAND HOLE	• D	ENOTES IRON MONUMENT FOUND		-BUILDING SETBACK

 ${}^{\textcircled{\tiny{\textbf{D}}}}$ POST INDICATOR VALVE \triangle DENOTES NAIL MONUMENT FOUND

11001 BREN ROAD EAST

MINNETONKA, MN 553

DOMINIUM DEVELOPMENT AND ACQUISITIONS, LLC.

2905 NORTHWEST BOULEVARI SUITE 15

LOUCKS

PLYMOUTH, MN 55

CIVIL ENGINEERING
LAND SURVEYING
LANDSCAPE ARCHITECTURE
ENVIRONMENTAL

7200 Hemlock Lane, Suite 300 Maple Grove, MN 55369 763.424.5505 www.loucksinc.com

CADD QUALIFICATION

CADD files prepared by the Consultant for this project are instruments of the Consultant professional services for use solely with respect to this project. These CADD files shall not be used on other projects, for additions to this project, or for completion of this project by others without written approval by the Consultant. With the Consultant's approval, others may be permitted to obtain copies of the CADD drawing files for information and reference only. All intentional or unintentional

revisions, additions, or deletions to these CADD files shall be made at the full risk of that party making such revisions, additions or deletions and that party shall hold harmless and indemnify the Consultant from any & all responsibilities, claims, and liabilities.

SUBMITTAL/REVISIONS

07-14-17 SURVEY ISSUED
07-24-17 REVISED UTILITY ESMT
10-09-17 REVISED PER COMMENTS

PROFESSIONAL SIGNATURE

I hereby certify that this survey, plan or report was prepared by me or under my direct supervision and that I am a duly Licensed Land Surveyor under the laws of the State of Minnesota.

Max L. Stanislowski - PLS

License No.

Date

QUALITY CONTROL

Loucks Project No.

Project Lead
Drawn By
Checked By

MLS

MLS

> ALTA/NSPS LAND TITLE SURVEY

Tree #	Species	DBH	Height	Stems	Condition
1	Ash, green	8.0		1	Poor
2	Basswood	19.5		1	Good
3	Spruce, blue	15.5	35	1	Good
4	Ash, green	19.0		1	Good
5	Spruce, blue	13.0	35	1	Good
6	Crabapple	9.5	<u> </u>	1	Good
7	Crabapple	9.0		1	Good
8	Crabapple	9.0		1	Good
9	Crabapple	9.0		1	Good
10	Ash, green	20.0		1	Good
11	Spruce, blue	16.0	30	1	Good
12	Maple, sugar	11.0		1	Fair
13	Maple, sugar	12.5		1	Good
14	Maple, sugar	13.0		1	Good
15	Spruce, blue	14.0	30	1	Good
16	Maple, Norway	12.5		1	Good
17	Maple, sugar	11.5		1	Good
18	Crabapple	8.5		1	Good
19	Basswood	14.0		1	Good
20	Spruce, blue	14.0	30	1	Good
21	Honeylocust	9.5		1	Good
22	Ash, green	11.0		1	Good
23	Spruce, white	6.5	18	1	Fair
24	Spruce, white	8.0	25	1	Good
25	Cottonwood	24.0		1	Good

S88°53'47"E 107.86

15.5"AS

10.5"B0

+ 13"AS

16"FR 10"B0 8"B0

15"EL +

Tree #	Species	DBH	Height	Stems	Condition
26	Willow	40.0		1	Good
27	Spruce, white	5.0	18	1	Fair
28	Spruce, white	5.5	20	1	Good
29	Spruce, white	7.5	20	1	Good
30	Spruce, white	6.0	18	1	Poor
31	Spruce, white	7.5	30	1	Good
32	Spruce, white	9.5	24	1	Fair
33	Spruce, white	10.0	30	1	Good
34	Spruce, white	11.0	30	1	Good
35	Spruce, white	8.0	30	1	Good
36	Spruce, white	7.5	30	1	Good
37	Spruce, white	14.0	35	1	Good
38	Spruce, white	9.5	32	1	Fair
39	Ash, green	13.5		1	Good
40	Spruce, blue	10.0	30	1	Fair
41	Spruce, blue	11.0	40	_ 1	Good
42	Spruce, blue	13.0	40	1	Good
43	Spruce, blue	10.0	25	1	Fair
44	Spruce, blue	9.5	28	1	Fair
45	Spruce, blue	15.0	45	1	Good
46	Spruce, blue	15.0	45	1	Good
47	Spruce, blue	15.0	45	1	Good
48	Spruce, blue	15.0	45	1	Good
49	Spruce, blue	17.0	45	1	Good

Basswood 44.0

Lot 1

PID: 3611722310015 11001 Bren Road East Minnetonka, MN 55343 Owner: Digi International Inc.

6 Fair

L=290.68 $\Delta=60^{\circ}/4'04''$ R=276.50

Tree#	Species	DBH	Height	Stems	Condition
51	Spruce, blue	9.0	35	1	Good
52	Basswood	15.0		1	Good
53	Spruce, blue	14.0	40	1	Good
54	Spruce, blue	15.0	45	1	Good
55	Spruce, blue	15.0	45	1	Good
56	Spruce, blue	17.0	40	1	Fair
57	Pine, Scots	12.0	20	1	Fair
58	Pine, Scots	15.0	35	1	Good
59	Spruce, white	6.0	22	1	Fair
60	Pine, Scots	16.0	38	1	Fair
61	Spruce, blue	12.0	35	1	Fair
62	Boxelder	18.0		1	Good
63	Ash, green	17.5		1	Good
64	Ash, green	19.0		1	Good
65	Ash, green	19.0		1	Good
66	Ash, green	16.5		1	Good
67	Mulberry	10.0		1	Poor
68	Spruce, white	5.5	18	1	Fair
69	Ash, green	13.0		2	Fair
70	Ash, green	15.0		1	Fair
71	Ash, green	8.0		1	Fair
72	Ash, green	13.0		1	Good
73	Elm, American	17.5		1	Good
74	Cottonwood	35.0		1	Good
75	Ash, green	10.0		1	Fair

Tree #	Species	DBH	Height	Stems	Condition
76	Ash, green	8.0		1	Good
77	Ash, green	11.5		1	Good
78	Cottonwood	35.5		1	Good
79	Ash, green	9.0		1	Good
80	Elm, American	8.0		1	Good
81	Ash, green	9.5		1	Fair
82	Ash, green	11.0		1	Good
83	Elm, American	14.5		1	Good
84	Ash, green	8.5		1	Good
85	Boxelder	9.5		1	Fair
86	Ash, green	15.0		1	Good
87	Willow	18.0		1	Good
88	Boxelder	10.0		1	Good
89	Elm, American	15.5		1	Good
90	Ash, green	13.0		1	Good
91	Ash, green	14.0		1	Good
92	Elm, American	11.5		1	Good
93	Elm, American	10.5	_	1	Good
94	Ash, green	10.5		1	Good
95	Ash, green	18.0		1	Good
96	Ash, green	10.0		1	Good
97	Ash, green	16.5		2	Fair
98	Willow	22.0		1	Good
99	Ash, green	18.0		1	Good
100	Elm, American	12.5		1	Good

Tree #	Species	DBH	Height	Stems	Condition	Tree #	Species	DBH	Height	Stems	Condition
101	Elm, American	17.5		1	Good	161	Ash, green	12.0		1	Good
102	Cottonwood	50.0		1	Good	162	Ash, green	13.0		1	Good
103	Cottonwood	27.0		1	Good	163	Spruce, white	7.5	35	1	Fair
104	Ash, green	10.5		1	Good	164	Spruce, white	13.5	45	1	Good
	_								40		
105	Elm, American	20.5		1	Good	165	Spruce, white	10.5	40	1	Fair
106	Cottonwood	44.5		1	Good	166	Ash, green	9.0	_	1	Good
107	Boxelder	16.0		1	Fair	167	Ash, green	8.5		1	Good
108	Spruce, white	11.0	40	1	Good	168	Ash, green	13.5		1	Good
109	Spruce, white	9.0	40	1	Good	169	Ash, green	15.5		1	Fair
110	Spruce, white	8.5	30	1	Good	170	Ash, green	12.5		1	Fair
_		_	- 30	-	-	_		_			_
111	Elm, American	21.0	_	2	Fair	171	Ash, green	15.5		_ 1	Good
112	Cottonwood	34.0	ļ	1	Good	172	Ash, green	16.0		1	Good
113	Ash, green	8.0		1	Good	173	Ash, green	15.0		1	Good
114	Elm, American	10.0		1	Good	174	Spruce, white	10.0	20	1	Good
115	Ash, green	14.0		1	Good	175	Spruce, white	12.0	30	1	Good
116	Boxelder	8.5		1	Good	176	Spruce, white	12.0	30	1	Good
		9.5		†				15.0	30		
117	Ash, green			1	Good	177	Ash, green			1	Good
118	Ash, green	9.0		1	Good	178	Ash, green	12.0		1	Good
119	Cottonwood	36.0		1	Good	179	Ash, green	13.5		1	Good
120	Cottonwood	32.0		1	Good	180	Ash, green	12.0		1	Good
121	Cottonwood	35.0		1	Good	181	Ash, green	16.0		1	Good
122	Cottonwood	25.0		1	Good	182	Ash, green	17.0		1	Good
123		8.0		1	Good	183	Spruce, white	8.0	40	1	Fair
	Ash, green						•		-		
124	Cottonwood	27.0		1	Good	184	Spruce, white	11.0	40	1	Good
125	Cottonwood	35.0		1	Good	185	Spruce, white	10.5	40	1	Good
126	Ash, green	8.5		1	Good	186	Spruce, blue	16.0	40	1	Good
127	Cottonwood	26.0		1	Good	187	Spruce, blue	6.0	20	1	Fair
128	Elm, American	10.0		1	Good	188	Spruce, blue	15.5	40	1	Good
129	Cottonwood	20.0		1	Good	189	Spruce, blue	9.5	40	1	Good
_		_	-	-		_					
130	Crabapple	13.0	_	1	Good	190	Spruce, blue	12.5	40	_ 1	Good
131	Cottonwood	23.0		1	Good	191	Spruce, blue	15.0	40	1	Good
132	Cottonwood	25.0		1	Good	192	Ash, green	11.5		1	Fair
133	Cottonwood	25.0		1	Good	193	Ash, green	9.5		1	Poor
134	Ash, green	10.5		1	Good	194	Ash, green	8.5		1	Good
135	Cottonwood	23.0		1	Good	195	Ash, green	10.0		1	Good
136		8.0	-	1	Good	196	Honeylocust	14.0		1	Fair
	Ash, green						•		25		
137	Willow	20.0		1	Good	197	Spruce, blue	13.0	35	1	Good
138	Cottonwood	28.0		1	Fair	198	Maple, silver	34.0		1	Good
139	Boxelder	18.0		1	Fair	199	Spruce, blue	11.5	30	1	Good
140	Cottonwood	47.0		1	Fair	200	Spruce, blue	20.0	30	1	Good
141	Ash, green	19.5		1	Good	201	Maple, silver	24.5		1	Good
142	Spruce, blue	16.0	40	1	Good	202	Ash, green	10.0		1	Fair
							_				
143	Spruce, blue	14.0	30	1	Fair	203	Maple, silver	10.0		1	Good
144	Spruce, blue	15.0	35	1	Good	204	Ash, green	9.5		1	Fair
145	Spruce, blue	16.0	35	1	Good	205	Basswood	13.5		1	Good
146	Ash, green	14.0		1	Good	206	Basswood	10.5		1	Good
147	Spruce, blue	14.0	40	1	Good	207	Basswood	10.5		1	Fair
148	Maple, silver	21.5		1	Good	208	Basswood	16.5		1	Good
149	Honeylocust	13.0		1	Fair	209	Arborvitae	14.0		1	Fair
	-	_	-								
150	Honeylocust	9.5		1	Good	210	Arborvitae	9.0		5	Fair
151	Ash, green	9.0		1	Good	211	Arborvitae	8.0	12	5	Fair
152	Ash, green	15.5		1	Good	212	Arborvitae	4.5	15	1	Fair
153	Ash, green	15.0		1	Good	213	Arborvitae	15.5	18	4	Fair
154	Ash, green	15.0		1	Good	214	Arborvitae	13.0	20	3	Fair
155	Ash, green	15.5		1	Good	215	Arborvitae	15.0	20	3	Fair
156		11.5	 		Good	215	Basswood	14.0		1	
	Ash, green			1					2=		Good
157	Ash, green	8.5		1	Good	217	Spruce, blue	12.0	35	1	Good
158	Spruce, white	11.5	40	1	Fair	218	Basswood	19.0		1	Good
159	Spruce, white	9.0	40	1	Fair	219	Basswood	16.5		1	Good
160	Spruce, white	11.0	40	1	Good	220	Basswood	15.5		1	Good
	·					<u>, </u>		-			

Tree#	Species	DBH	Height		Condition	Tree #	Species	DBH	Height	Stems	Condition
101	Elm, American	17.5		1	Good	161	Ash, green	12.0		1	Good
102	Cottonwood	50.0		1	Good	162	Ash, green	13.0		1	Good
103	Cottonwood	27.0		1	Good	163	Spruce, white	7.5	35	1	Fair
104	Ash, green	10.5		1	Good	164	Spruce, white	13.5	45	1	Good
105	Elm, American	20.5		1	Good	165	Spruce, white	10.5	40	1	Fair
106	Cottonwood	44.5		1	Good	166	Ash, green	9.0		1	Good
107	Boxelder	16.0		1	Fair	167	Ash, green	8.5		1	Good
108	Spruce, white	11.0	40	1	Good	168	Ash, green	13.5		1	Good
109	Spruce, white	9.0	40	1	Good	169	Ash, green	15.5		1	Fair
110	Spruce, white	8.5	30	1	Good	170	Ash, green	12.5		1	Fair
111	Elm, American	21.0		2	Fair	171	Ash, green	15.5		1	Good
112	Cottonwood	34.0		1	Good	172	Ash, green	16.0		1	Good
113	Ash, green	8.0		1	Good	173	Ash, green	15.0		1	Good
114	Elm, American	10.0		1	Good	174	Spruce, white	10.0	20	1	Good
115	Ash, green	14.0		1	Good	175	Spruce, white	12.0	30	1	Good
116	Boxelder	8.5		1	Good	176	Spruce, white	12.0	30	1	Good
117	Ash, green	9.5		1	Good	177	Ash, green	15.0		1	Good
118	Ash, green	9.0		1	Good	178	Ash, green	12.0		1	Good
119	Cottonwood	36.0		1	Good	179	Ash, green	13.5		1	Good
120	Cottonwood	32.0		1	Good	180	Ash, green	12.0		1	Good
121	Cottonwood	35.0		1	Good	181	Ash, green	16.0		1	Good
122	Cottonwood	25.0		1	Good	182	Ash, green	17.0		1	Good
123	Ash, green	8.0		1	Good	183	Spruce, white	8.0	40	1	Fair
124	Cottonwood	27.0		1	Good	184	Spruce, white	11.0	40	1	Good
125	Cottonwood	35.0		1	Good	185	Spruce, white	10.5	40	1	Good
126	Ash, green	8.5		1	Good	186	Spruce, blue	16.0	40	1	Good
127	Cottonwood	26.0		1	Good	187	Spruce, blue	6.0	20	1	Fair
128	Elm, American	10.0		1	Good	188	Spruce, blue	15.5	40	1	Good
129	Cottonwood	20.0		1	Good	189	Spruce, blue	9.5	40	1	Good
130	Crabapple	13.0	_	1	Good	190	Spruce, blue	12.5	40	1	Good
131	Cottonwood	23.0		1	Good	191	Spruce, blue	15.0	40	1	Good
132	Cottonwood	25.0		1	Good	192	Ash, green	11.5		1	Fair
133	Cottonwood	25.0		1	Good	193	Ash, green	9.5		1	Poor
134	Ash, green	10.5		1	Good	194	Ash, green	8.5		1	Good
135	Cottonwood	23.0		1	Good	195	Ash, green	10.0		1	Good
136	Ash, green	8.0		1	Good	196	Honeylocust	14.0		1	Fair
137	Willow	20.0		1	Good	197	Spruce, blue	13.0	35	1	Good
138	Cottonwood	28.0		1	Fair	198	Maple, silver	34.0		1	Good
139	Boxelder	18.0		1	Fair	199	Spruce, blue	11.5	30	1	Good
140	Cottonwood	47.0		1	Fair	200	Spruce, blue	20.0	30	1	Good
141	Ash, green	19.5		1	Good	201	Maple, silver	24.5		1	Good
142	Spruce, blue	16.0	40	1	Good	202	Ash, green	10.0		1	Fair
143	Spruce, blue	14.0	30	1	Fair	203	Maple, silver	10.0		1	Good
144	Spruce, blue	15.0	35	1	Good	204	Ash, green	9.5		1	Fair
145	Spruce, blue	16.0	35	1	Good	205	Basswood	13.5		1	Good
146	Ash, green	14.0		1	Good	206	Basswood	10.5		1	Good
147	Spruce, blue	14.0	40	1	Good	207	Basswood	10.5		1	Fair
148	Maple, silver	21.5		1	Good	208	Basswood	16.5		1	Good
149	Honeylocust	13.0		1	Fair	209	Arborvitae	14.0		1	Fair
150	Honeylocust	9.5		1	Good	210	Arborvitae	9.0		5	Fair
151	Ash, green	9.0		1	Good	211	Arborvitae	8.0	12	5	Fair
152	Ash, green	15.5		1	Good	212	Arborvitae	4.5	15	1	Fair
153	Ash, green	15.0		1	Good	213	Arborvitae	15.5	18	4	Fair
154	Ash, green	15.0		1	Good	214	Arborvitae	13.0	20	3	Fair
155	Ash green	15.5		1	Good	215	Arhorvitae	15.0	20	3	Fair

11001 BREN ROAD EAST
MINNETONKA, MN 55343
DOMINIUM DEVELOPMENT AND ACQUISITIONS, LLC.
2905 NORTHWEST BOULEVARD SUITE 150 PLYMOUTH, MN 55441
LOUCKS
PLANNING CIVIL ENGINEERING

CIVIL ENGINEERING

LAND SURVEYING LANDSCAPE ARCHITECTURE **ENVIRONMENTAL**

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CADD QUALIFICATION

CADD files prepared by the Consultant for this project are instruments of the Consultant professional services for use solely with respect to this project. These CADD files shall not be used on other projects, for additions to this project, or for completion of this project by others without written approval by the Consultant. With the Consultant's approval, others may be permitted to obtain copies of the CADD drawing files for information and reference only. All intentional or unintentional revisions additions or deletions to these CADD files shall be made at the full risk of that party making such revisions, additions or deletions and that party shall hold harmless and indemnify the Consultant from any & all responsibilities, claims, and liabilities.

SUBMITTAL/REVISIONS 02/20/18

TREE HEIGHTS 02/23/18 ADDITIONAL TREES

PROFESSIONAL SIGNATURE I hereby certify that this survey, plan or report was prepared by me or under my direct supervision and that

07-14-17

17298

MLS NRS

MLS

DJP/BEP

I am a duly Licensed Land Surveyor under the laws of the State of Minnesota.

QUALITY CONTROL

Loucks Project No. Project Lead Drawn By Checked By

Field Crew

VICINITY MAP

TREE INVENTORY SURVEY

1. The trees shown hereon were identified and field located to sub-meter accuracy by Stephen Nicholson, a Certified Arborist and Forester with TreeBiz on 07/06/2017.


- 2. Tree diameters are measured in inches.
- 3. Tree heights are measured to the nearest foot.

SURVEY LEGEND

TREE LINE



CONIFEROUS TREE

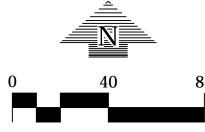

PID: 3611722310016 Owner: Lyn-James LLC Zone I-I

Lot 3

N88°53'47"W _861.43

204 203

BITUMINOUS SURFACE

Lot 2

BITUMINOUS SURFACE


BITUMINOUS SURFACE

-

DECIDUOUS TREE

DIAMETER AT BREAST HEIGHT

SCALE IN FEET

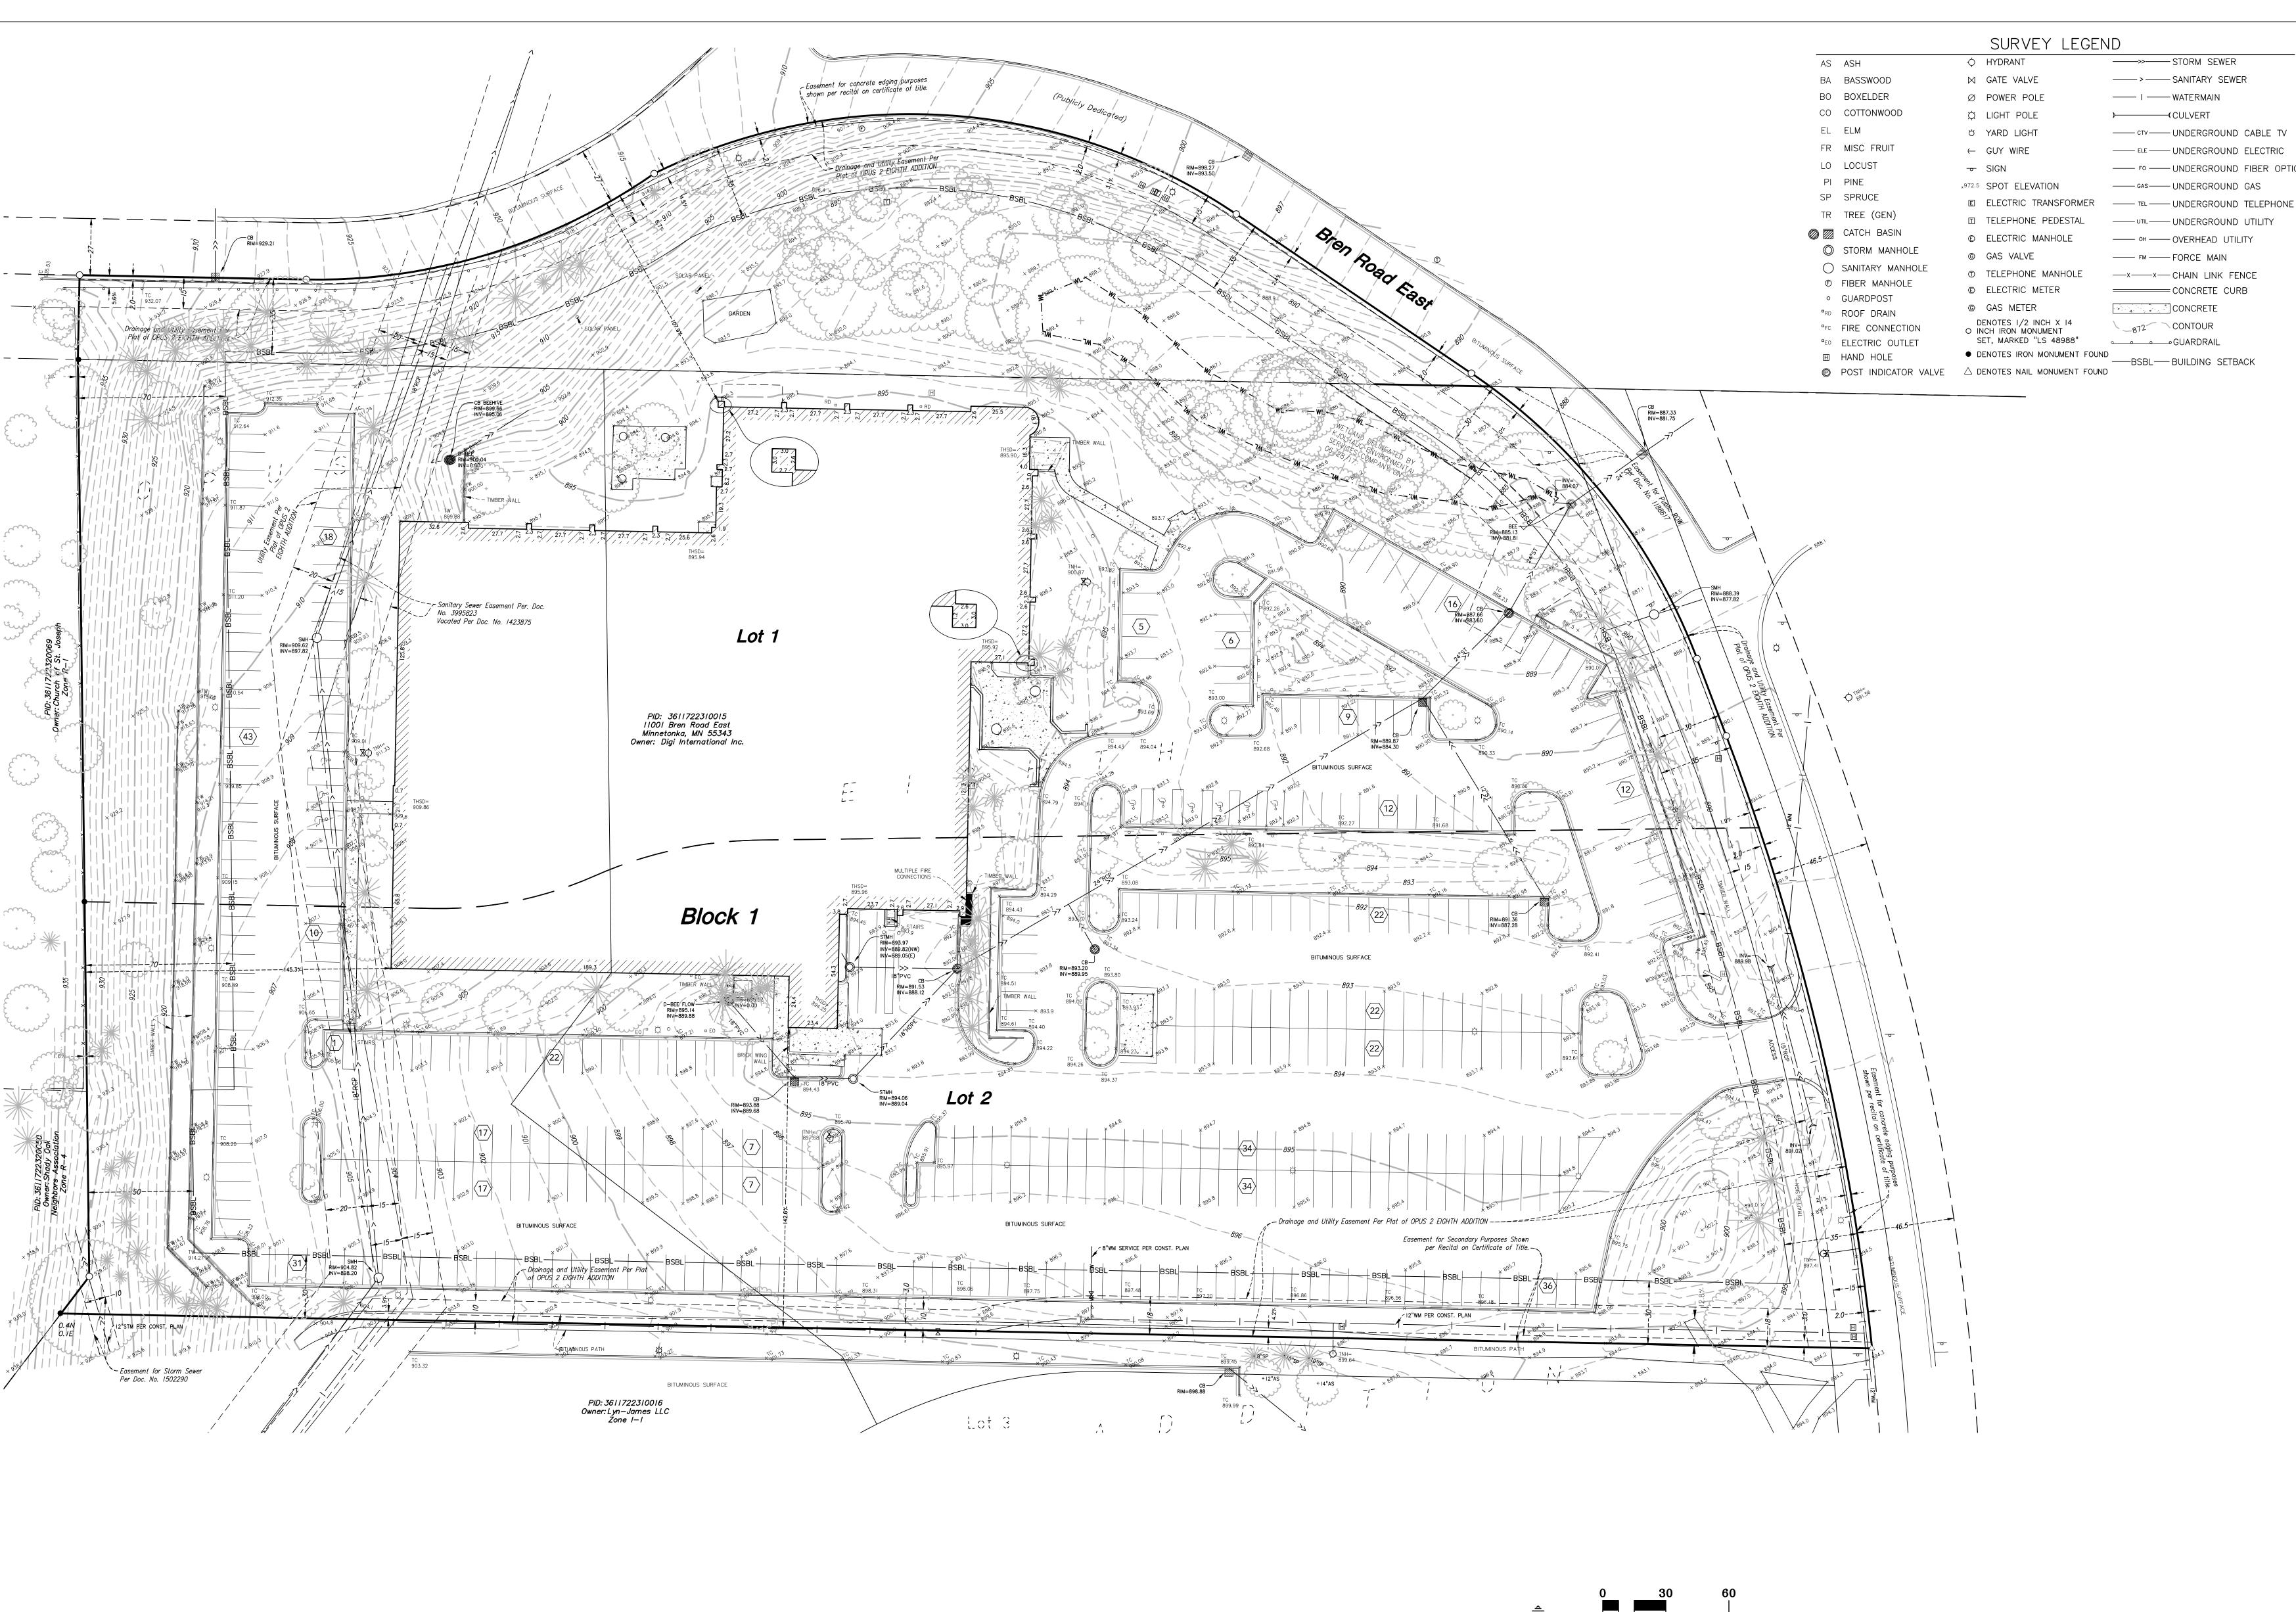

or report was prepared by me or under my direct supervision and that I am a duly Licensed Professional Engineer under the laws of the State of Minnesota.

> PJ Disch, PE XX/XX/XXXX 03/30/2018 SRT

SHEET TITLE

EXISTING CONDITIONS

SHEET NUMBER

C1-1

¥`&\$%*`6?J`; fci dž=bW*9C9

WARNING:

CALL BEFORE YOU DIG!

Gopher State One Call

TWIN CITY AREA: 651-454-0002 TOLL FREE: I-800-252-1166

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222 North Second Street Minneapolis MN 55401 Telephone: 612–339–3752 Facsimile: 612–339–6212 www.bkvgroup.com EOE

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LOUCKS CIVIL ENGINEERING

LAND SURVEYING LANDSCAPE ARCHITECTURE ENVIRONMENTAL 7200 Hemlock Lane, Suite 300

Maple Grove, MN 55369 763.424.5505 www.loucksinc.com

LOUCKS PROJECT NO. 17298.0A

PROJECT TITLE

BREN ROAD MASTER SITE DEVELOPMENT


OWNER/DEVELOPER



ISSUE # DATE DESCRIPTION 04/06/2018 CITY SUBMITTAL

CERTIFICATION I hereby certify that this plan, specification

License Number DRAWN BY CHECKED BY COMMISSION NUMBER 1393.123

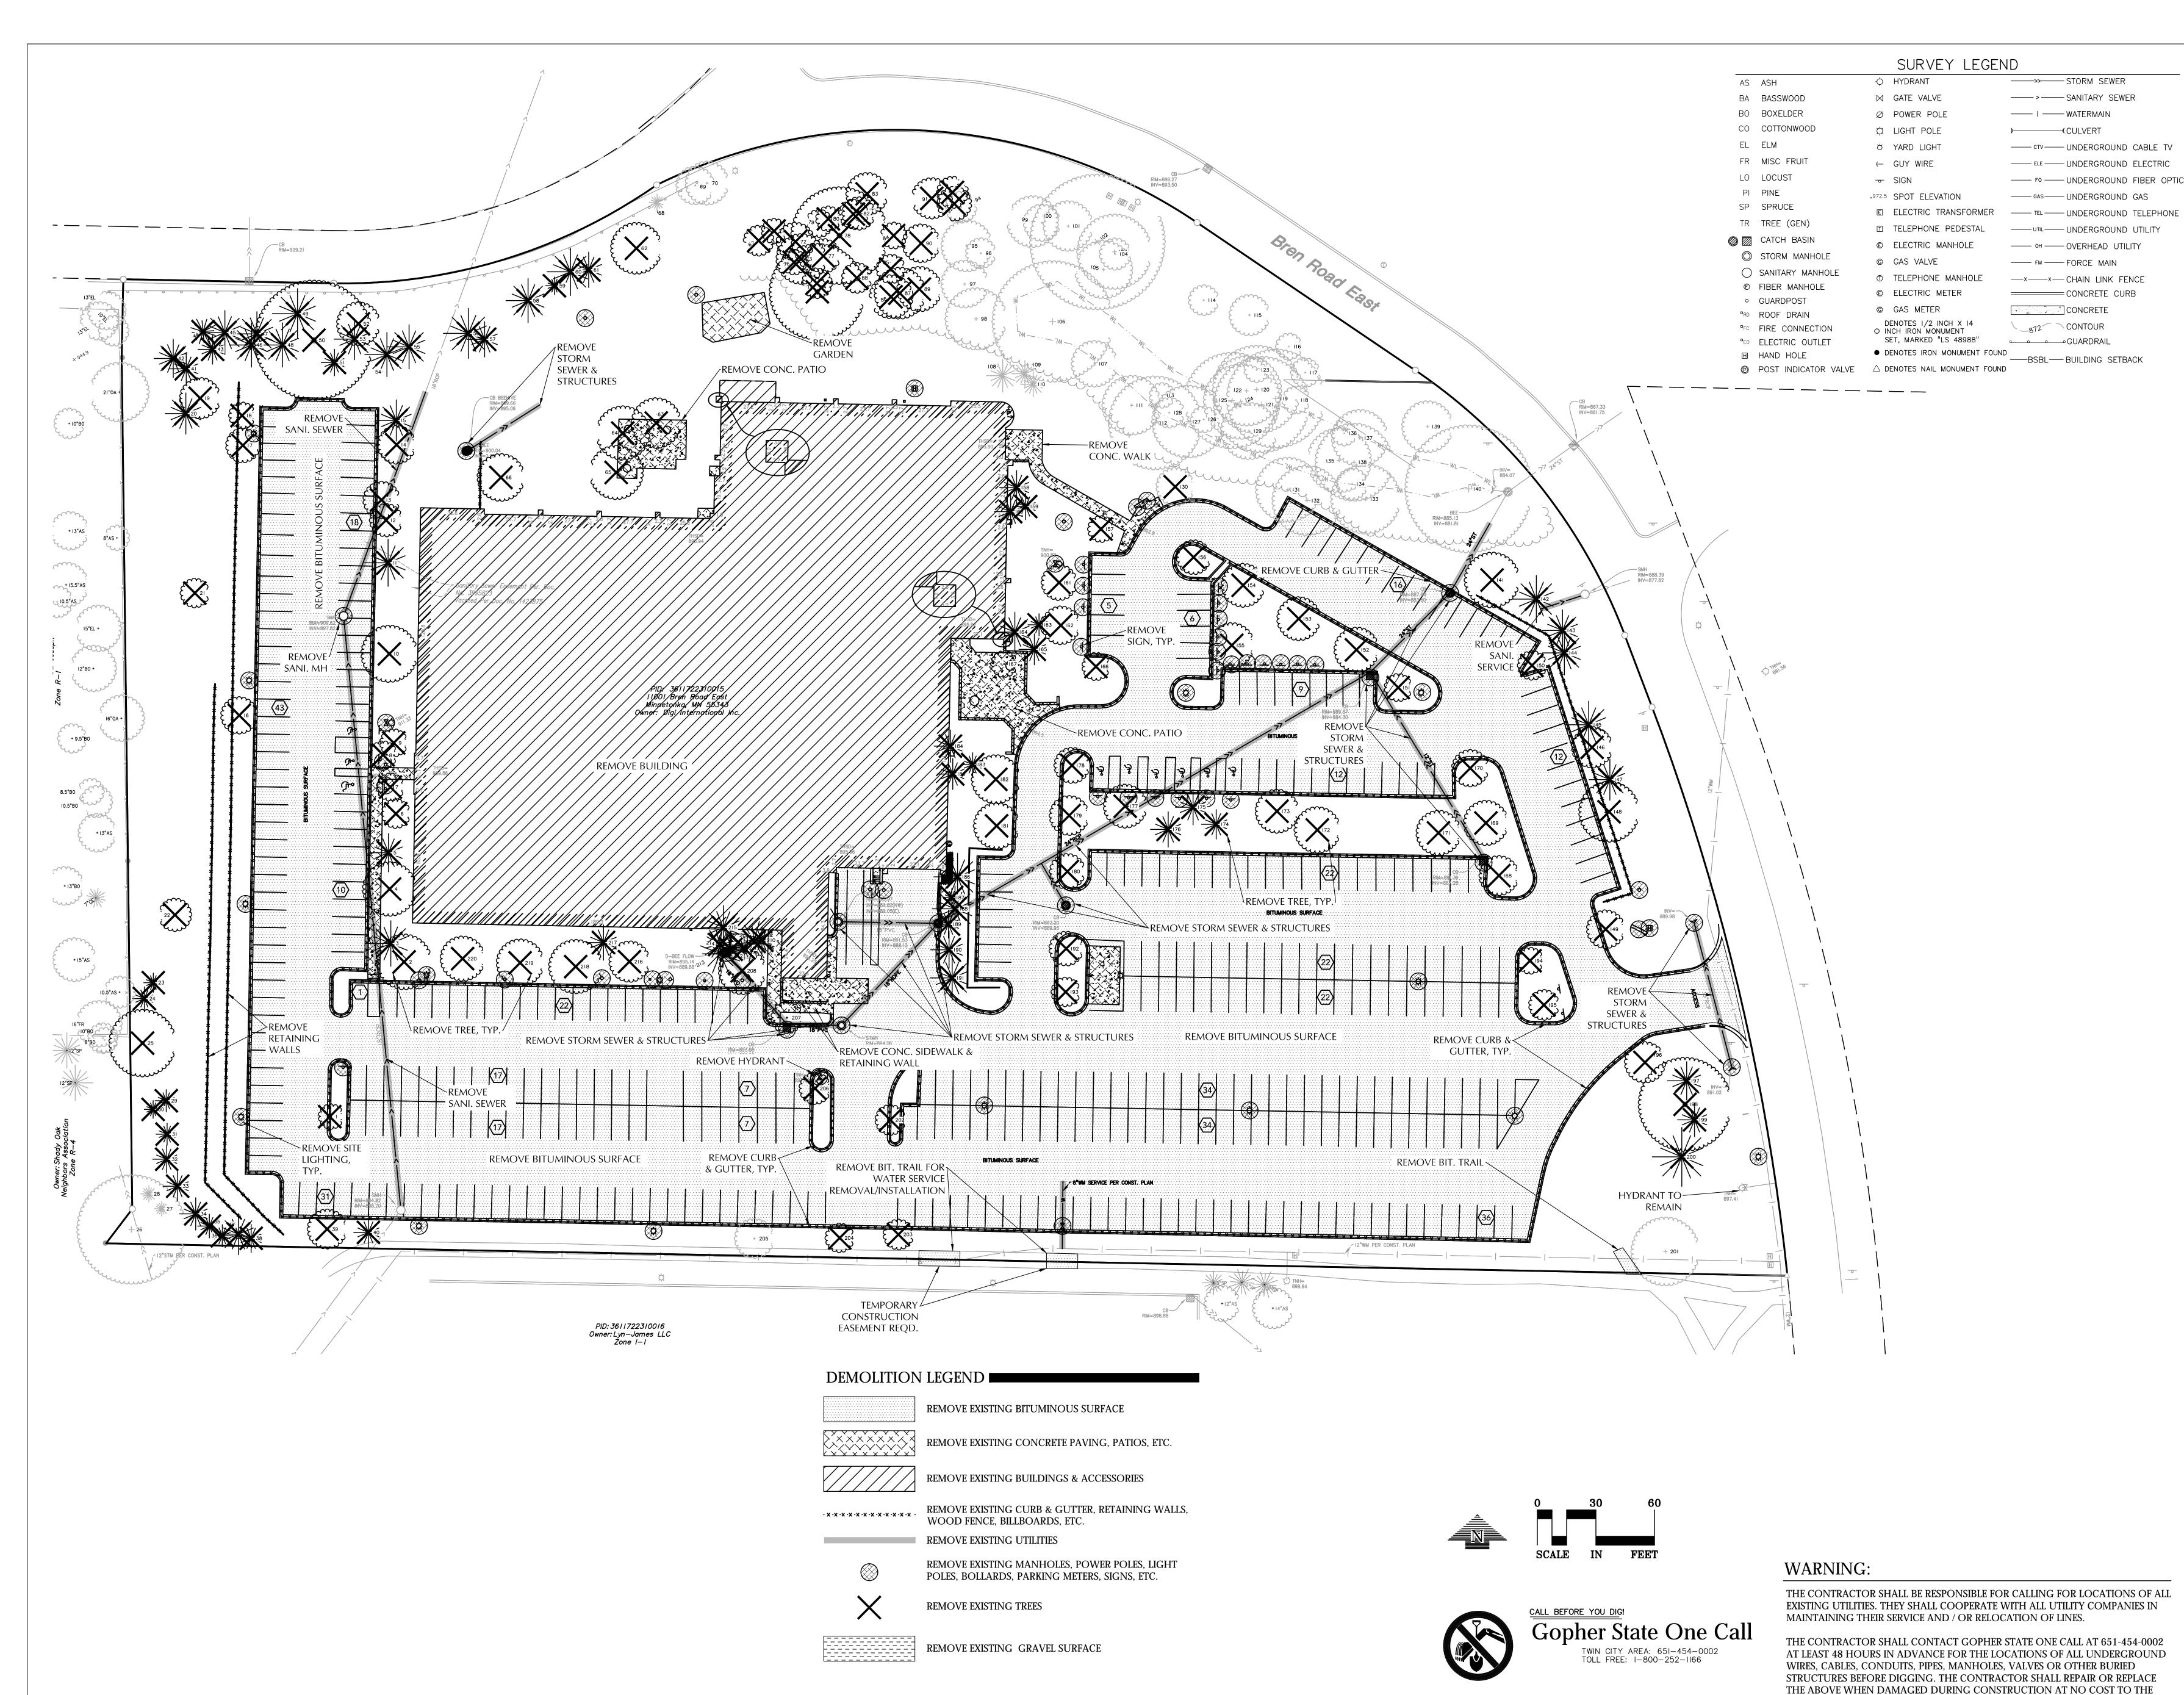

BKV GROUP

Architecture
Interior Design
Landscape Architecture
Engineering

Boarman Kroos Vogel Group Inc.

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CERTIFICATION

I hereby certify that this plan, specification or report was prepared by me or under my direct supervision and that I am a duly Licensed Professional Engineer under the laws of the State of Minnesota.

PJ Disch, PE

49933 XX/XX/XXX

License Number Date

DATE 03/30/2018

DRAWN BY SRT

CHECKED BY PJD

COMMISSION NUMBER 1393.123


DEMOLITION PLAN

OWNER.

SHEET TITLE

SHEET NUMBER

C1-2

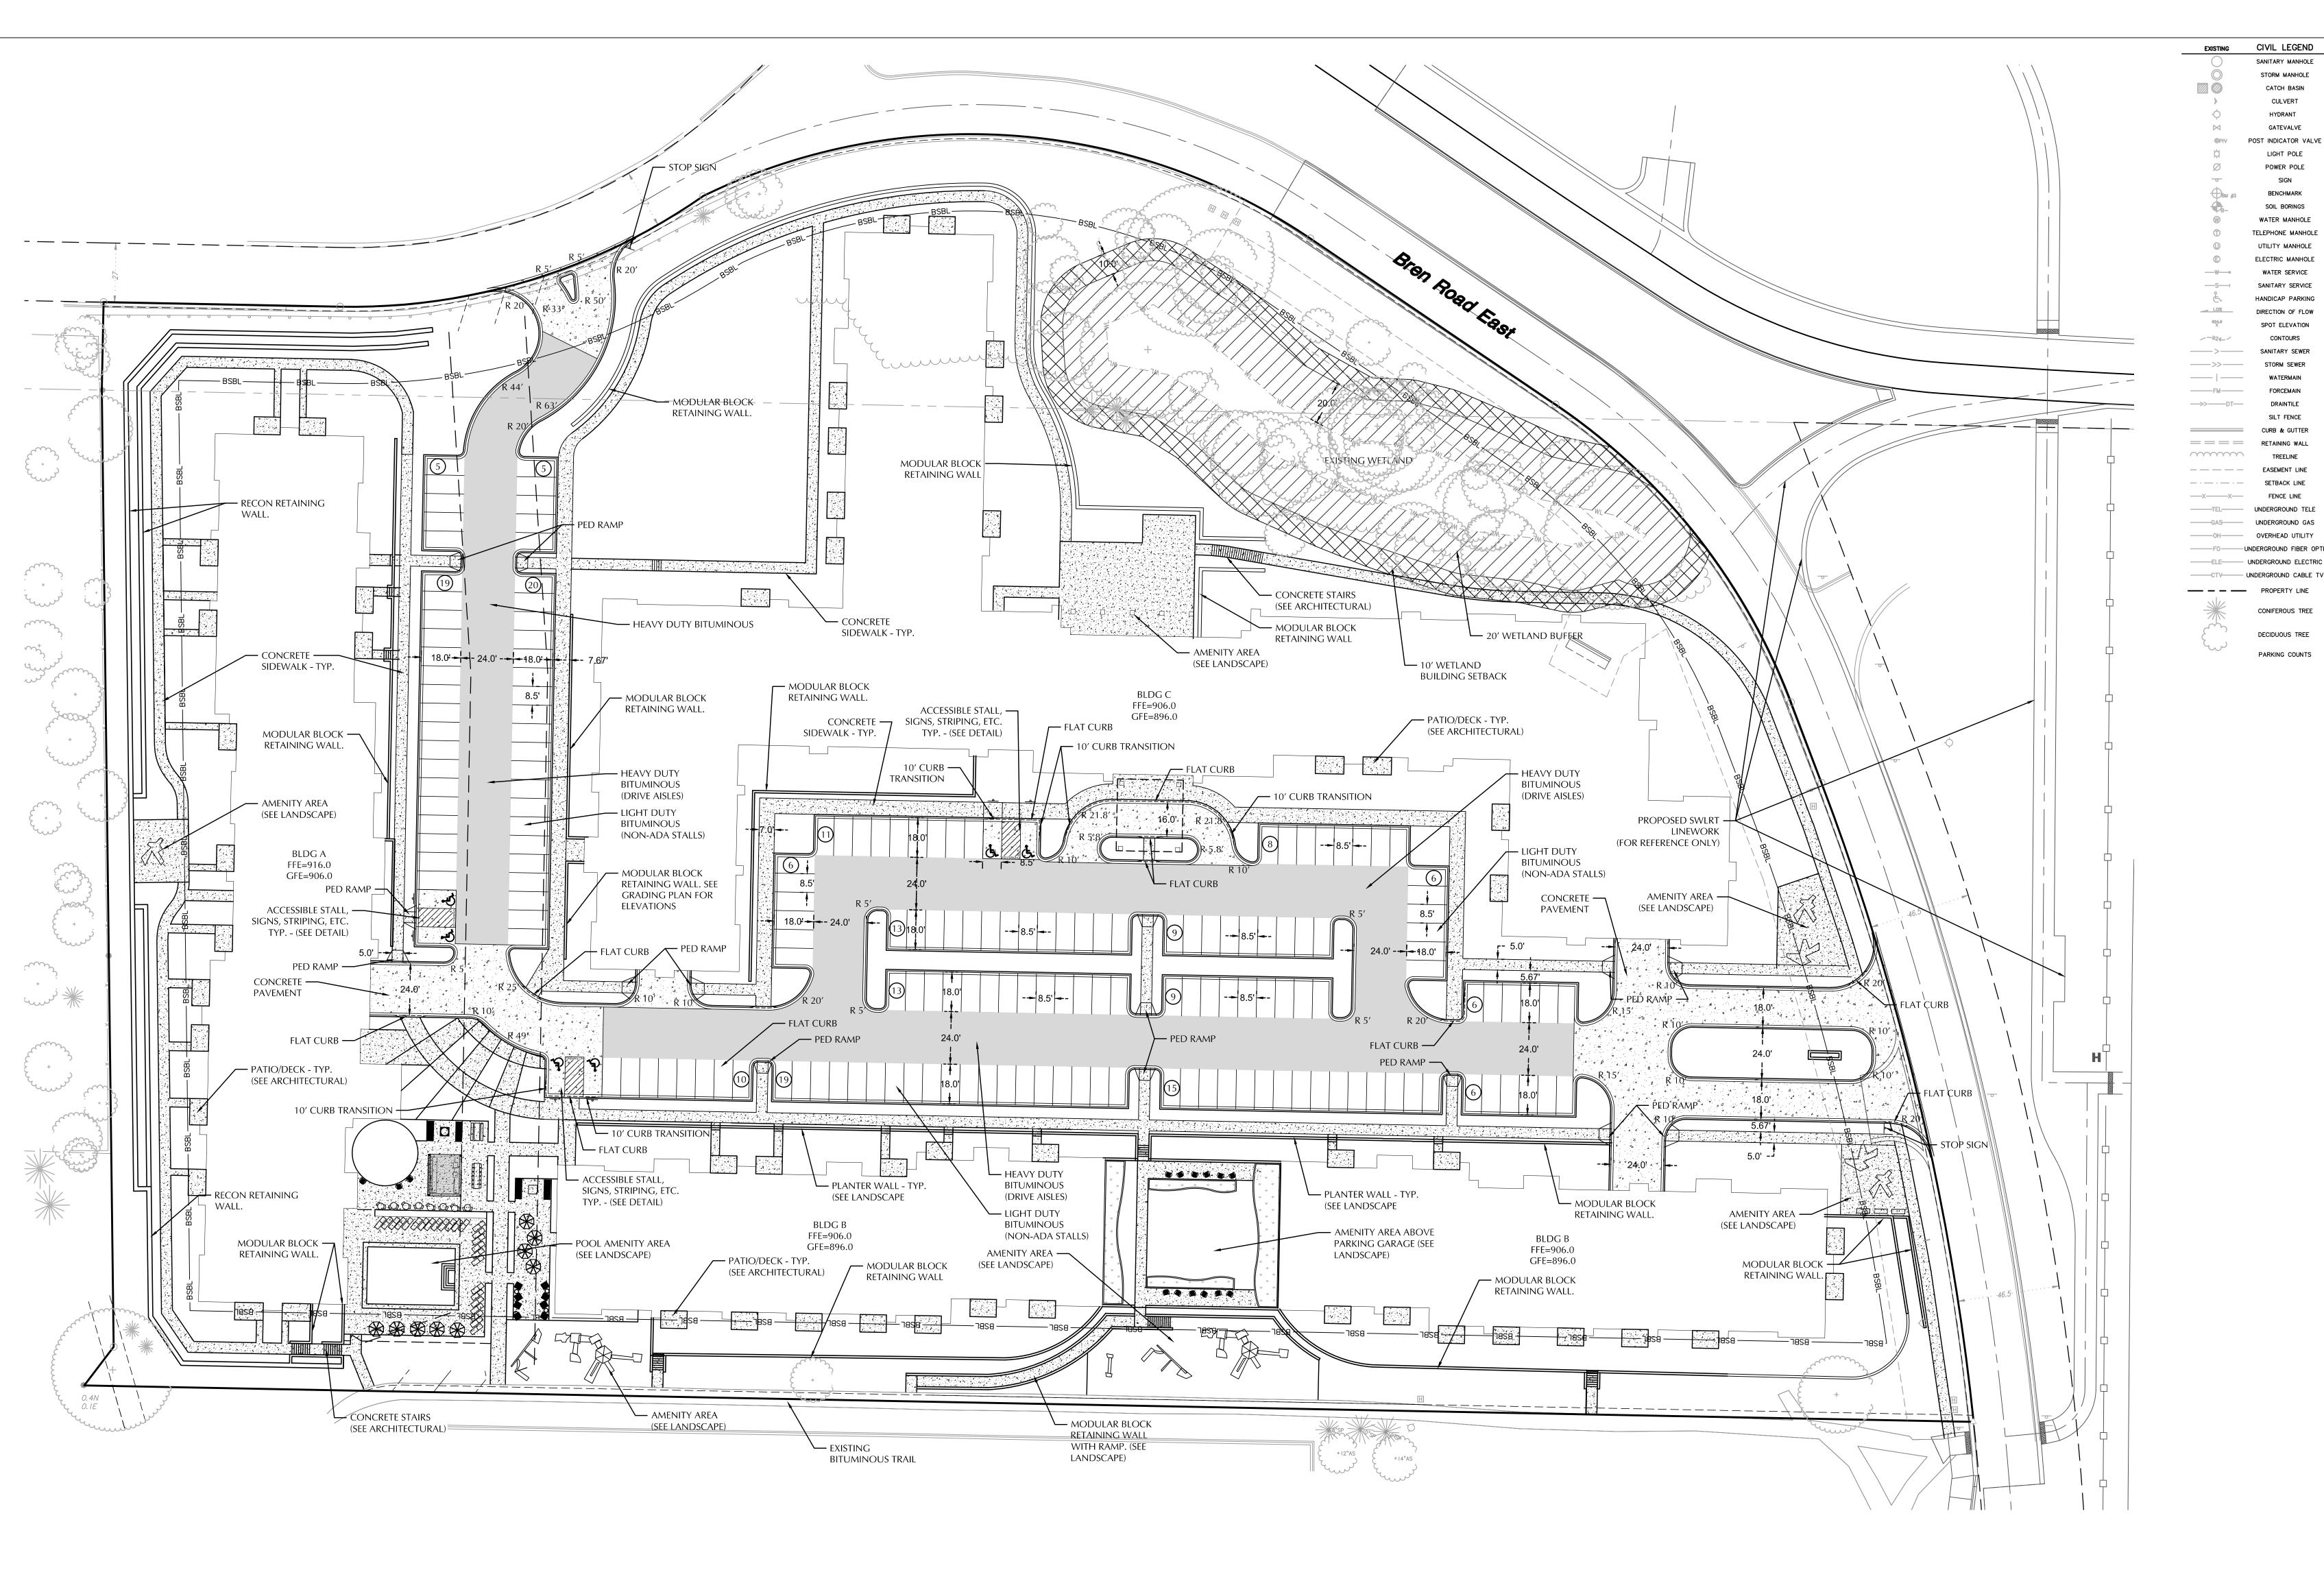

1. ALL PAVING, CONCRETE CURB, GUTTER AND SIDEWALK SHALL BE FURNISHED AND INSTALLED IN ACCORDANCE WITH THE DETAILS SHOWN PER THE DETAIL SHEET(S) AND STATE/LOCAL

JURISDICTION REQUIREMENTS.

2. ACCESSIBLE PARKING AND ACCESSIBLE ROUTES SHALL BE PROVIDED PER CURRENT ADA

STANDARDS AND LOCAL/STATE REQUIREMENTS.

3. ALL CURB DIMENSIONS SHOWN ARE TO THE FACE OF CURB UNLESS OTHERWISE NOTED.

ALL BUILDING DIMENSIONS ARE TO THE OUTSIDE FACE OF WALL UNLESS OTHERWISE NOTED.
 TYPICAL FULL SIZED PARKING STALL IS 8.5' X 18' WITH A 24' WIDE TWO WAY DRIVE UNLESS

OTHERWISE NOTED.

6. ALL CURB RADII SHALL BE 3.0' UNLESS OTHERWISE NOTED.

7. BITUMINOUS IMPREGNATED FIBER BOARD TO BE PLACED AT FULL DEPTH OF CONCRETE ADJACENT TO EXISTING STRUCTURES AND BEHIND CURB ADJACENT TO DRIVEWAYS AND SIDEWALKS.

8. SEE SITE ELECTRICAL PLAN FOR SITE LIGHTING.

9. BITUMINOUS PARKING STALLS TO BE LIGHT DUTY BITUMINOUS. DRIVE ISLES TO BE HEAVY DUTY BITUMINOUS.

OFF-STREET PARKING CALCULATIONS

PROPOSED SURFACE PARKING PROVIDED: 180 STALLS
PROPOSED GARAGE PARKING PROVIDED: 365 STALLS
PROPOSED TOTAL PARKING PROVIDED: 545 STALLS

ACCESSIBLE PARKING

SURFACE ACCESSIBLE PARKING:
GARAGE ACCESSIBLE PARKING:

REQUIRED SURFACE ACCESSIBLE PARKING: 6 STALLS*
REQUIRED GARAGE ACCESSIBLE PARKING: 8 STALLS**

*REQUIRED MINIMUM NUMBER OF ACCESSIBLE SPACES FOR 151-200 STALLS
**REQUIRED MINIMUM NUMBER OF ACCESSIBLE SPACES FOR 301-400 STALLS

6 STALLS

8 STALLS

CURRENT ZONING:
PROPOSED ZONING:
PARKING SETBACK:
BUILDING SETBACK:
PROPERTY AREA:
EXISTING AREA:
PROPOSED IMPERVIOUS AREA:


1.1 (INDUSTRIAL)
PUD
1.0 FT.
9.39 FT.
9.39 AC
5.19 AC (55.3%)
5.70 AC (60.7%)

SITE PLAN LEGEND

CONCRETE SIDEWALK

HEAVY DUTY BITUMINOUS PAVEMENT

CONCRETE PAVEMENT

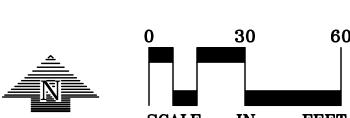



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Maple Grove, MN 55369 763.424.5505 www.loucksinc.com

LOUCKS PROJECT NO. 17298.0A

PROJECT TITLE

BREN ROAD MASTER SITE DEVELOPMENT

OWNER/DEVELOPER



ISSUE # DATE DESCRIPTION

1 04/06/2018 CITY SUBMITTAL

CONSTRUCTION

CERTIFICATION


I hereby certify that this plan, specification or report was prepared by me or under my direct supervision and that I am a duly Licensed Professional Engineer under the laws of the State of Minnesota.

PJ Disch	, PE
49933	XX/XX/XXXX
License Number	Date
DATE	03/30/2018
DRAWN BY	SRT
CHECKED BY	PJD
COMMISSION NUMBER	1393.123
SHEET TITLE	

SITE PLAN

SHEET NUMBER

C2-

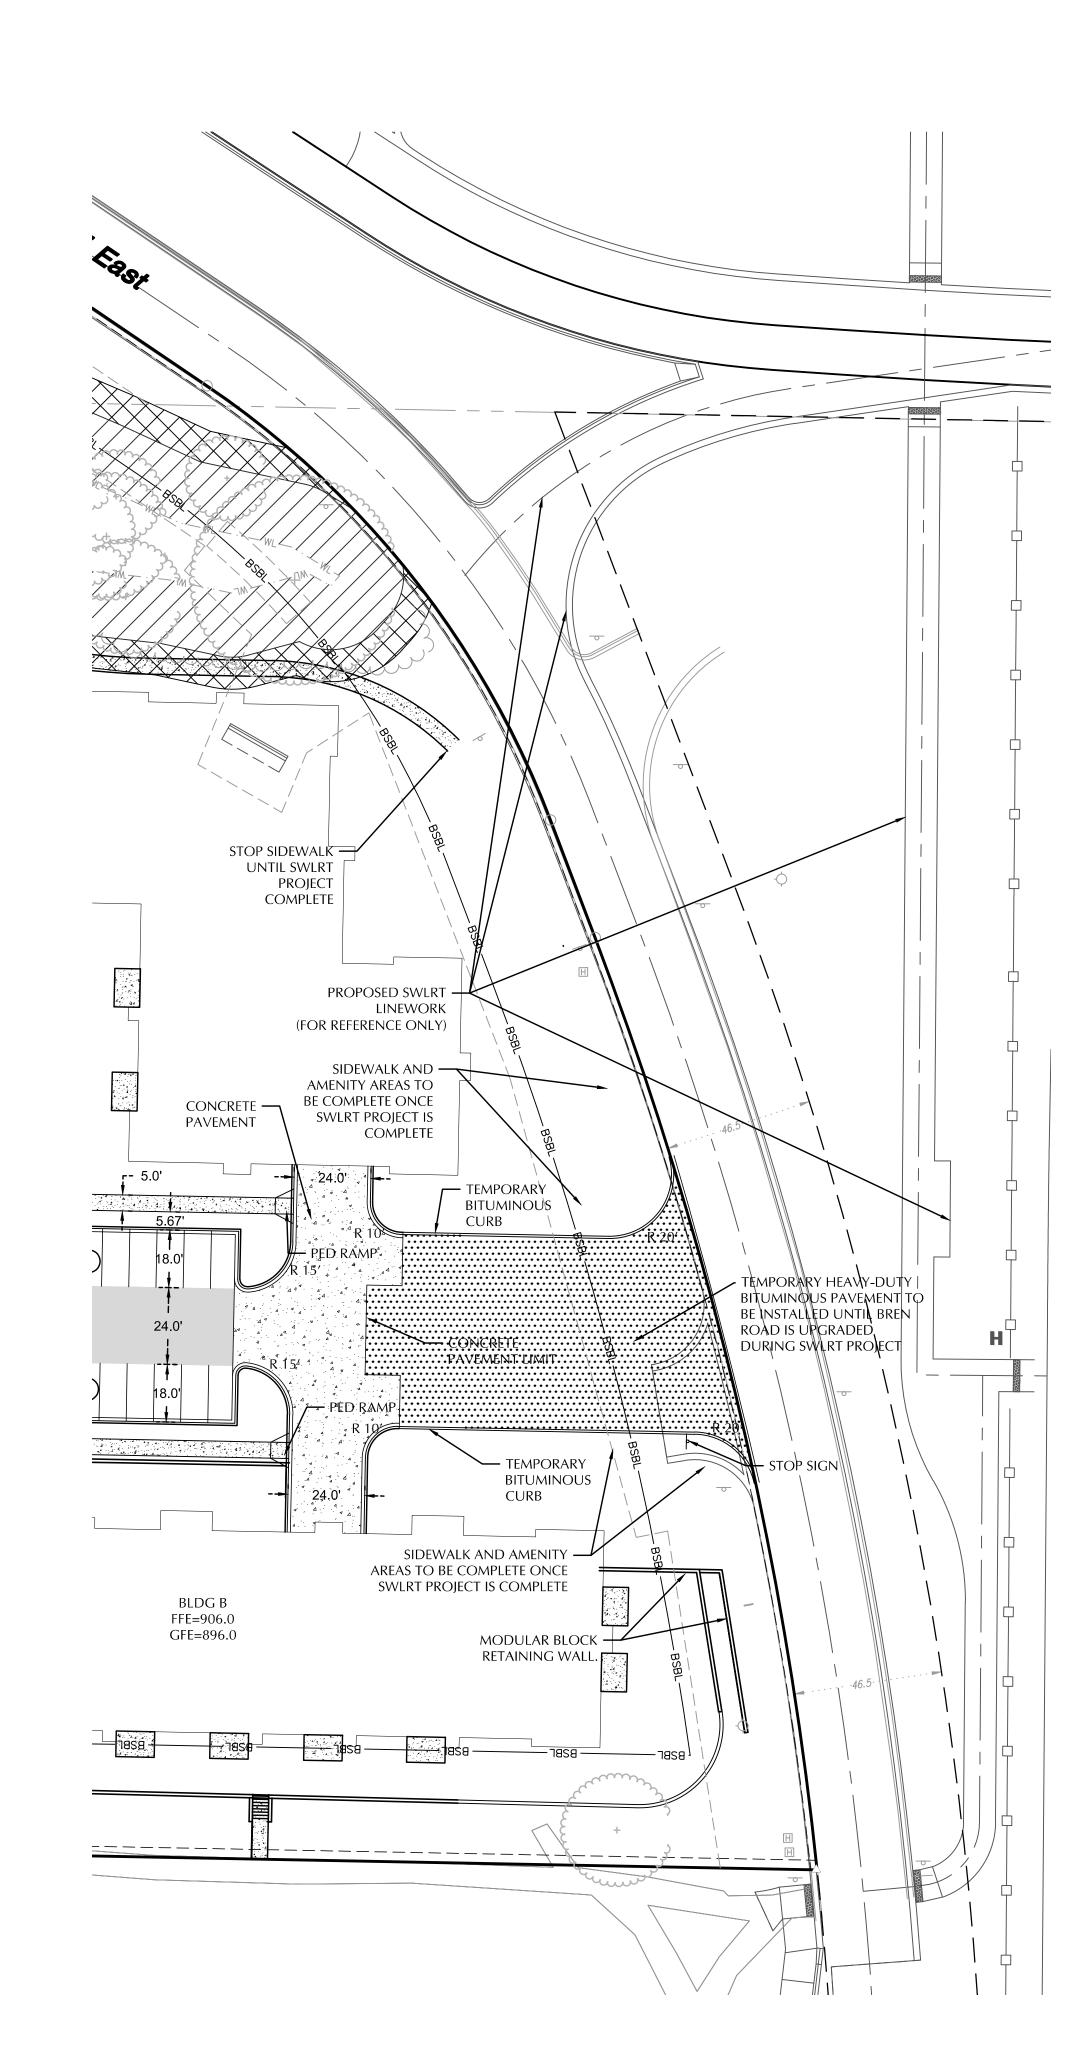

SOIL BORINGS WATER MANHOLE TELEPHONE MANHOLE SETBACK LINE - · - · - · -TEL— UNDERGROUND TELE ----GAS------ UNDERGROUND GAS ----OH----- OVERHEAD UTILITY -----FO-------UNDERGROUND FIBER OPTIC ----ELE---- UNDERGROUND ELECTRIC -----CTV------ UNDERGROUND CABLE TV DECIDUOUS TREE

EXISTING CIVIL LEGEND

CATCH BASIN CULVERT HYDRANT GATEVALVE POST INDICATOR VALVE

POWER POLE

Architecture

Interior Design Landscape Architecture Engineering

> Boarman Kroos Group

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SHEET TITLE					

TEMPORARY PLAN

SHEET NUMBER

SITE PLAN LEGEND

1. ALL PAVING, CONCRETE CURB, GUTTER AND SIDEWALK SHALL BE FURNISHED AND INSTALLED

IN ACCORDANCE WITH THE DETAILS SHOWN PER THE DETAIL SHEET(S) AND STATE/LOCAL

2. ACCESSIBLE PARKING AND ACCESSIBLE ROUTES SHALL BE PROVIDED PER CURRENT ADA

3. ALL CURB DIMENSIONS SHOWN ARE TO THE FACE OF CURB UNLESS OTHERWISE NOTED.

4. ALL BUILDING DIMENSIONS ARE TO THE OUTSIDE FACE OF WALL UNLESS OTHERWISE NOTED.

5. TYPICAL FULL SIZED PARKING STALL IS 8.5' X 18' WITH A 24' WIDE TWO WAY DRIVE UNLESS

7. BITUMINOUS IMPREGNATED FIBER BOARD TO BE PLACED AT FULL DEPTH OF CONCRETE

9. BITUMINOUS PARKING STALLS TO BE LIGHT DUTY BITUMINOUS. DRIVE ISLES TO BE HEAVY

ADJACENT TO EXISTING STRUCTURES AND BEHIND CURB ADJACENT TO DRIVEWAYS AND

JURISDICTION REQUIREMENTS.

OTHERWISE NOTED.

DUTY BITUMINOUS.

SIDEWALKS.

STANDARDS AND LOCAL/STATE REQUIREMENTS.

8. SEE SITE ELECTRICAL PLAN FOR SITE LIGHTING.

6. ALL CURB RADII SHALL BE 3.0' UNLESS OTHERWISE NOTED.

CONCRETE SIDEWALK

HEAVY DUTY BITUMINOUS PAVEMENT


CONCRETE PAVEMENT TEMPORARY HEAVY-DUTY BITUMINOUS PAVEMENT



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1. SPOT ELEVATIONS REPRESENT FINISHED SURFACE GRADES, GUTTER/FLOW LINE, FACE OF BUILDING, OR EDGE OF PAVEMENT UNLESS OTHERWISE NOTED.


2. CATCH BASINS AND MANHOLES IN PAVED AREAS SHALL BE SUMPED 0.04 FEET. ALL CATCH BASINS IN GUTTERS SHALL BE SUMPED 0.16 FEET. RIM ELEVATIONS SHOWN ON PLANS DO NOT REFLECT SUMPED ELEVATIONS.

3. ALL DISTURBED UNPAVED AREAS ARE TO RECEIVE MINIMUM OF 4 INCHES OF TOP SOIL AND SEED/MULCH OR SOD. THESE AREAS SHALL BE WATERED/MAINTAINED BY THE CONTRACTOR UNTIL VEGETATION IS ESTABLISHED.

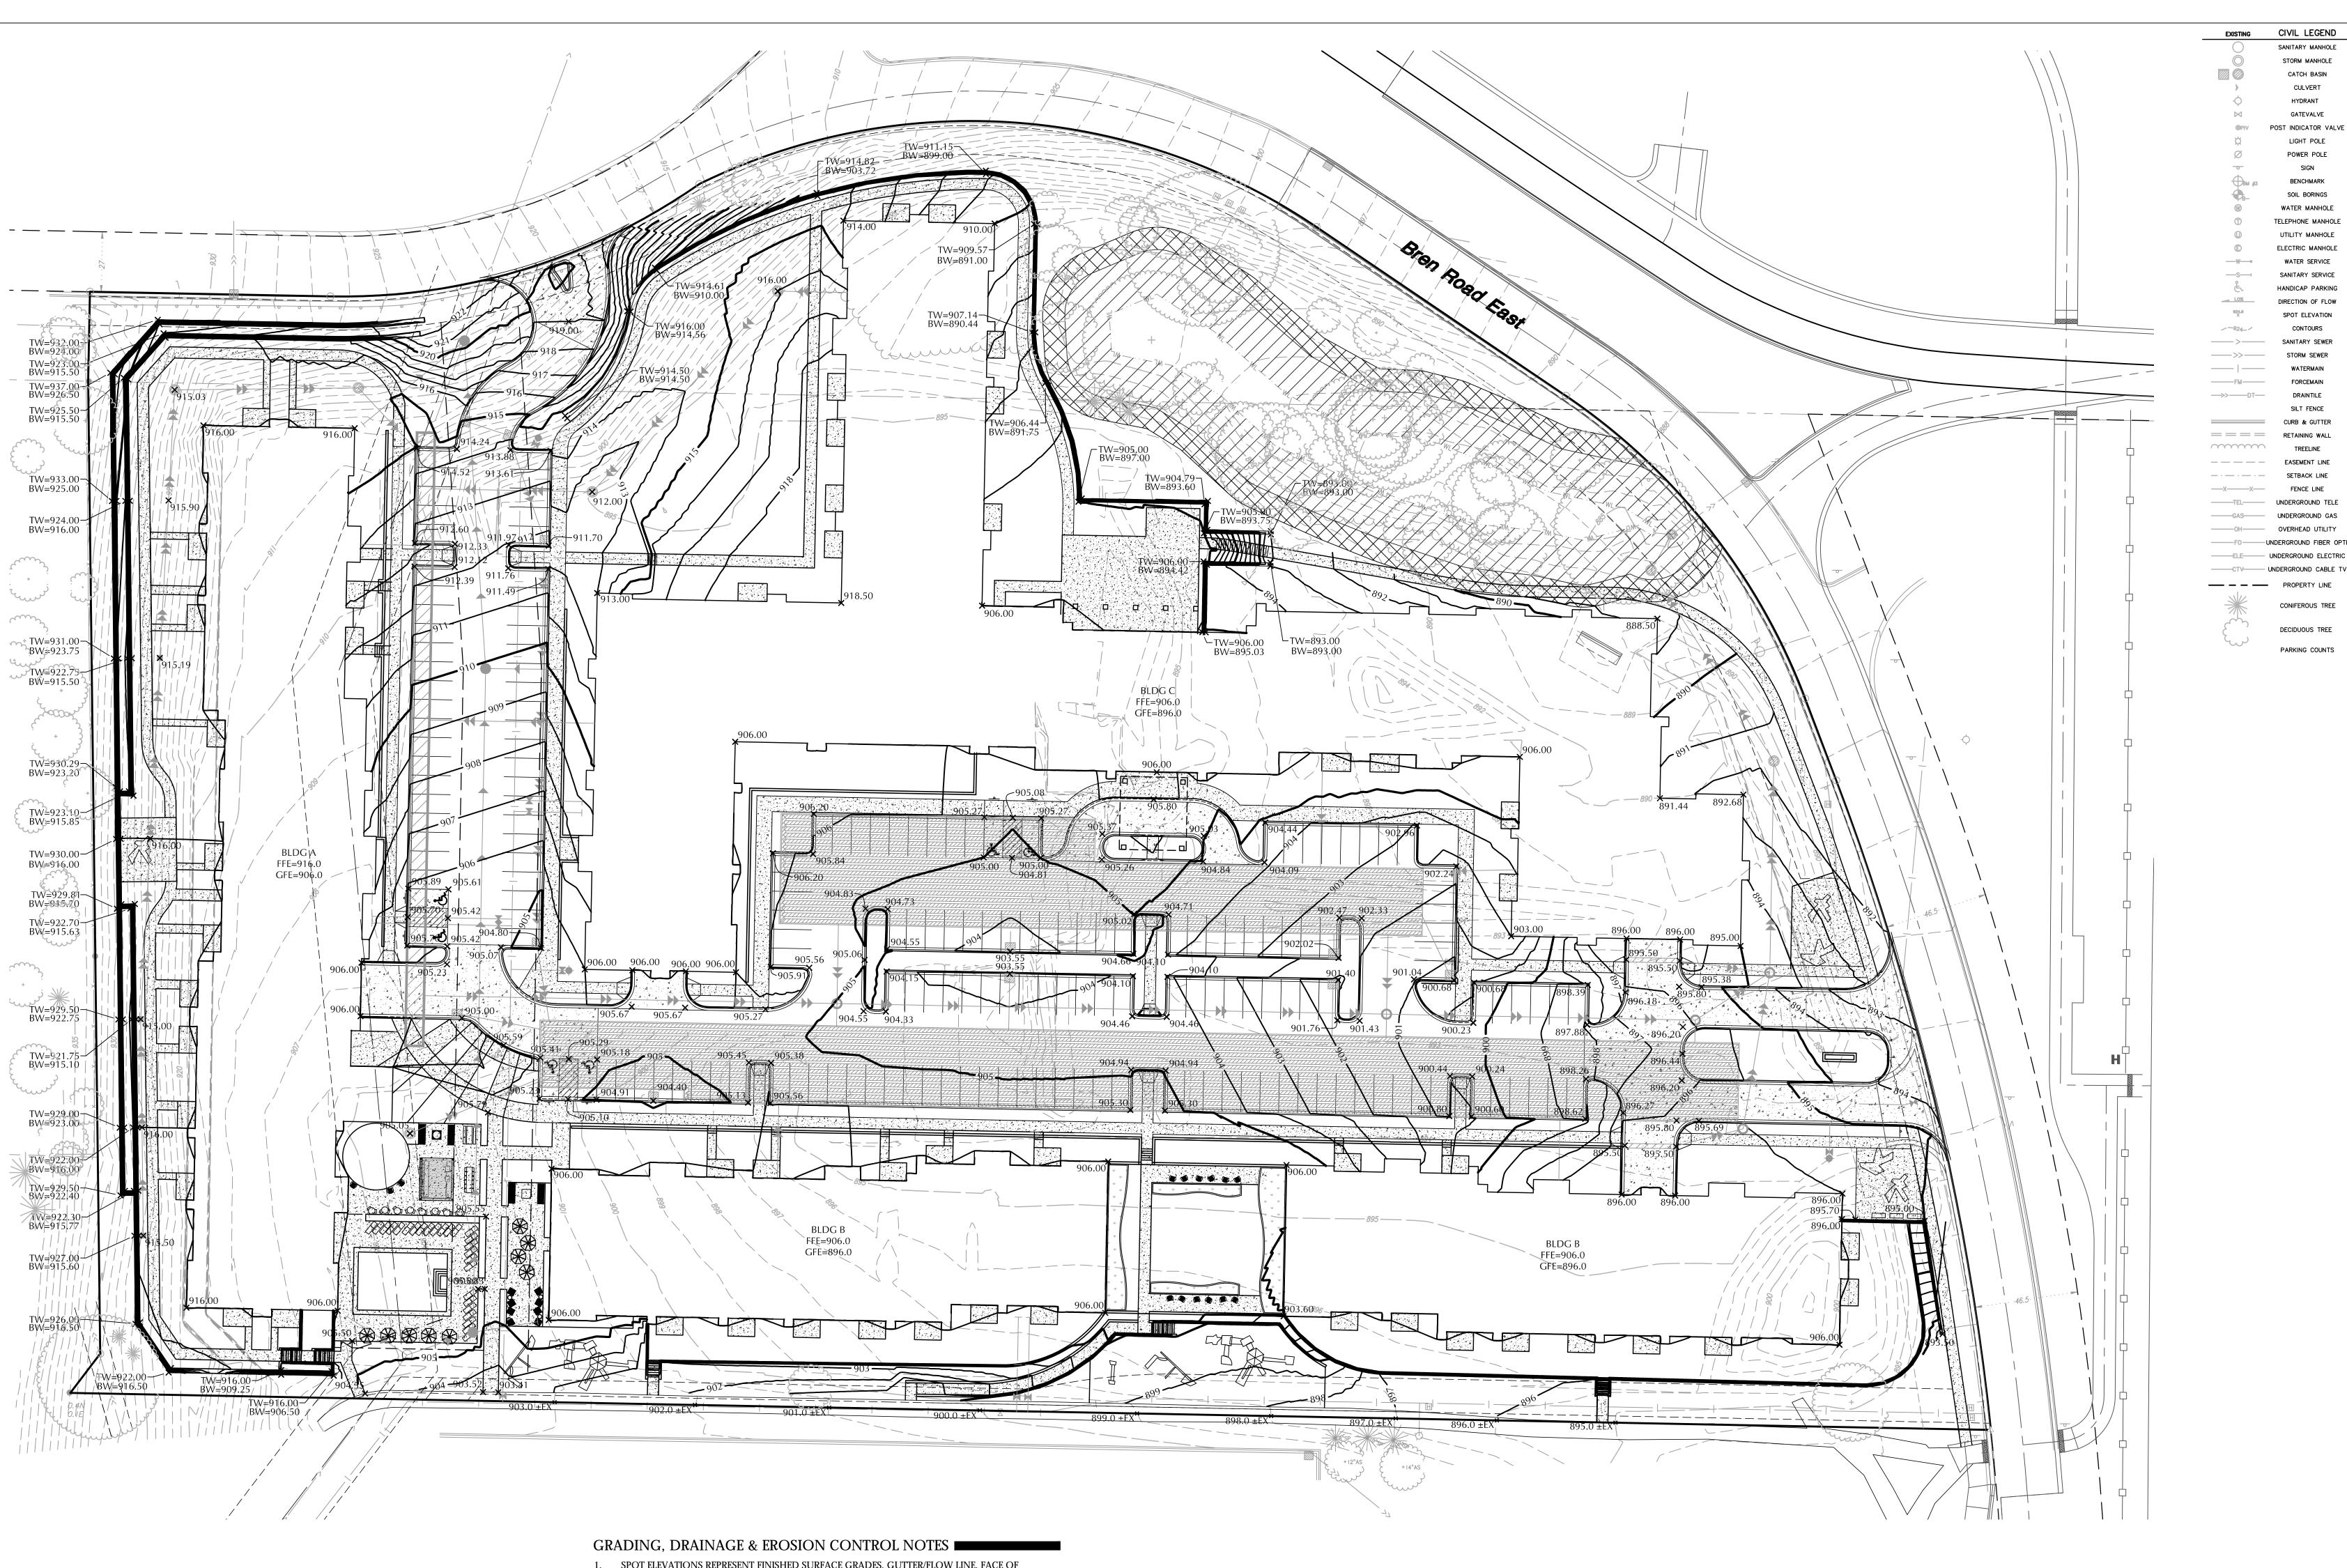4. FOR SITE RETAINING WALLS "TW" EQUALS SURFACE GRADE AT TOP FACE OF WALL (NOT TOP OF WALL), "GW" EQUALS SURFACE GRADE AT WALL GRADE TRANSITION, AND "BW" EQUALS SURFACE GRADE AT BOTTOM FACE OF WALL (NOT BOTTOM OF BURIED WALL COURSES).

5. STREETS MUST BE CLEANED AND SWEPT WHENEVER TRACKING OF SEDIMENTS OCCURS AND BEFORE SITES ARE LEFT IDLE FOR WEEKENDS AND HOLIDAYS. A REGULAR SWEEPING SCHEDULE MUST

- 6. DUST MUST BE ADEQUATELY CONTROLLED.
- 7. SEE SWPPP FOR ADDITIONAL EROSION CONTROL NOTES AND REQUIREMENTS.
- 8. SEE UTILITY PLANS FOR WATER, STORM AND SANITARY SEWER INFORMATION.
- 9. SEE SITE PLAN FOR CURB AND BITUMINOUS TAPER LOCATIONS.
- 10. SEE LANDSCAPE PLAN FOR FINAL SITE STABILIZATION.

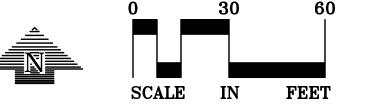



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Architecture Interior Design Landscape Architecture Engineering

Boarman Kroos Group

CATCH BASIN

DECIDUOUS TREE

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PJ Disch, PE XX/XX/XXXX License Number | 03/30/2018 DRAWN BY SRT CHECKED BY COMMISSION NUMBER 1393.123


GRADING

PLAN

SHEET NUMBER

SHEET TITLE

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Architecture
Interior Design
Landscape Architecture
Engineering

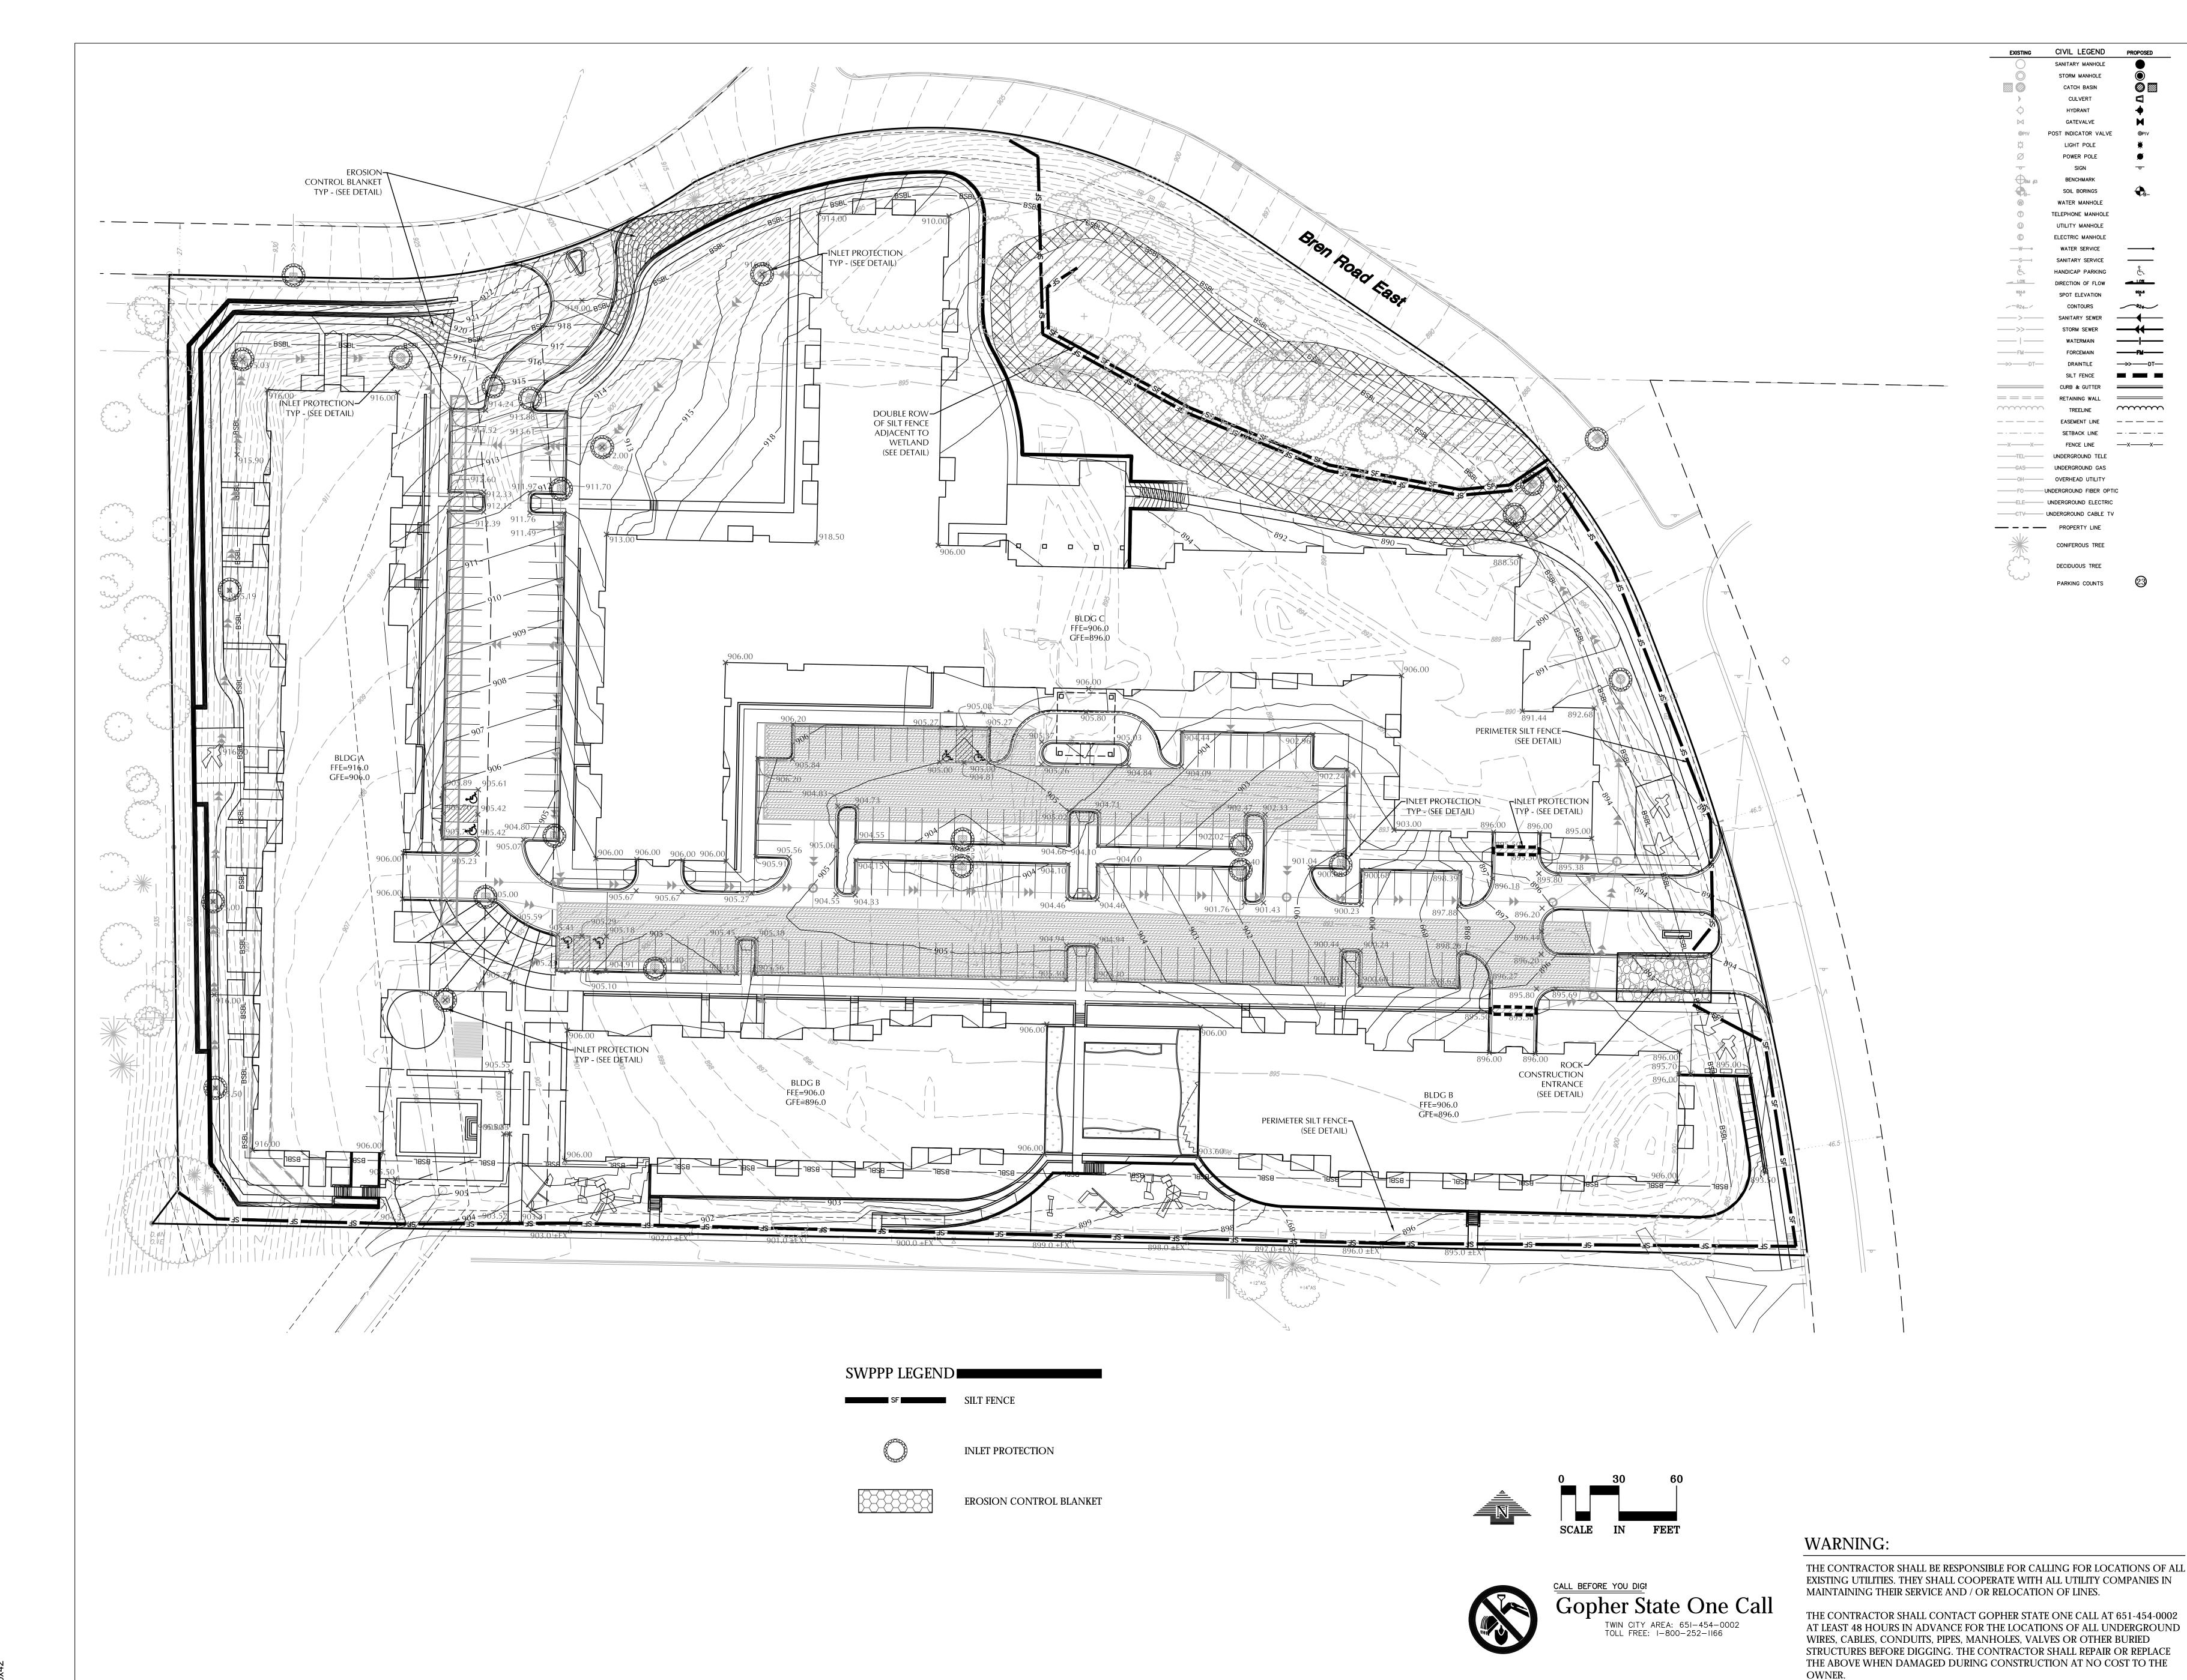Boarman Kroos Vogel Group Inc.

222 North Second Street Minneapolis MN 55401 Telephone: 612-339-3752 Facsimile: 612-339-6212 www.bkvgroup.com EOE

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LANDSCAPE ARCHITECTURE
ENVIRONMENTAL

7200 Hemlock Lane, Suite 300 Maple Grove, MN 55369 763.424.5505 www.loucksinc.com

LOUCKS PROJECT NO. 17298.0A

PROJECT TITLE

BREN ROAD MASTER SITE DEVELOPMENT

OWNER/DEVELOPER



ISSUE # DATE DESCRIPTION

1 04/06/2018 CITY SUBMITTAL

CONSTRUCTION

CERTIFICATION

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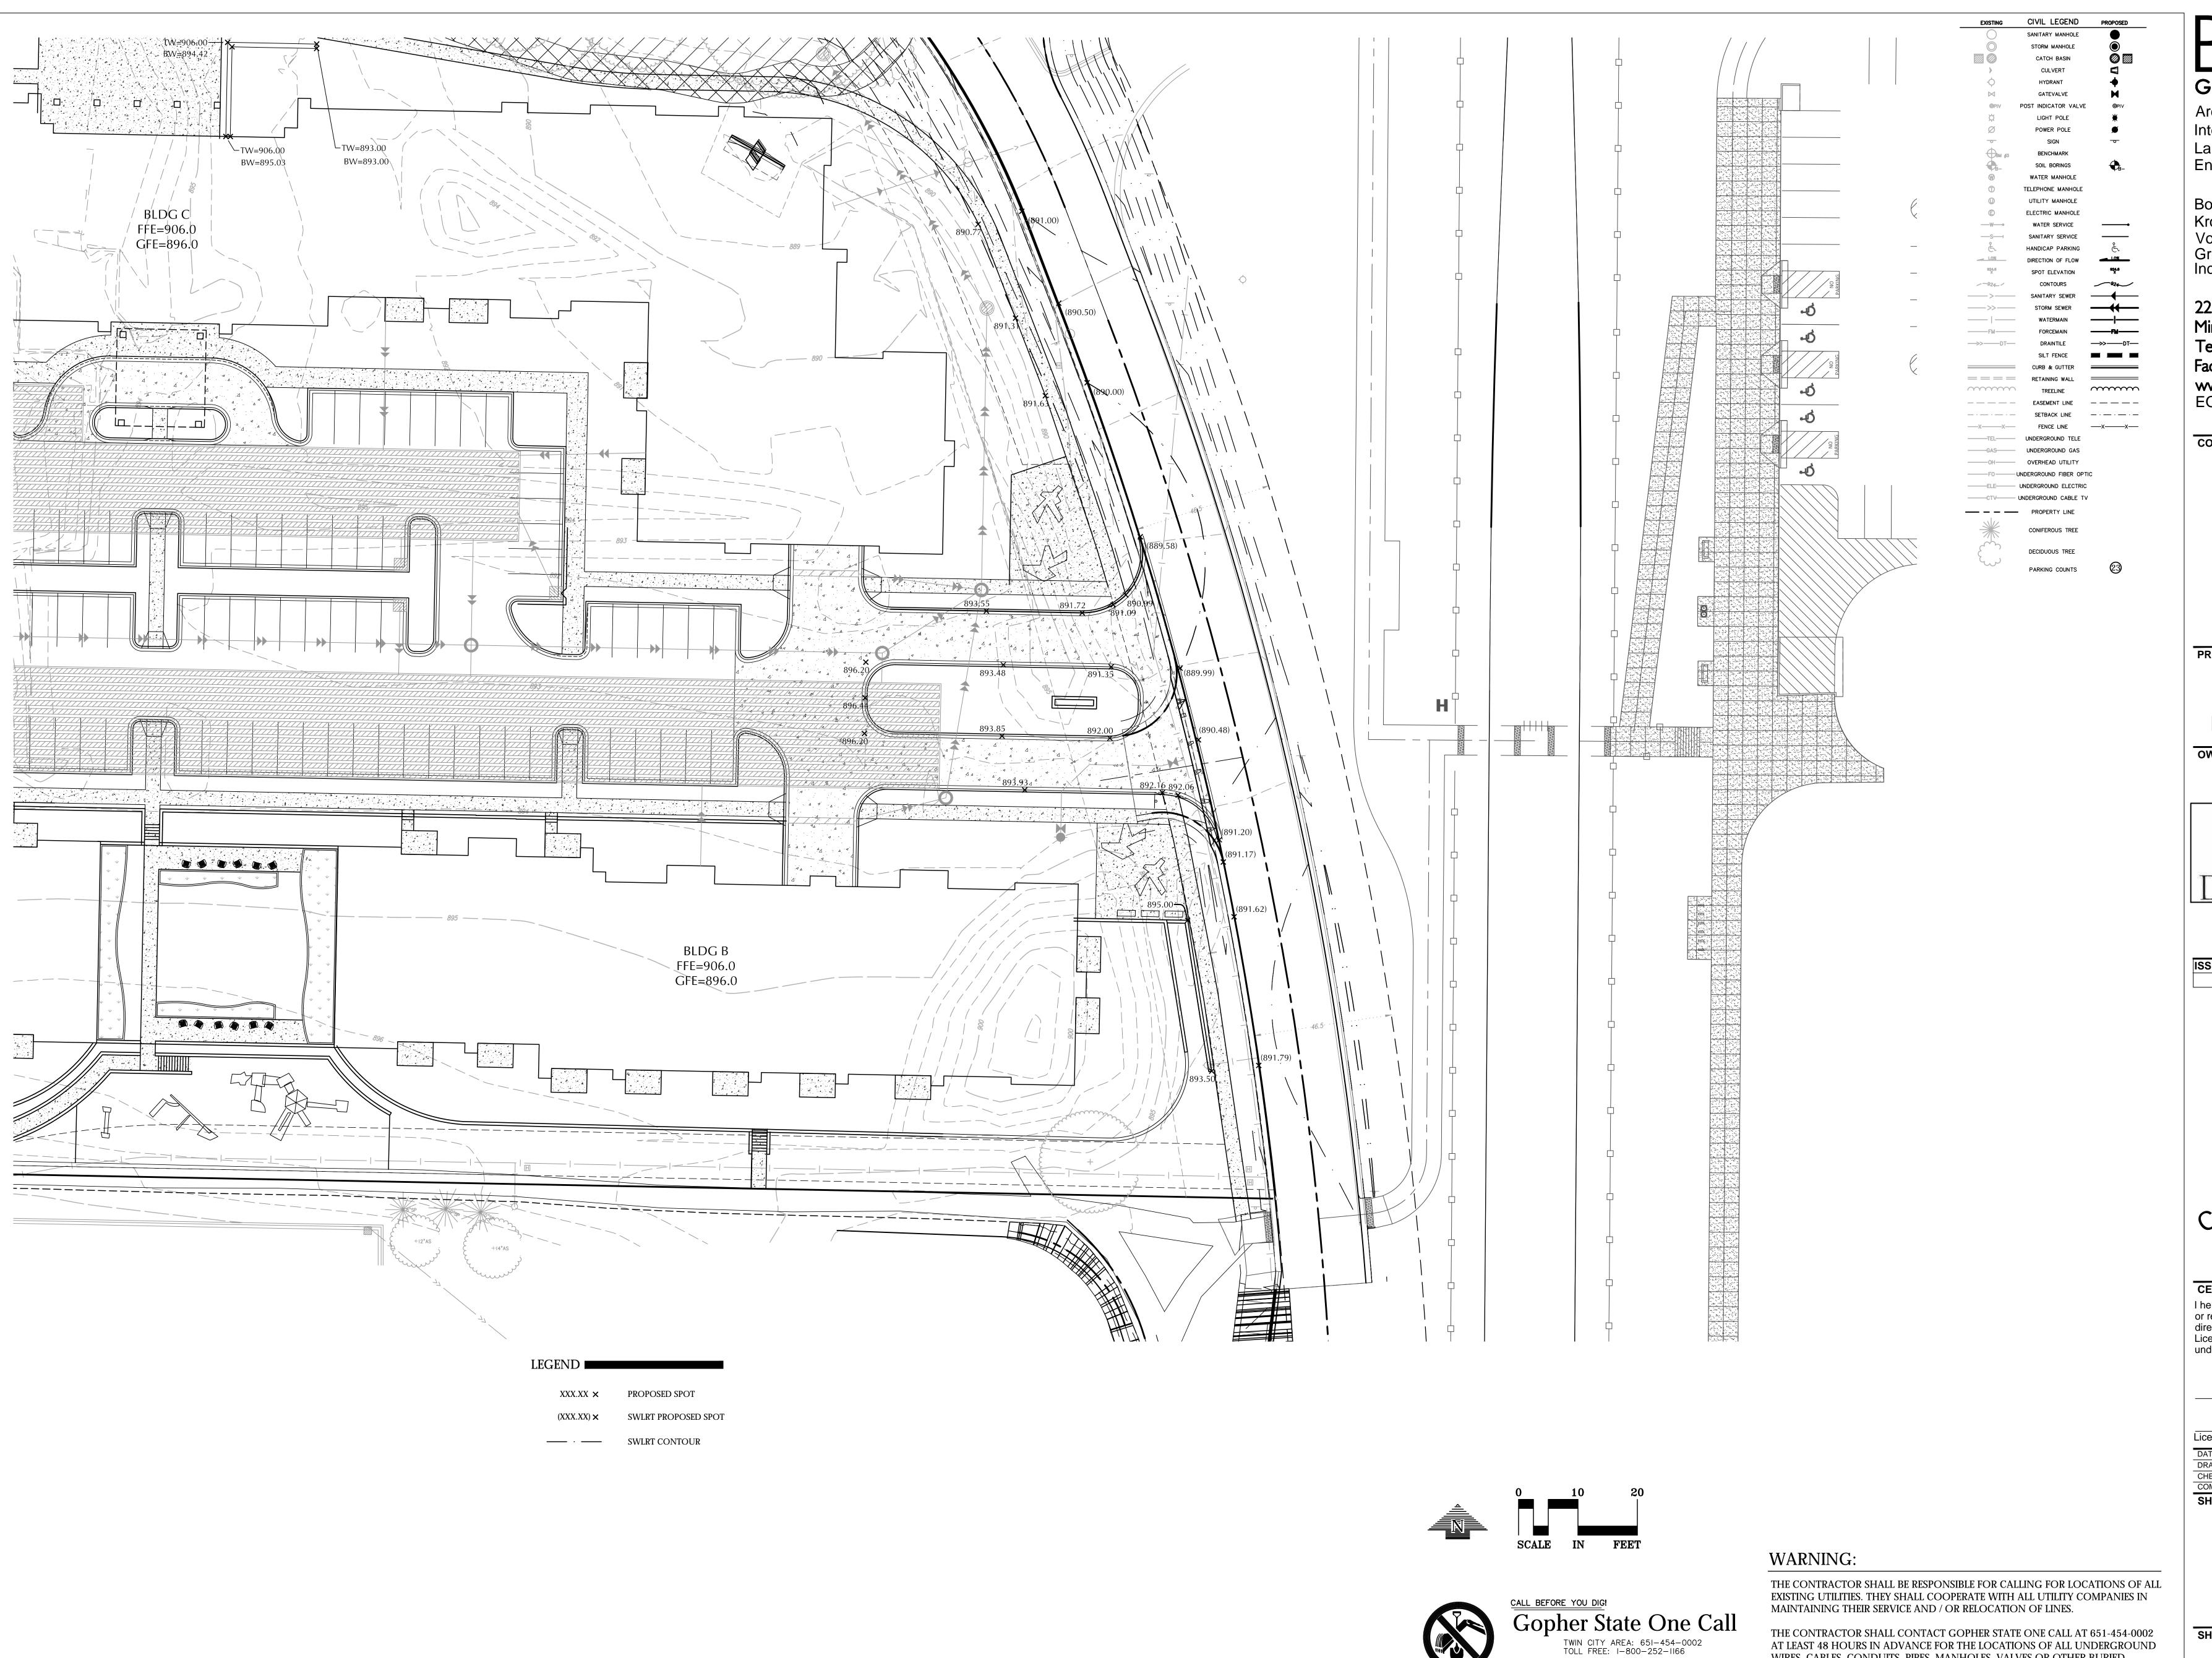
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DATE	03/30/2018
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SWPPP

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C3-2



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SHEET TITLE

FUTURE ENTRANCE PLAN


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WIRES, CABLES, CONDUITS, PIPES, MANHOLES, VALVES OR OTHER BURIED STRUCTURES BEFORE DIGGING. THE CONTRACTOR SHALL REPAIR OR REPLACE THE ABOVE WHEN DAMAGED DURING CONSTRUCTION AT NO COST TO THE


OWNER.

C3-4



UTILITY NOTES

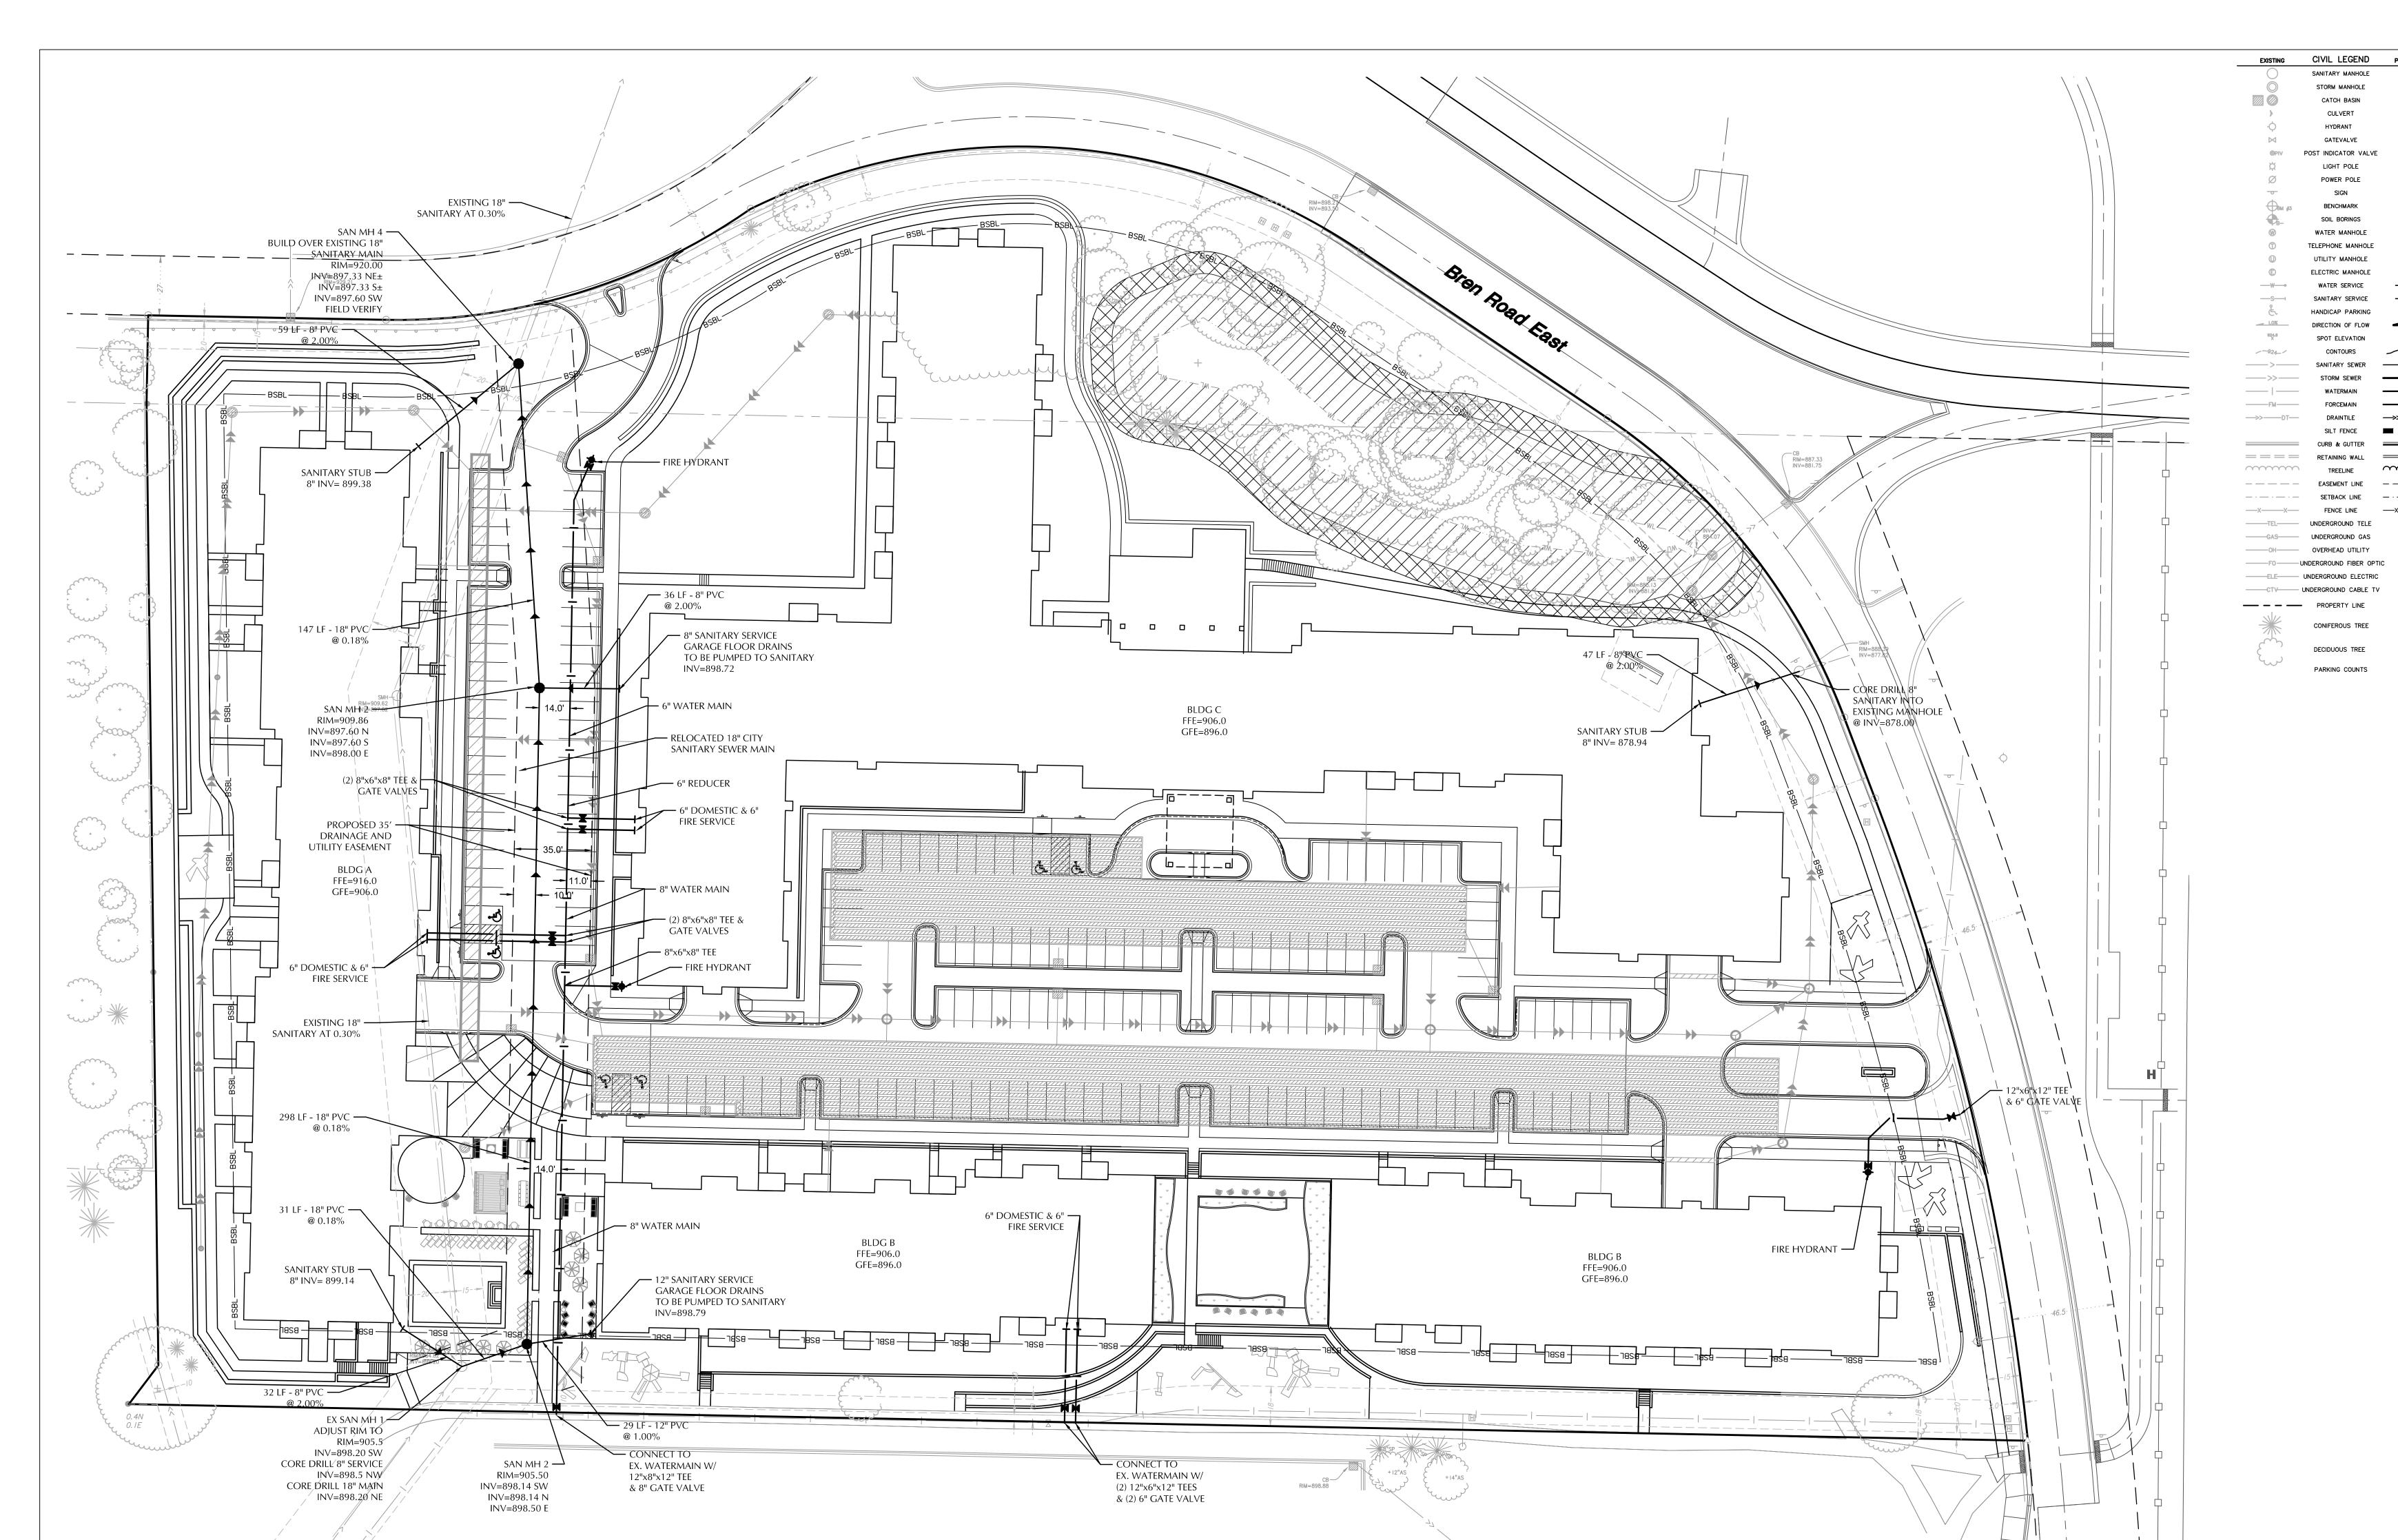- 1. ALL SANITARY SEWER, STORM SEWER AND WATERMAIN UTILITIES SHALL BE FURNISHED AND INSTALLED PER THE REQUIREMENTS OF THE SPECIFICATIONS, THE MINNESOTA PLUMBING CODE, THE LOCAL GOVERNING UNIT, AND THE STANDARD UTILITIES SPECIFICATION OF THE CITY ENGINEERS ASSOCIATION OF MINNESOTA (CEAM), 2013 EDITION.
- 2. ALL UTILITY PIPE BEDDING SHALL BE COMPACTED SAND OR FINE GRANULAR MATERIAL. ALL COMPACTION SHALL BE PERFORMED PER THE REQUIREMENTS OF THE CEAM SPECIFICATION.
- 3. ALL CONNECTIONS TO EXISTING UTILITIES SHALL BE PERFORMED PER THE REQUIREMENTS OF THE STATE AND LOCAL JURISDICTIONS. THE CITY DEPARTMENT OF ENGINEERING AND BUILDING INSPECTIONS DEPARTMENT AND THE CONSTRUCTION ENGINEER MUST BE NOTIFIED AT LEAST 48 HOURS PRIOR TO ANY WORK WITHIN THE PUBLIC RIGHT OF WAY, OR WORK IMPACTING PUBLIC UTILITIES.
- 4. ALL STORM SEWER, SANITARY SEWER AND WATER SERVICES SHALL TERMINATE 5' FROM THE BUILDING FACE UNLESS OTHERWISE NOTED.
- 5. A MINIMUM OF 18 INCHES OF VERTICAL SEPARATION AND 10 FEET OF HORIZONTAL SEPARATION IS REQUIRED FOR ALL UTILITES UNLESS OTHERWISE NOTED.
- 6. ALL NEW WATERMAIN AND SERVICES MUST HAVE A MINIMUM OF 8.0 FEET OF COVER. EXTRA DEPTH MAY BE REQUIRED TO MAINTAIN A MINIMUM 18" VERTICAL SEPARATION TO SANITARY OR STORM SEWER LINES. THE CONTRACTOR SHALL FIELD ADJUST WATERMAIN TO AVOID CONFLICTS WITH SANITARY SEWER, STORM SEWER, AND SERVICES AS REQUIRED. INSULATION OF WATER AND SANITARY SEWER LINES SHALL BE PROVIDED WHERE 8.0 FEET MINIMUM DEPTH CAN NOT BE ATTAINED.
- 7. ALL FIRE HYDRANTS SHALL BE LOCATED 5 FEET BEHIND BACK OF CURB OR EDGE OF PAVEMENT UNLESS OTHERWISE NOTED.
- 8. ALL SANITARY SEWER WYES, TEES AND SERVICES SHALL BE SCH. 40 PVC.
- 9. ALL PORTIONS OF THE STORM SEWER SYSTEM, INCLUDING CATCH BASINS, LOCATED WITHIN 10 FEET OF THE BUILDING OR WATER SERVICE LINE MUST BE TESTED ACCORDANCE WITH MINNESOTA RULES, PART 4715.2820
- 10. ALL JOINTS AND CONNECTIONS IN THE STORM SEWER SYSTEM SHALL BE GASTIGHT OR WATERTIGHT (SEE MINNESOTA RULES, PART 4715.0700). APPROVED RESILIENT RUBBER JOINTS MUST BE USED TO MAKE WATERTIGHT CONNECTIONS TO MANHOLES, CATCHBASINS, AND OTHER STRUCTURES.
- 11. HIGH-DENSITY POLYETHYLENE (HDPE) STORM DRAINS MUST COMPLY WITH MINNESOTA RULES, PART 4715.0540:
- a. PIPES 4-INCH TO 10-INCH IN SIZE MUST COMPLY WITH AASHTO M252.
 b. PIPES 12-INCH TO 60-INCH IN SIZE MUST COMPLY WITH ASTM F2306.
- c. ALL FITTINGS MUST COMPLY WITH ASTM D3212.d. WATER-TIGHT JOINTS MUST BE USED AT ALL CONNECTIONS INCLUDING STRUCTURES.

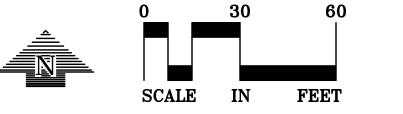



WARNING:

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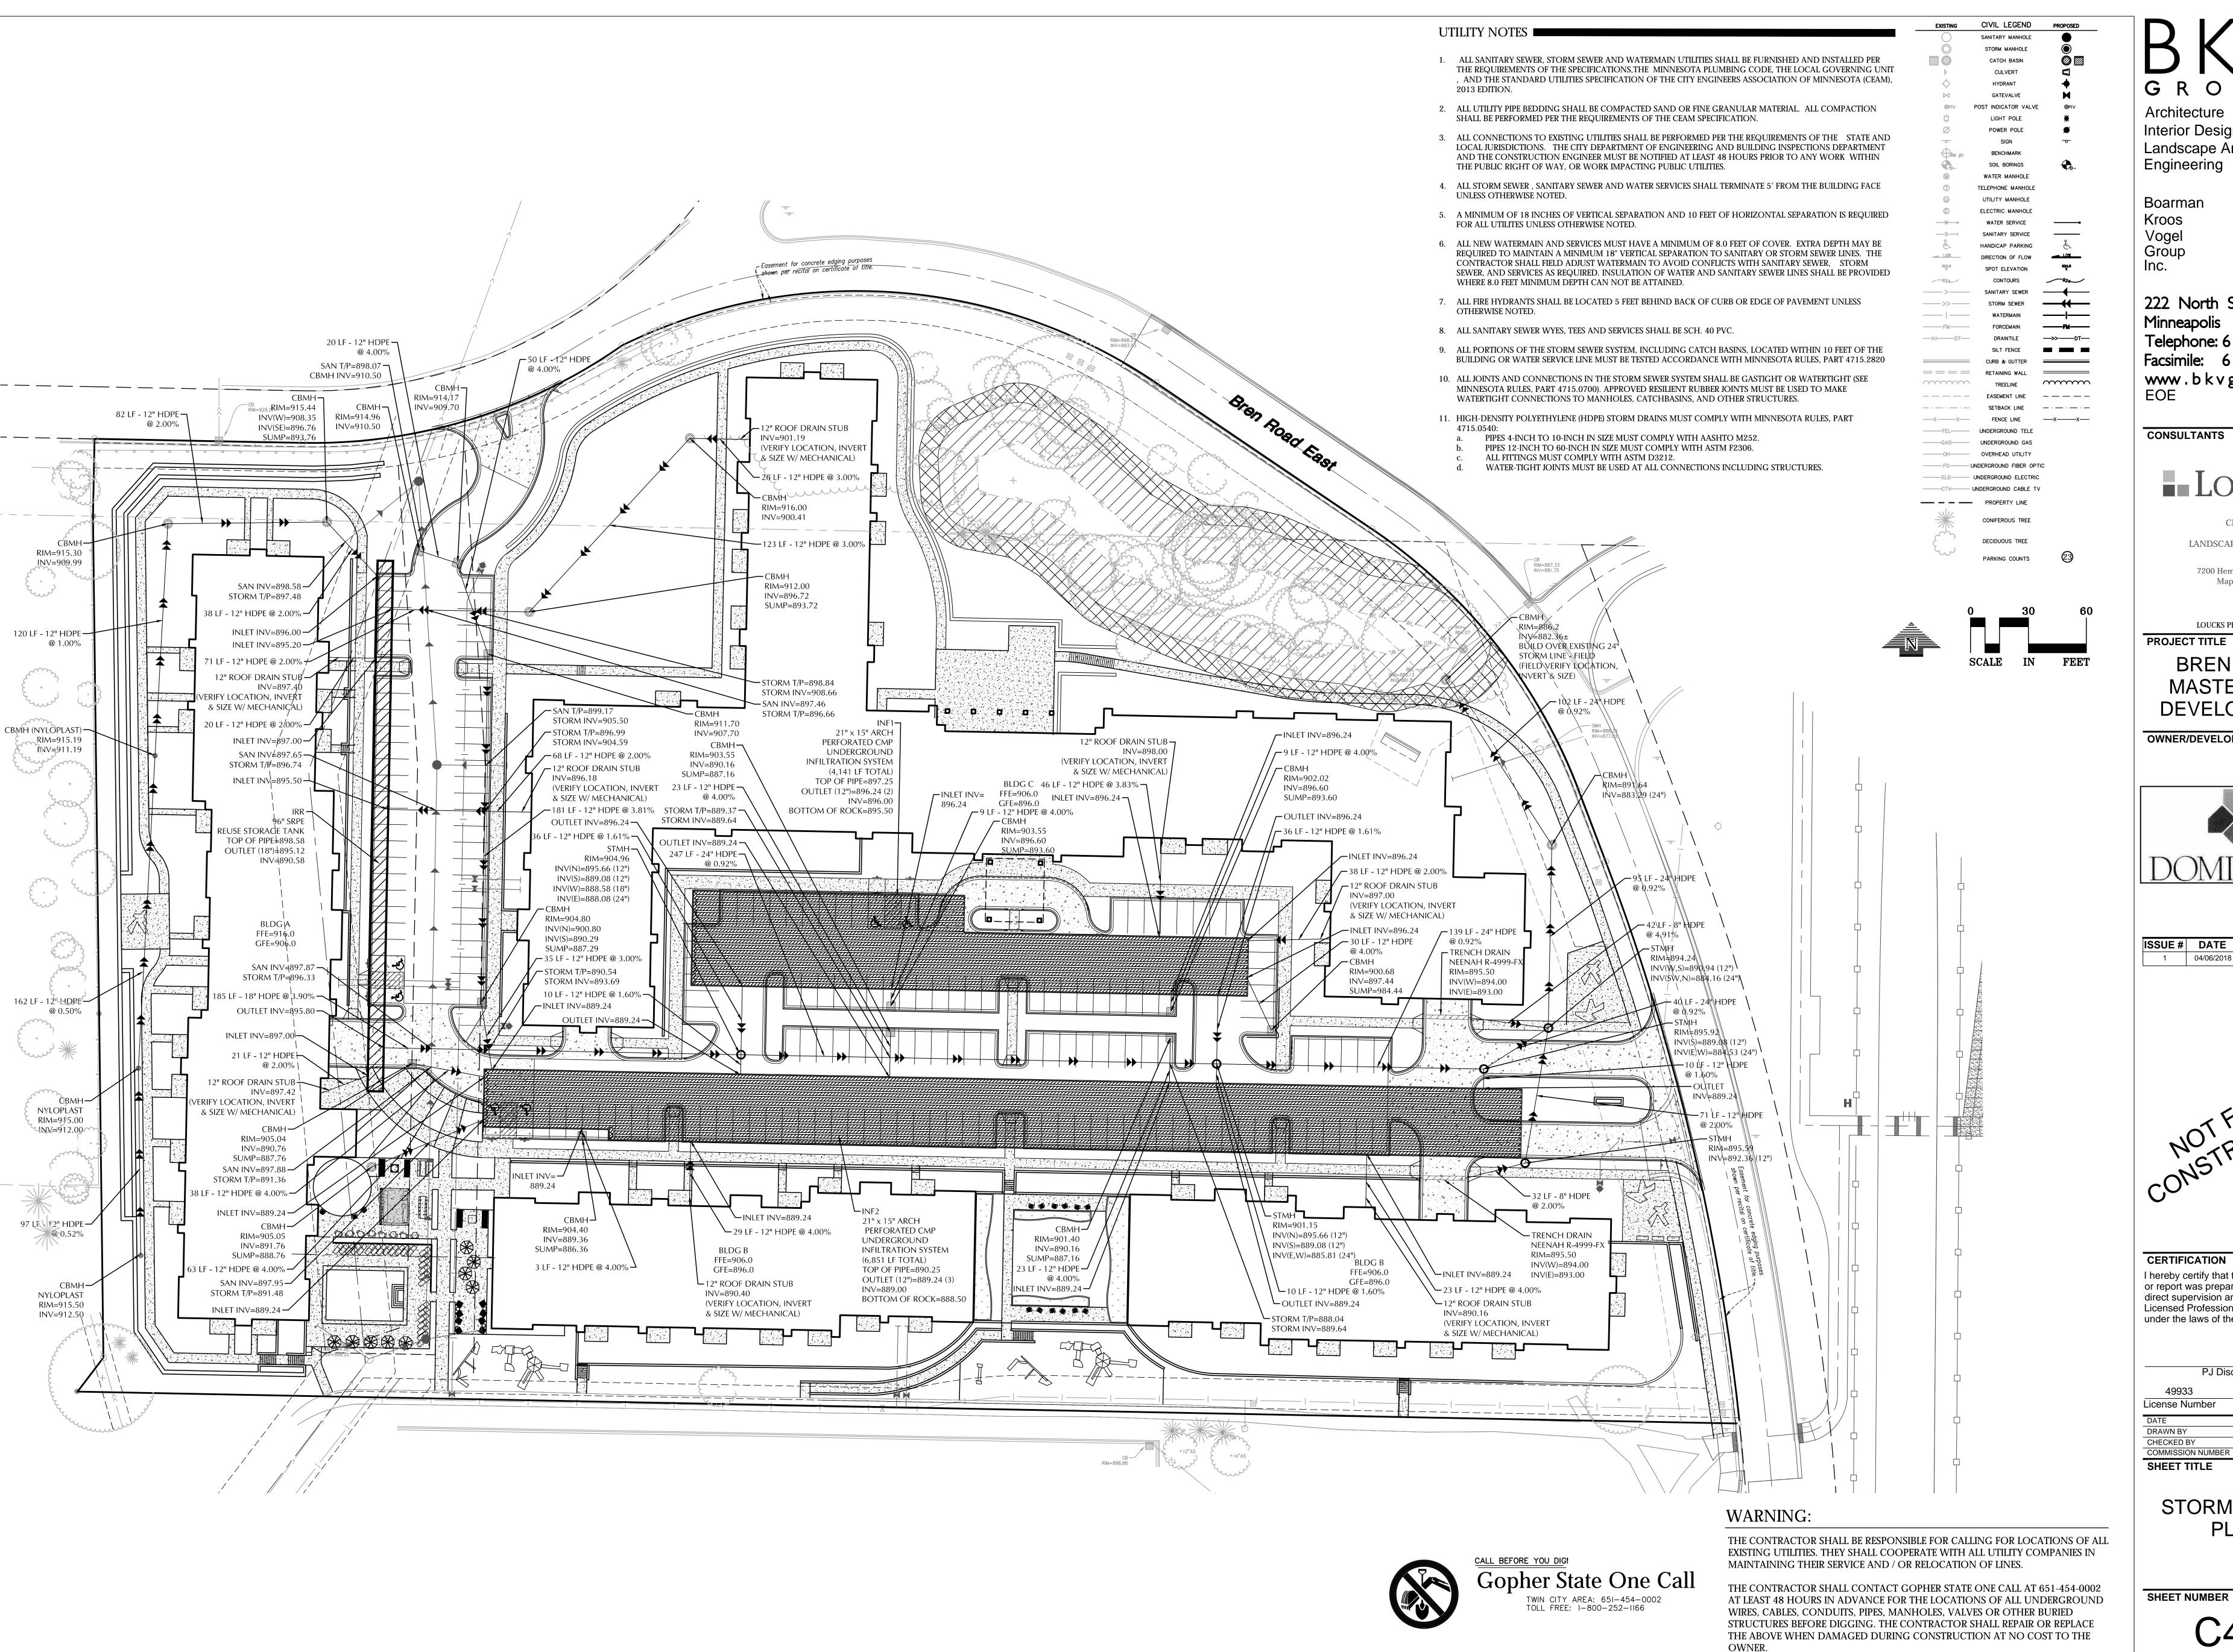
SANITARY SEWER & WATERMAIN

PLAN

SHEET NUMBER

C4-1

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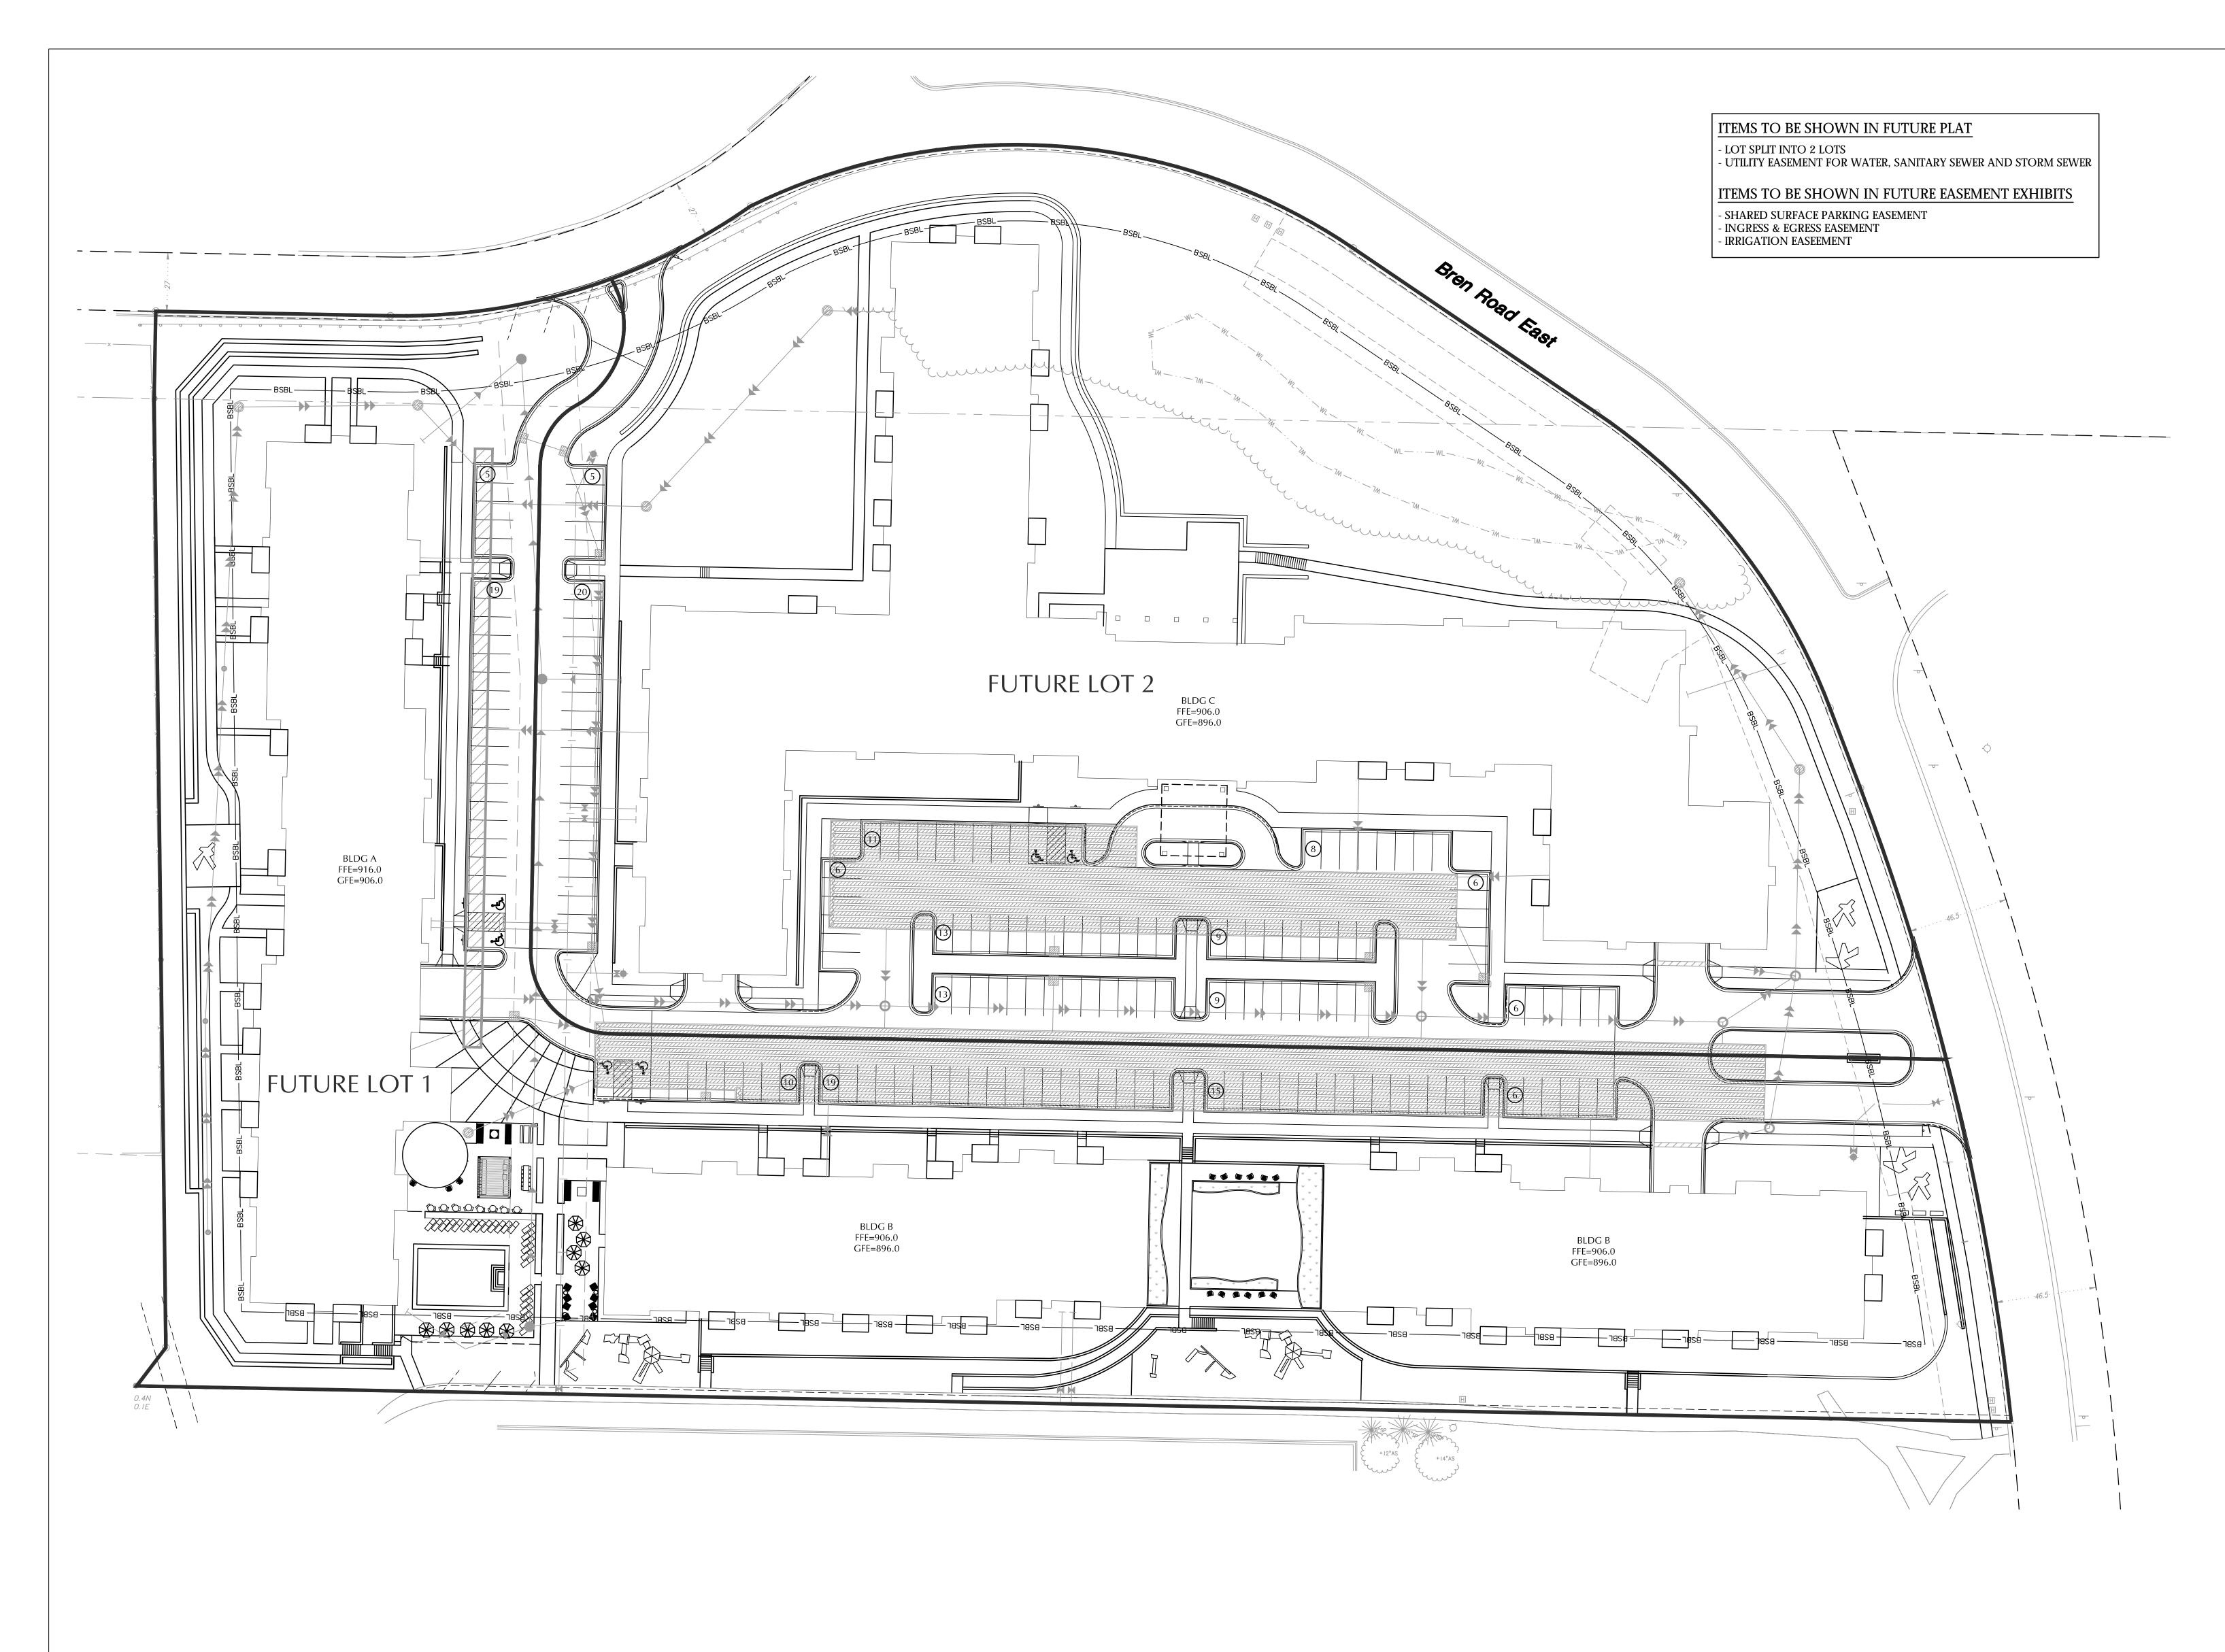
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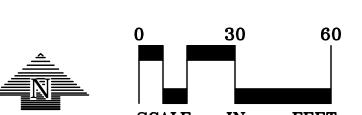
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STORM SEWER PLAN

C4-2

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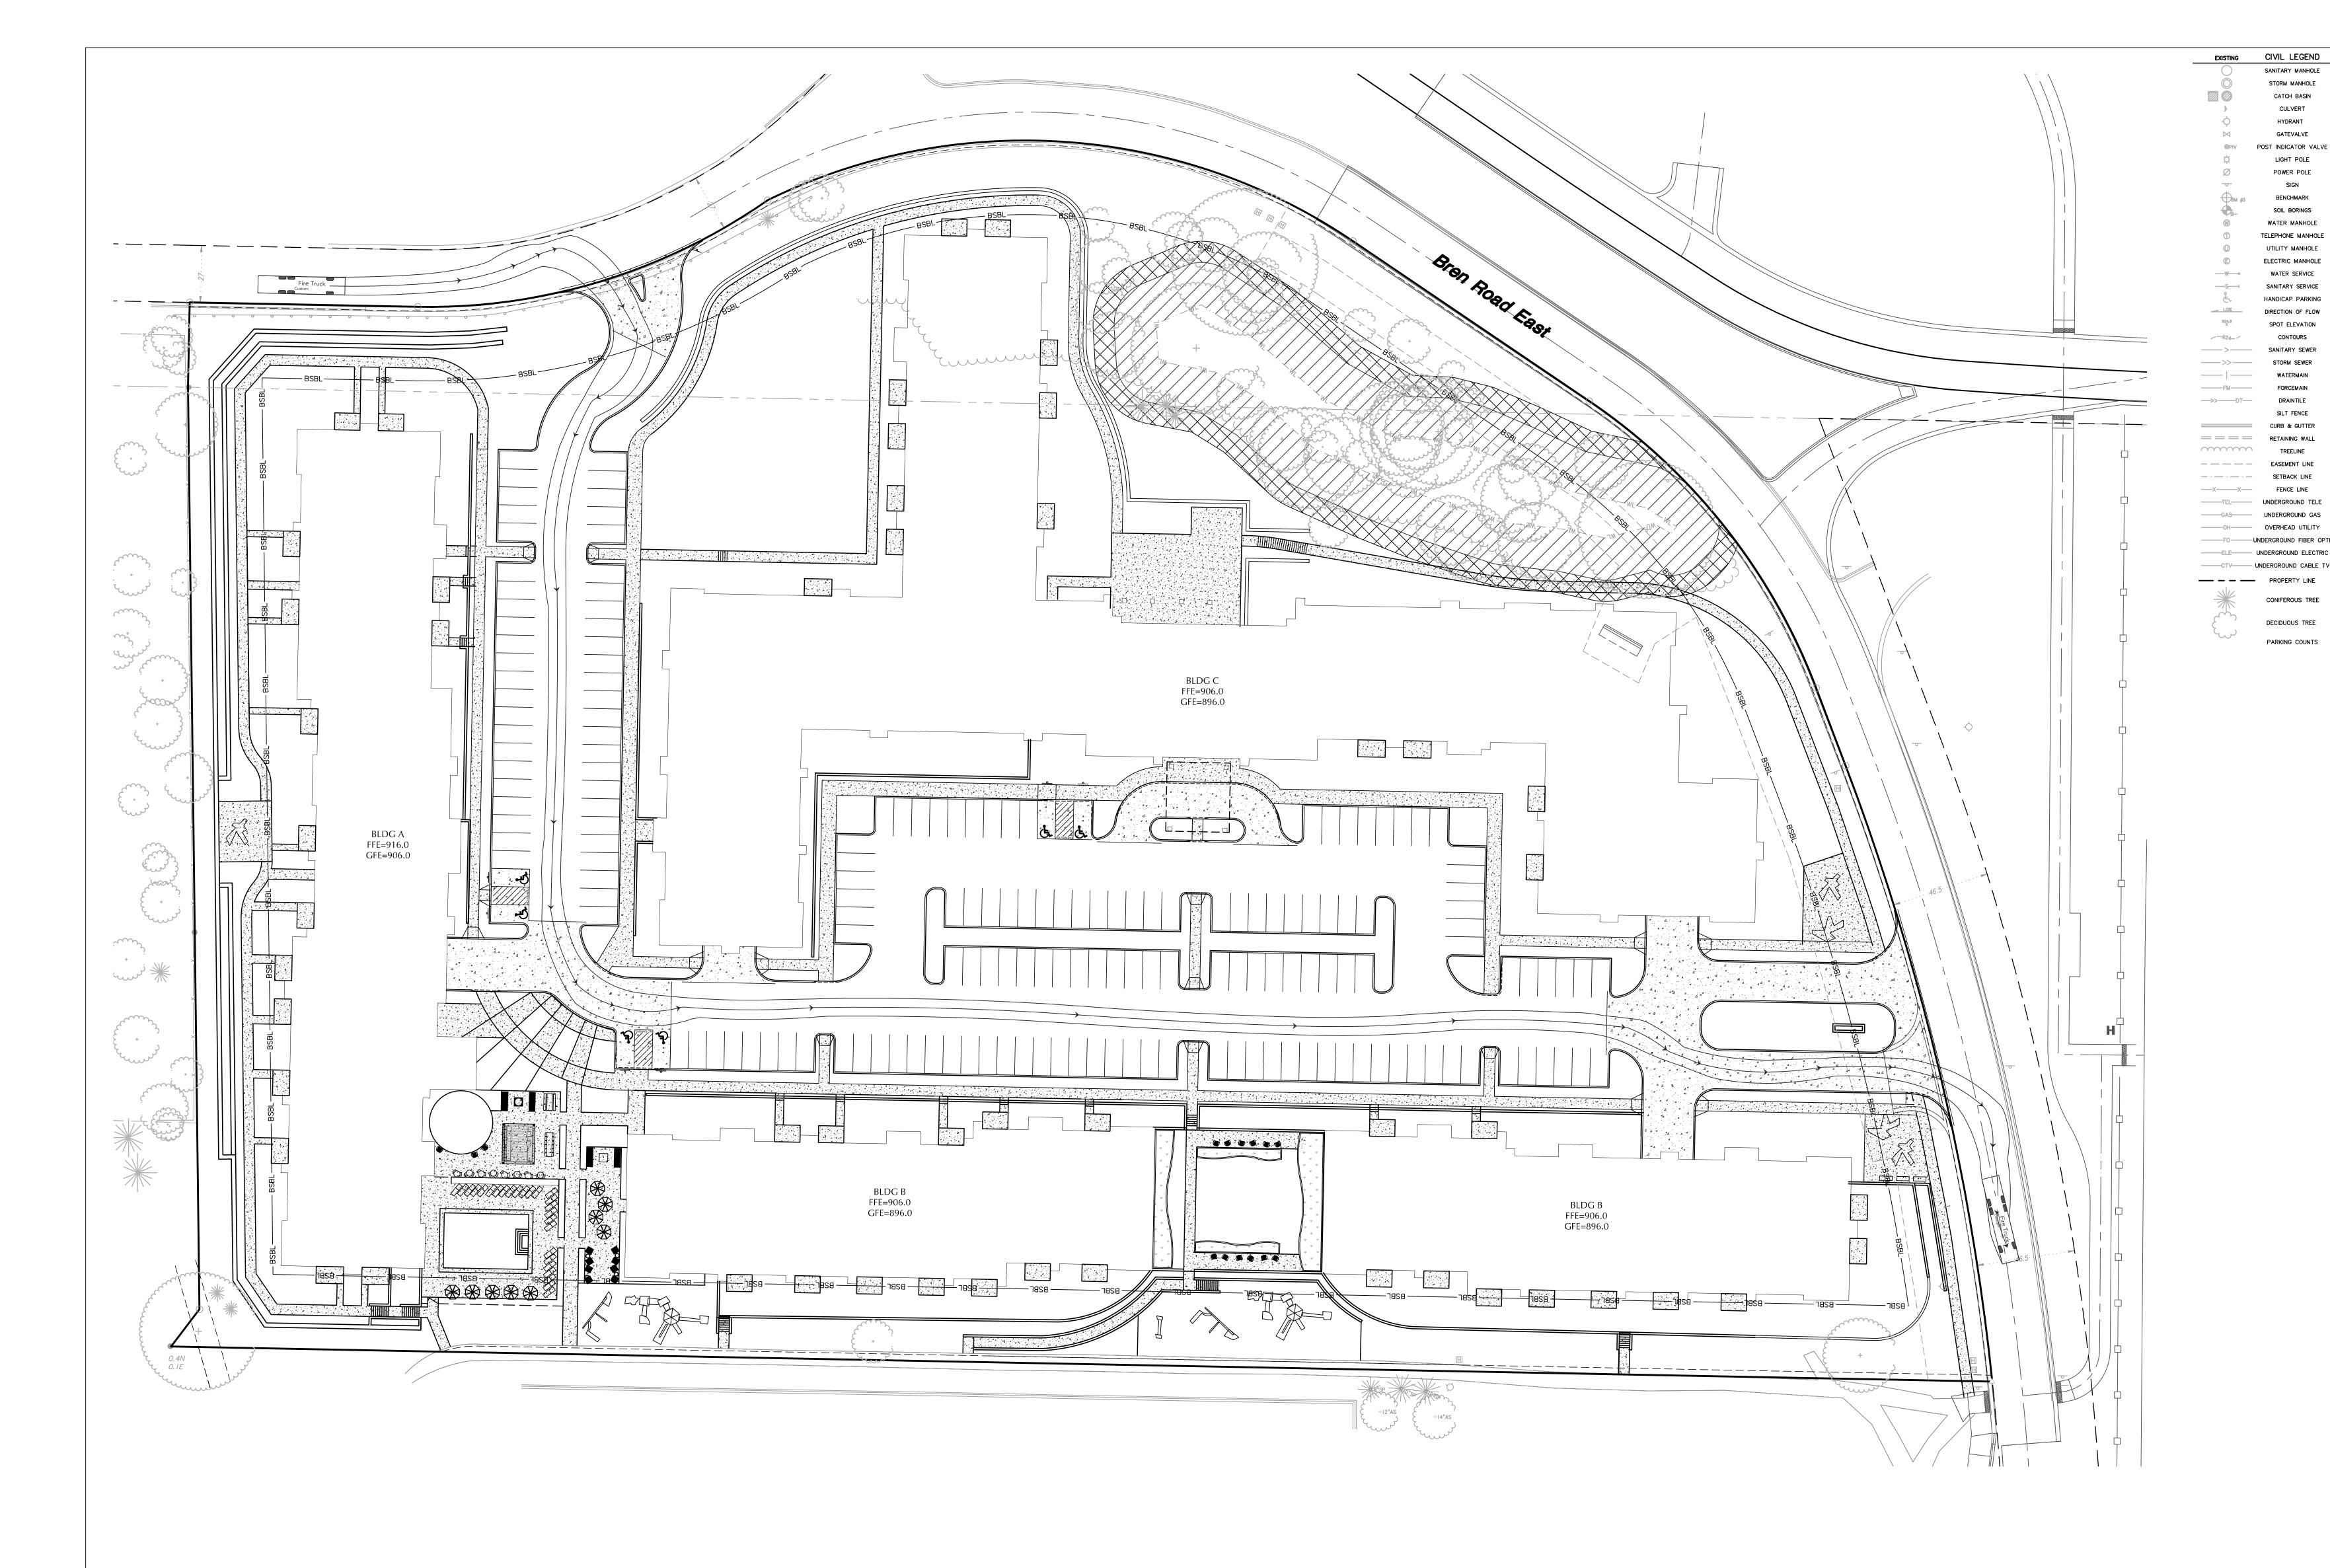
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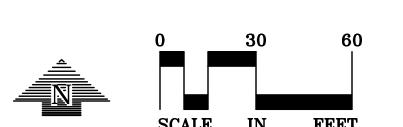
EXH-1

EXHIBIT

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TRUCK

TURNING PLAN


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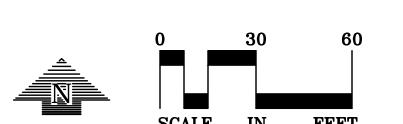
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EXH-2

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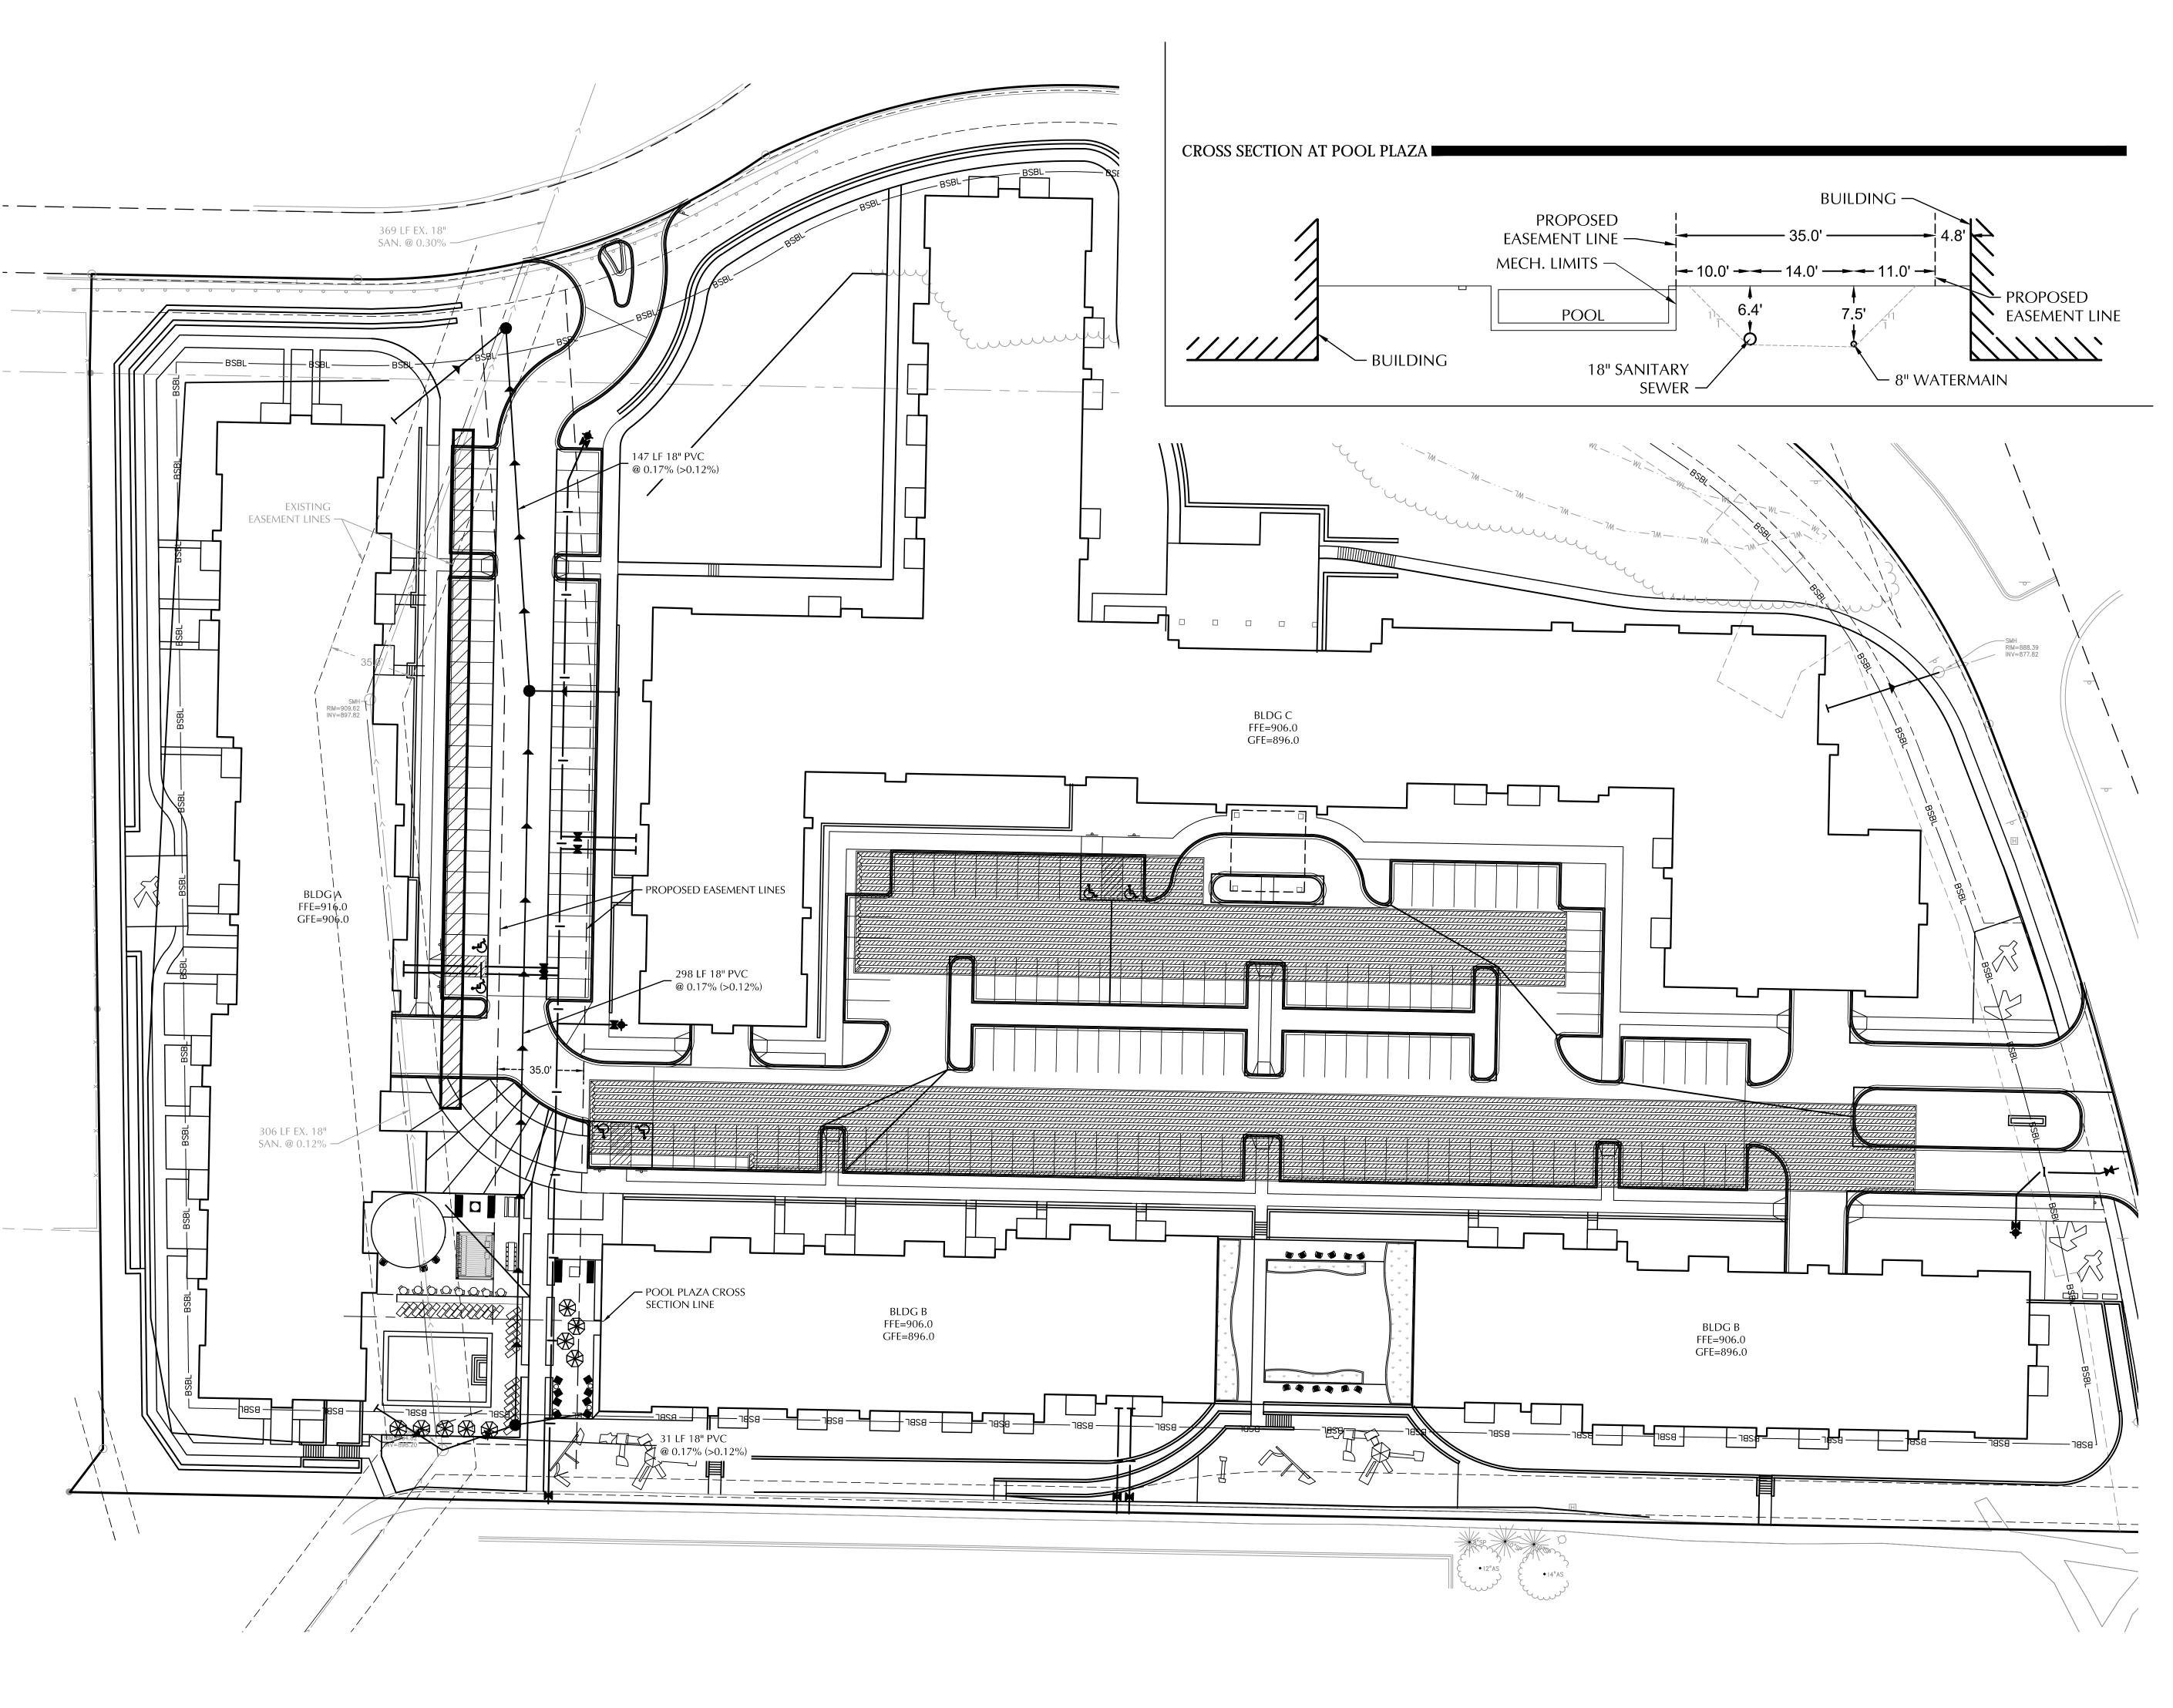
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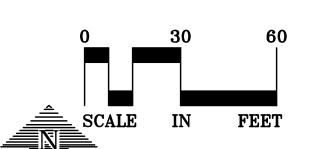
TRUCK TURNING PLAN

SHEET NUMBER

EXH-3

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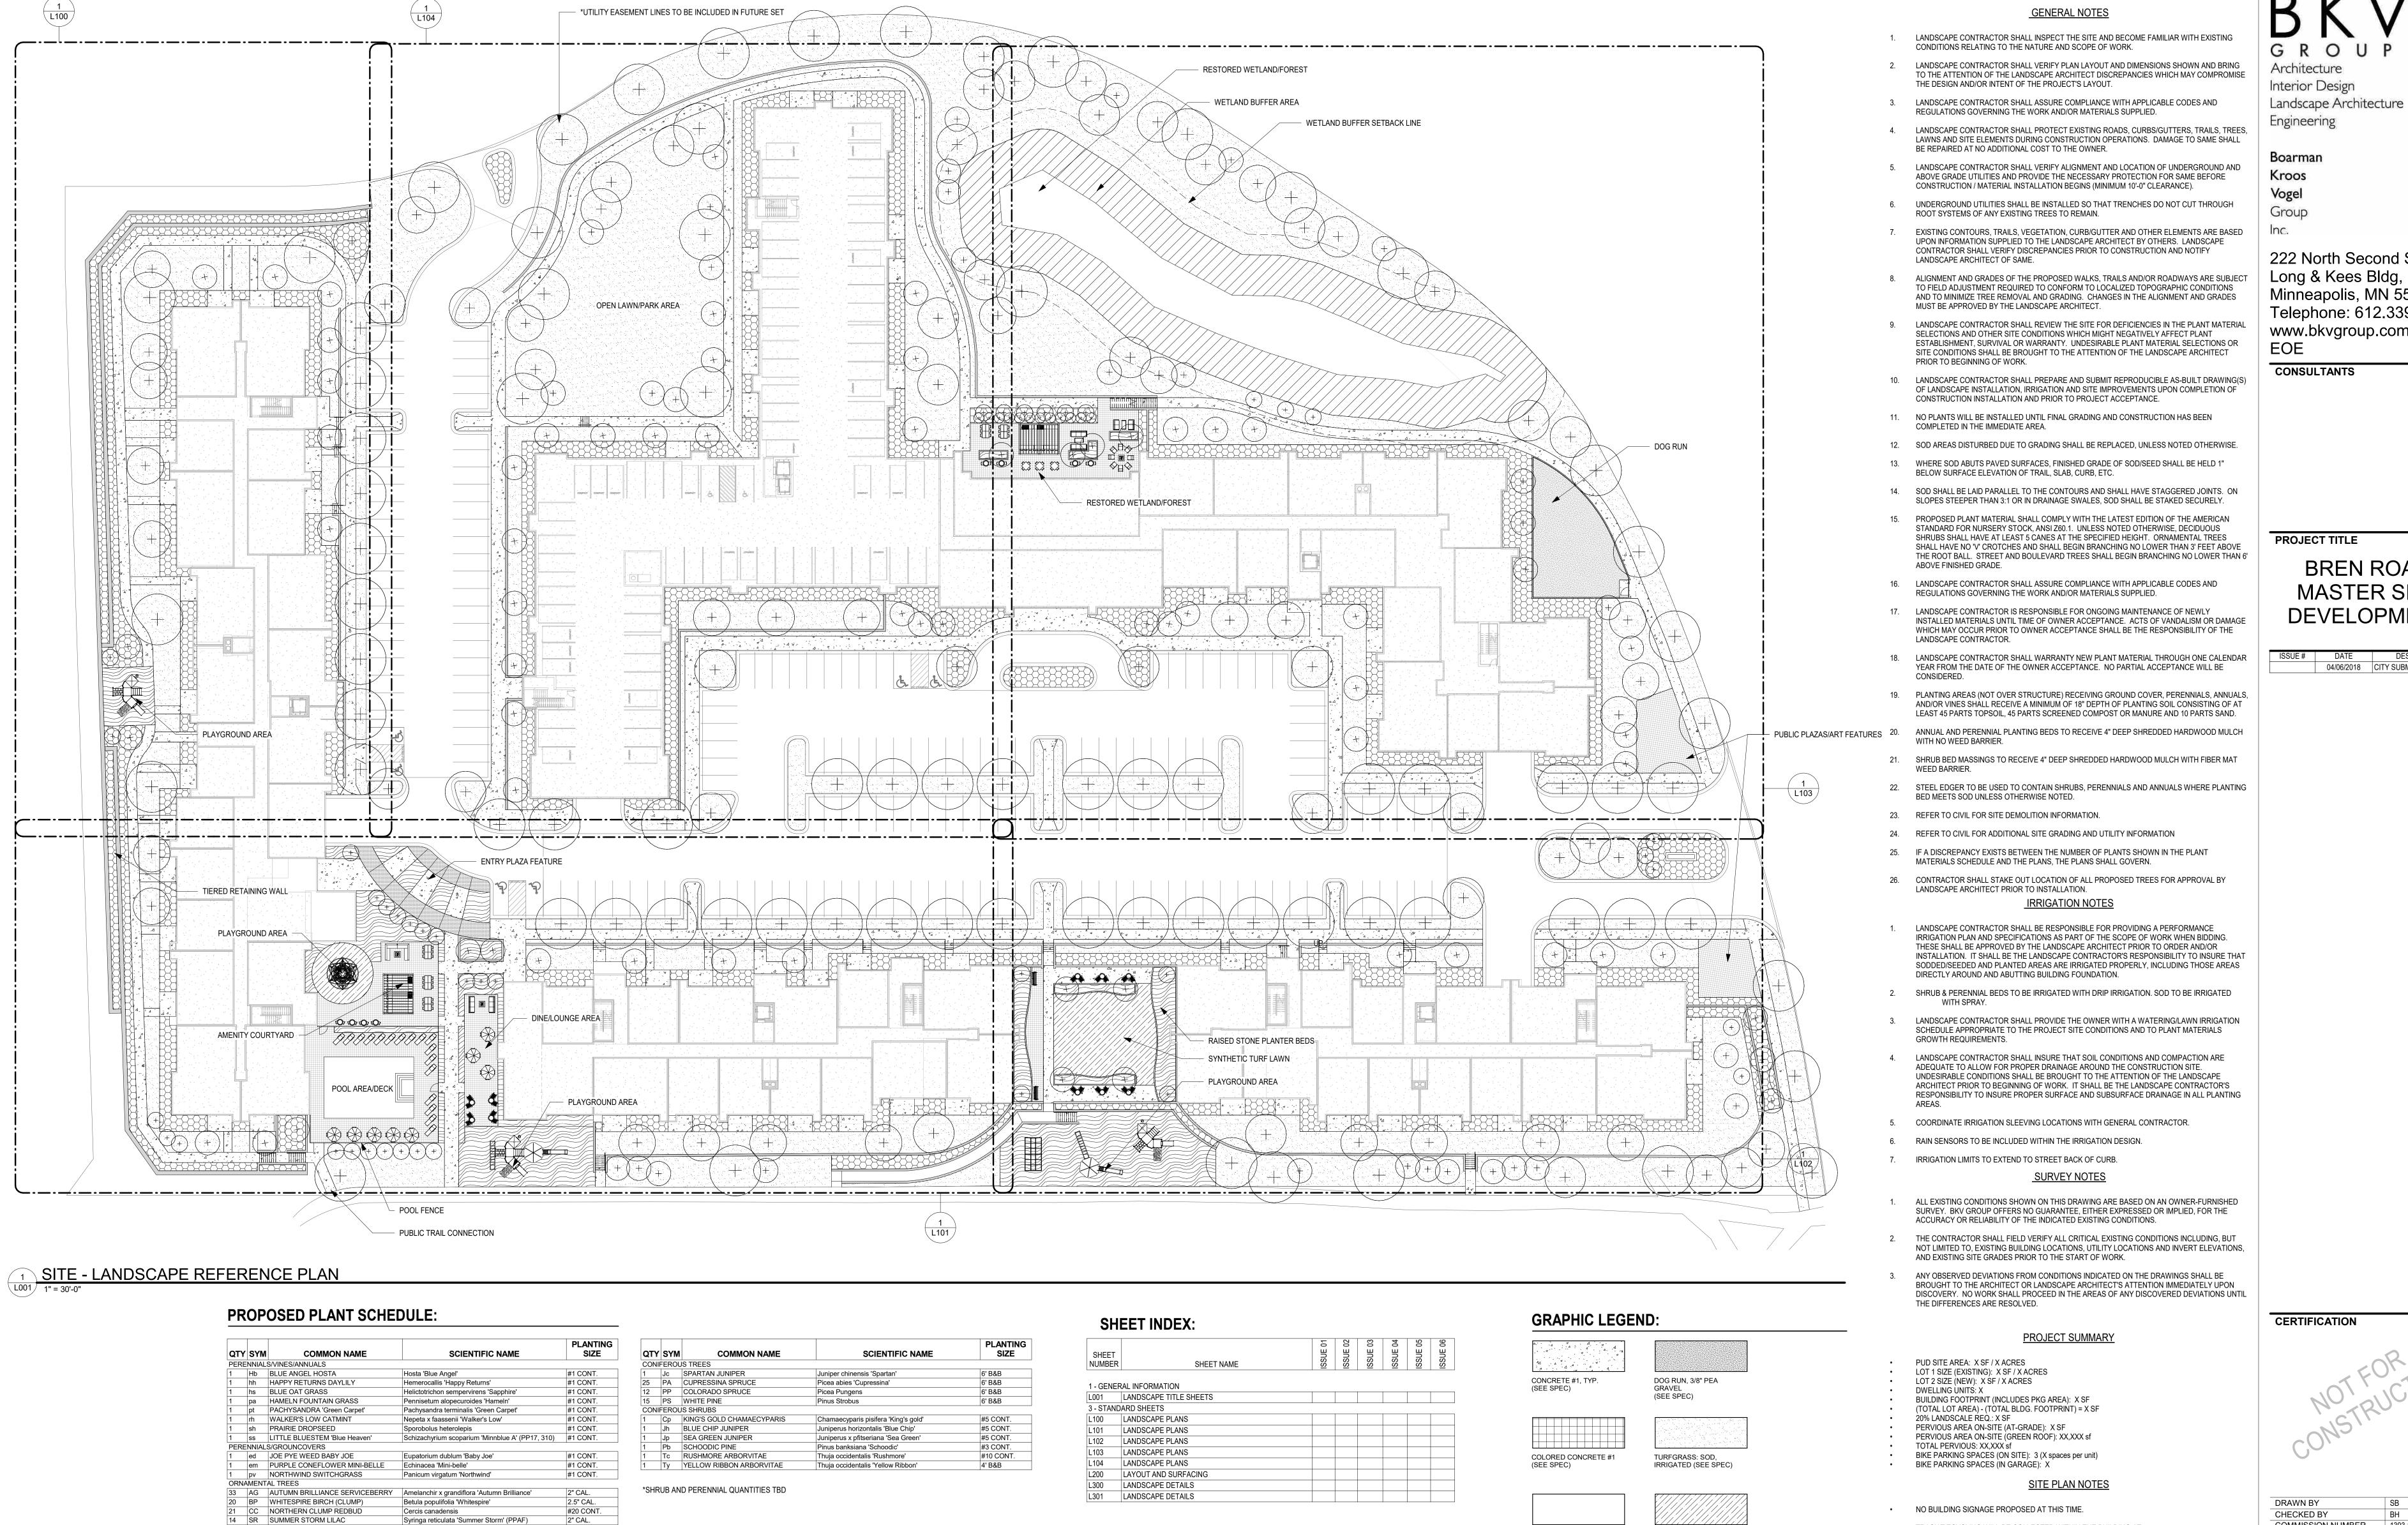
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DATE DESCRIPTION
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TRASH/RECYCLING WILL BE COLLECTED WITHIN THE BUILDING AT

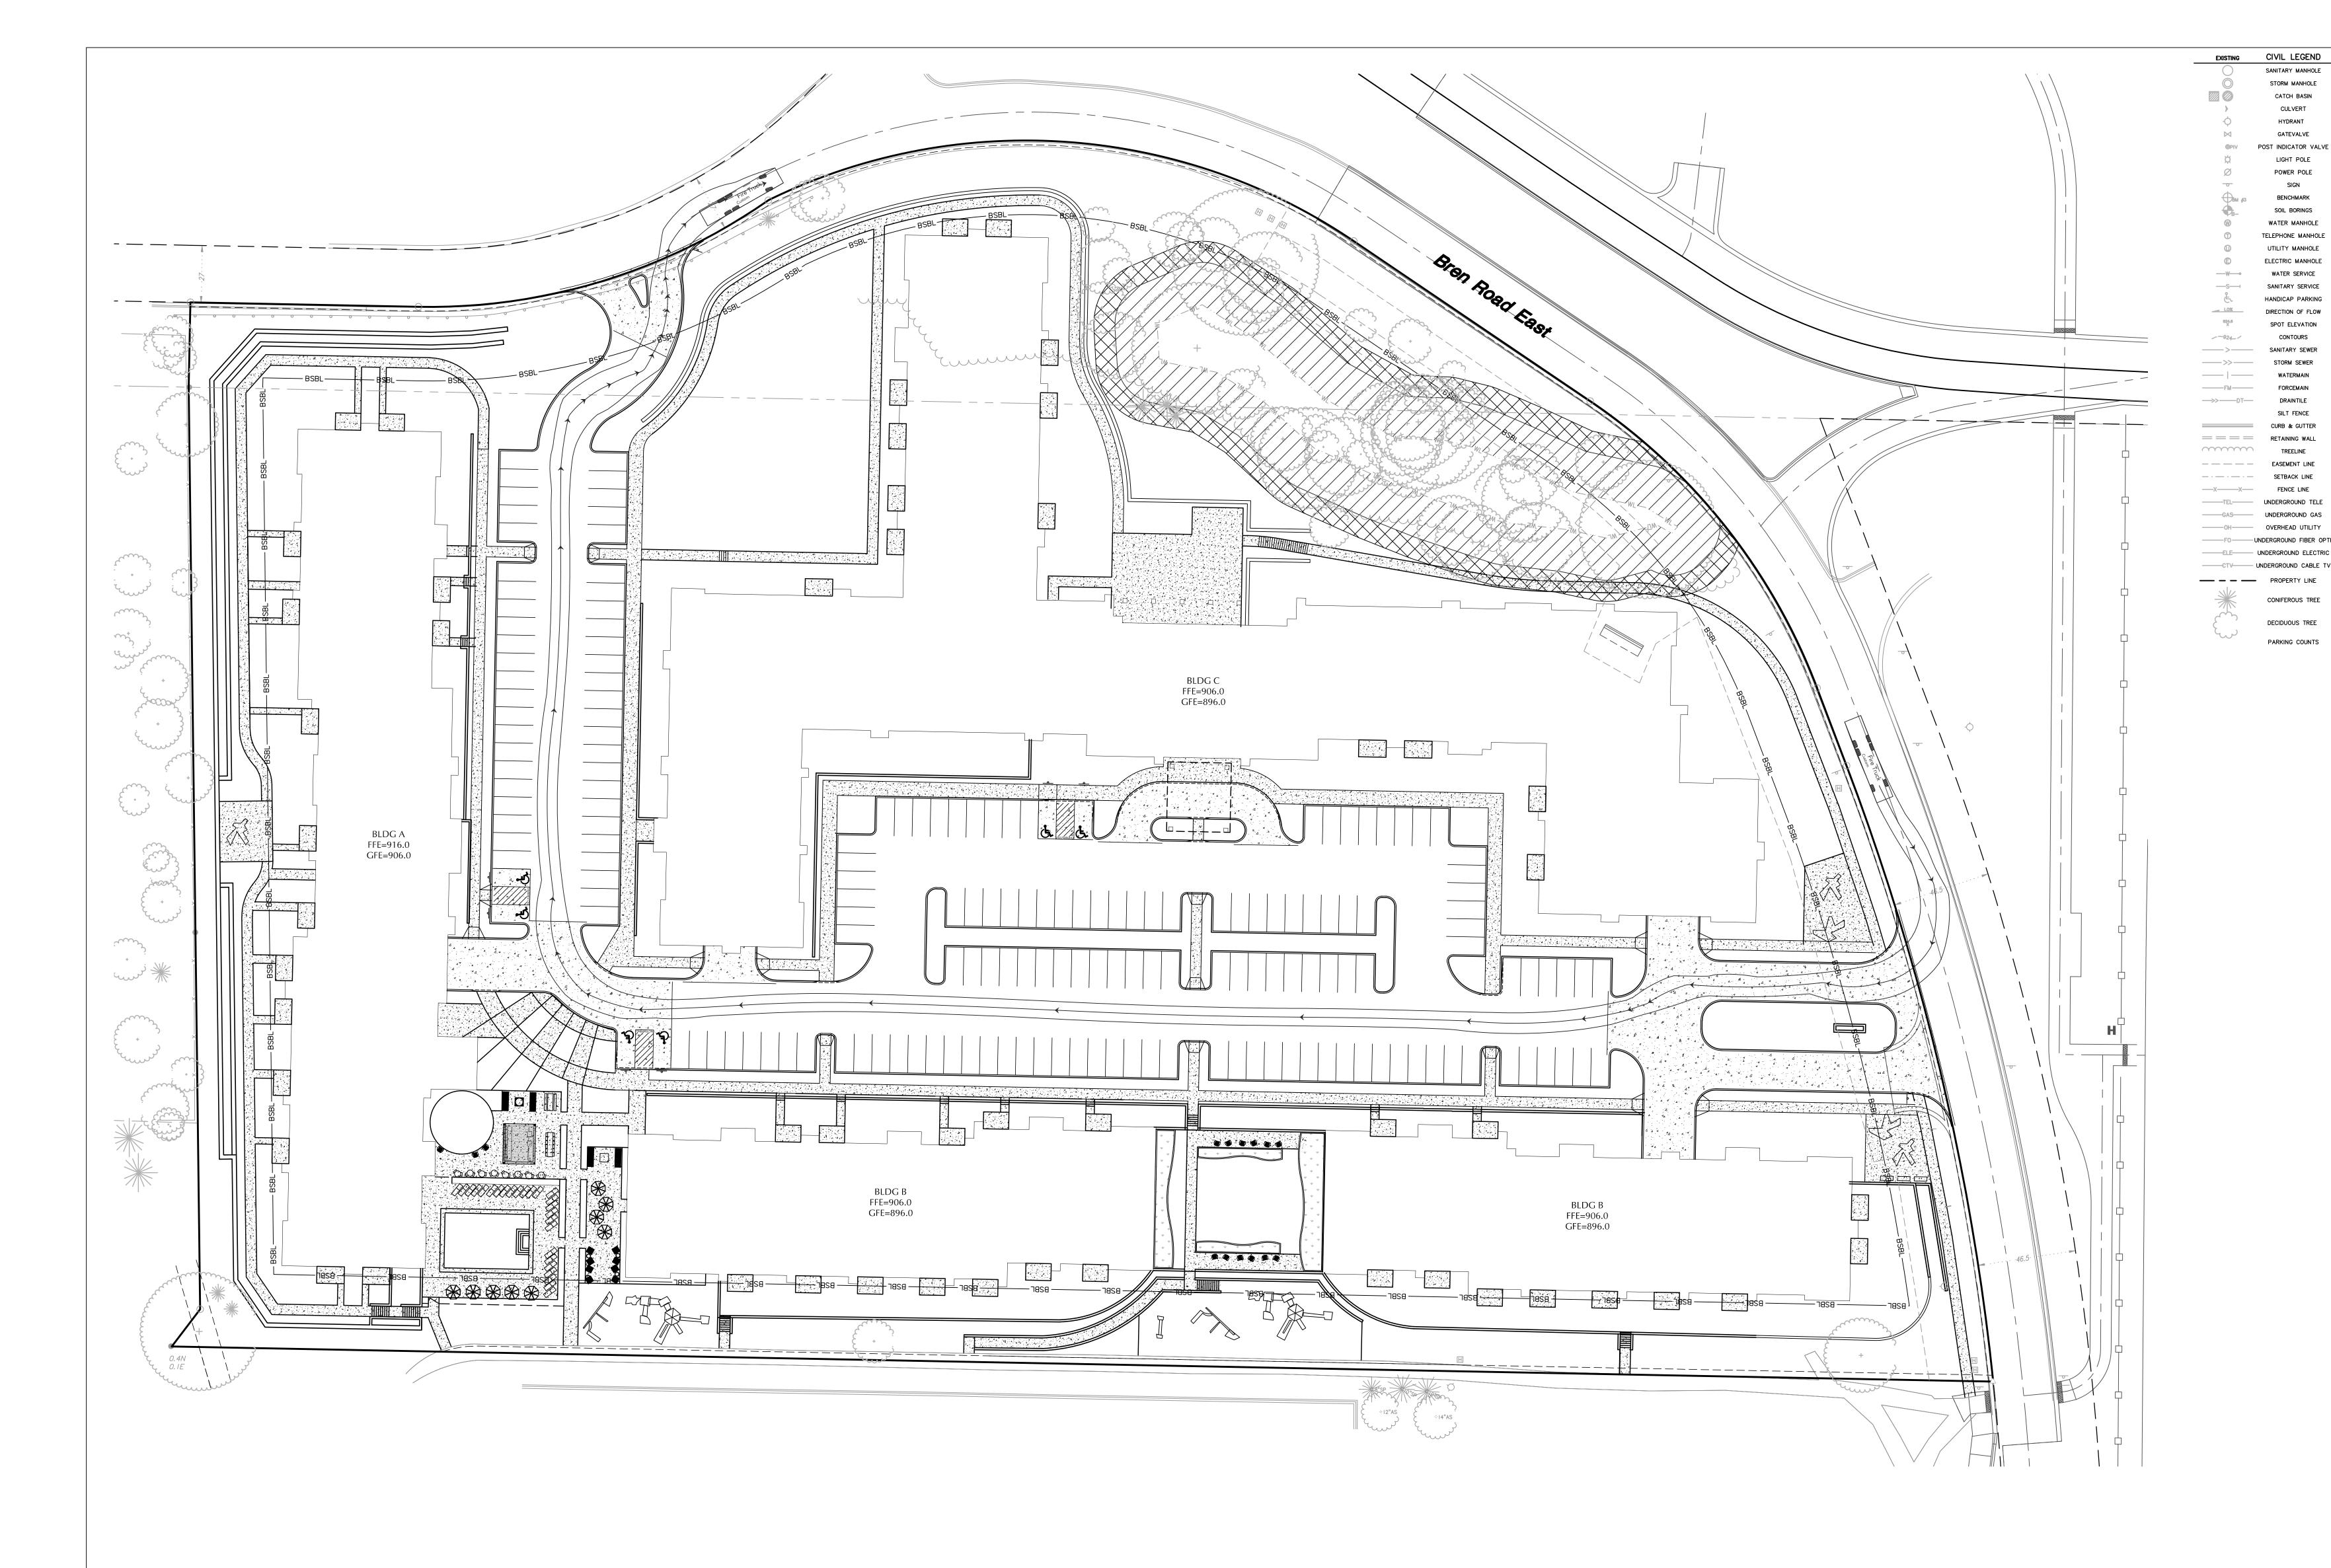AVAILABLE ALONG THE STREET BOULEVARDS.

GROUND LEVEL. COLLECTION WILL OCCUR ON-SITE WITHIN ENCLOSED LOADING AREAS BY

SNOW WILL BE REMOVED FROM SIDEWALKS. A LIMITED AMOUNT OF SNOW STORAGE IS

LANDSCAPE TITLE SHEETS

SHEET NUMBER

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14 SR SUMMER STORM LILAC

7 BP DAKOTA PINNACLE BIRC

18 GB AUTUMN GOLD GINKGO

19 GT SKYLINE HONEYLOCUST
33 PT PRAIRIE GOLD ASPEN
18 QB SWAMP WHITE OAK

26 TA AMERICAN SENTRY LINDEN

Sm DWARF KOREAN LILAC

Ss SEM FALSE SPIREA

Ca TOM THUMB COTONEASTER

1 Ds BUTTERFLY BUSH HONEYSUCKLE
13 Ra GRO LOW SUMAC

18 AS GREEN MOUNTAIN SUGAR MAPLE
11 BN RIVER BIRCH

Acer saccharum 'Green Mountain'

Gleditsia triacanthos var. inermis 'Skycole'

2.5" CAL.

#5 CONT. #5 CONT.

#2 CONT.

Betula platyphylla 'Fargo'

Quercus bicolor

Ginkgo Biloba 'Autumn Gold'

Populus tremuloides 'NEArb'

Tilia americana 'MnKSentry'

Diervilla sessilifolia 'Butterfly'

Rhus aromatica 'Gro Low'

Syringe meyeri 'Palibin'

Cotoneaster apiculatus 'Tom Thumb'

Sorbaria sorbifolia 'Sem'(PP16,336)

DECIDUOUS TREES

DECIDUOUS SHRUBS

COLORED CONCRETE #2 SYNTHETIC TURF (SEE SPEC) (SEE SPEC)

(SEE SPEC) WETLAND/FOREST AREA HARDWOOD MULCH, WETLAND BUFFER AREA

ROCK MULCH #1

SHREDDED (SEE SPEC)

BLDG HEIGHT

FOURTH FLOOR

THIRD FLOOR

SECOND FLOOR

121'-4"



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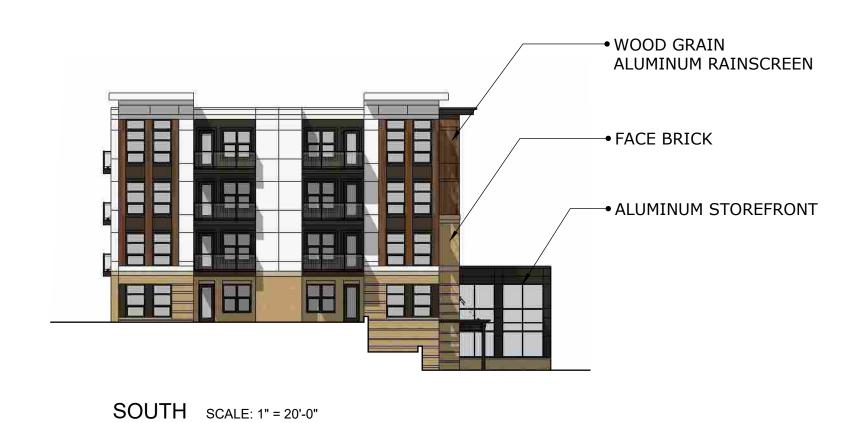
BREN ROAD **BUILDING A**

ISSUE # DATE DESCRIPTION
04/06/2018 CITY SUBMITTAL



FIBER CEMENT LAP SIDING •

VINYL WINDOWS •



SMOOTH FIBER


CEMENT SIDING •

WOOD GRAIN ALUMINUM RAINSCREEN

FACE BRICK •

EAST SCALE: 1" = 20'-0"

ALUMINUM BALCONY •—

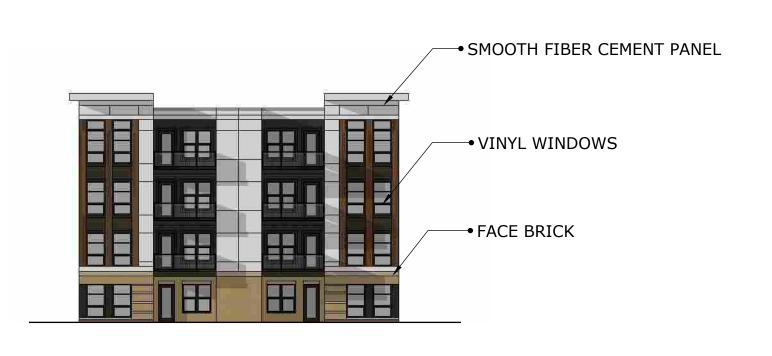

NORTH SCALE: 1" = 20'-0"

CERTIFICATION

CHECKED BY COMMISSION NUMBER Project Number SHEET TITLE

ELEVATIONS

SHEET NUMBER

Α








NORTH SCALE: 1" = 20'-0"

SOUTH SCALE: 1" = 20'-0"







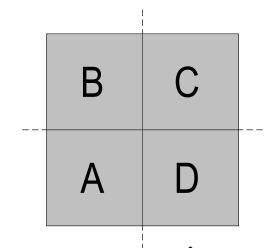



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Interior Design

PROJECT TITLE

BREN ROAD BUILDING B.1

ISSUE # DATE DESCRIPTION
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CERTIFICATION

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ELEVATIONS

SHEET NUMBER



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FACE BRICK ◆──

EAST 1 SCALE: 1" = 30'-0"



SMOOTH FIBER

CEMENT PANELS ◆



WOOD GRAIN

ALUMINUM RAINSCREEN •—

*** *** *** ** **


VINYL WINDOWS ◆

FACE BRICK ◆

ALUMINUM

STOREFRONT •——



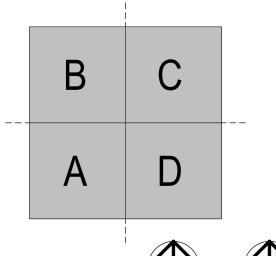

TRUE NORTH PLAN NORTH

ELEVATIONS

CERTIFICATION

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SHEET TITLE

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BLDG HEIGHT
178'-4"

BLDG HEIGHT 167'-8"

SIXTH FLOOR
157'-0"

FIFTH FLOOR
146'-4"
FOURTH FLOOR
135'-8"

THIRD FLOOR

125'-0"

SECOND FLOOR

112'-6"

FIRST FLOOR

100'-0"

GARAGE

89'-0"

NORTH SCALE: 1" = 30'-0"

SOUTH SCALE: 1" = 30'-0"

ALUMINUM BALCONY •——

EAST INTERIOR SCALE: 1" = 30'-0"



G R O U P Architecture Interior Design Landscape Architecture Engineering

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Author
Checker
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> LEVELS P1 - 4 REFERENCE **PLANS**

SHEET NUMBER

A097

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3 LEVELS 3-5 - REFERENCE PLAN
1" = 20'-0"

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LEVELS P1 - 5 REFERENCE PLANS

SHEET NUMBER

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TRUE NORTH PLAN NORTH

A097

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LEVELS 3 - ROOF REFERENCE **PLANS**

SHEET NUMBER

110' - 4"

GARAGE ENTRY TO -LEVEL P1 (TWO-WAY)

101' - 5"

В

Α

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LEVEL P1 -OVERALL FLOOR PLAN

SHEET NUMBER

A099

TRUE NORTH PLAN NORTH

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1 LEVEL P1 - REFERENCE PLAN
A099 1/16" = 1'-0"

64' - 0"

133' - 8"

STAIR A —



Boarman Kroos Vogel Group

222 North Second Street Long & Kees Bldg, Suite 101 Minneapolis, MN 55401 Telephone: 612.339.3752 www.bkvgroup.com EOE

CONSULTANTS

PROJECT TITLE

BREN ROAD BUILDING C

ISSUE # DATE DESCRIPTION
04/06/2018 CITY SUBMITTAL

В

Α


DRAWN BY
CHECKED BY
COMMISSION NUMBER
Author
Checker
Project Number SHEET TITLE

LEVEL 1 -OVERALL FLOOR PLAN

TRUE NORTH PLAN NORTH SHEET NUMBER

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A101



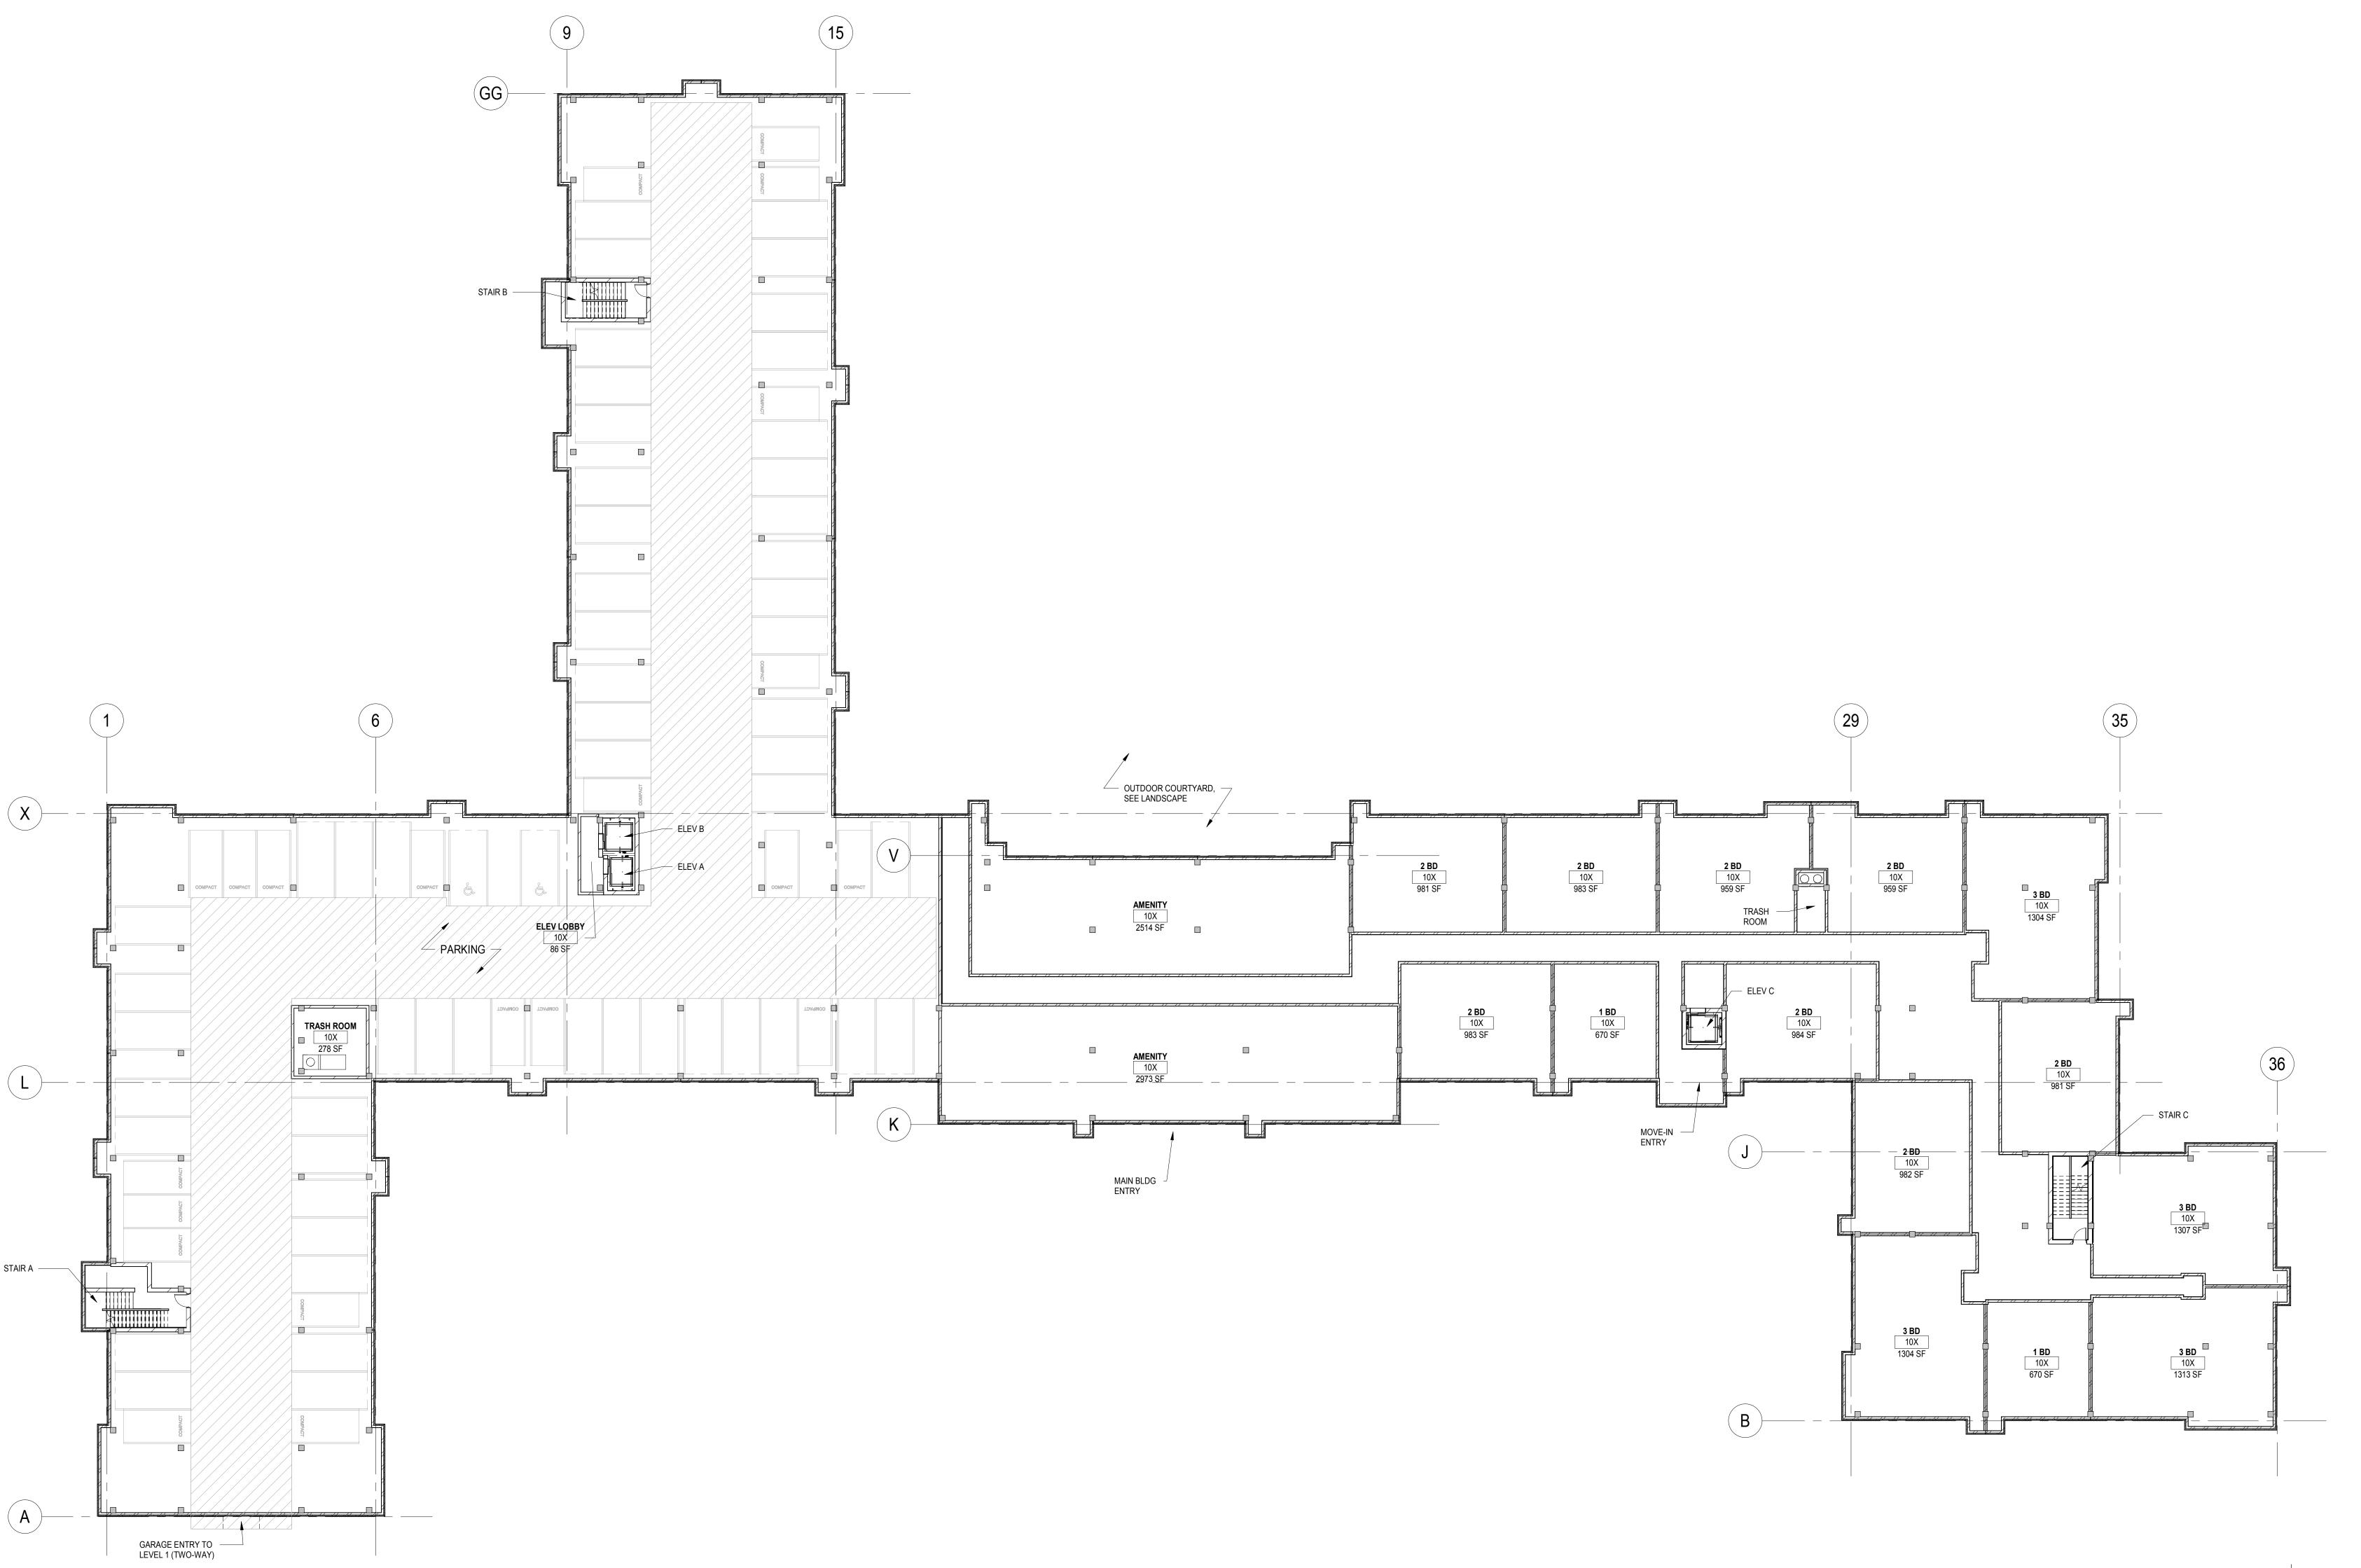



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CONSULTANTS

PROJECT TITLE

BREN ROAD BUILDING C

ISSUE # DATE DESCRIPTION
04/06/2018 CITY SUBMITTAL

CERTIFICATION

DRAWN BY
CHECKED BY
COMMISSION NUMBER
Project Number
SHEET TITLE

LEVEL 2 OVERALL FLOOR PLAN

TRUE NORTH PLAN NORTH

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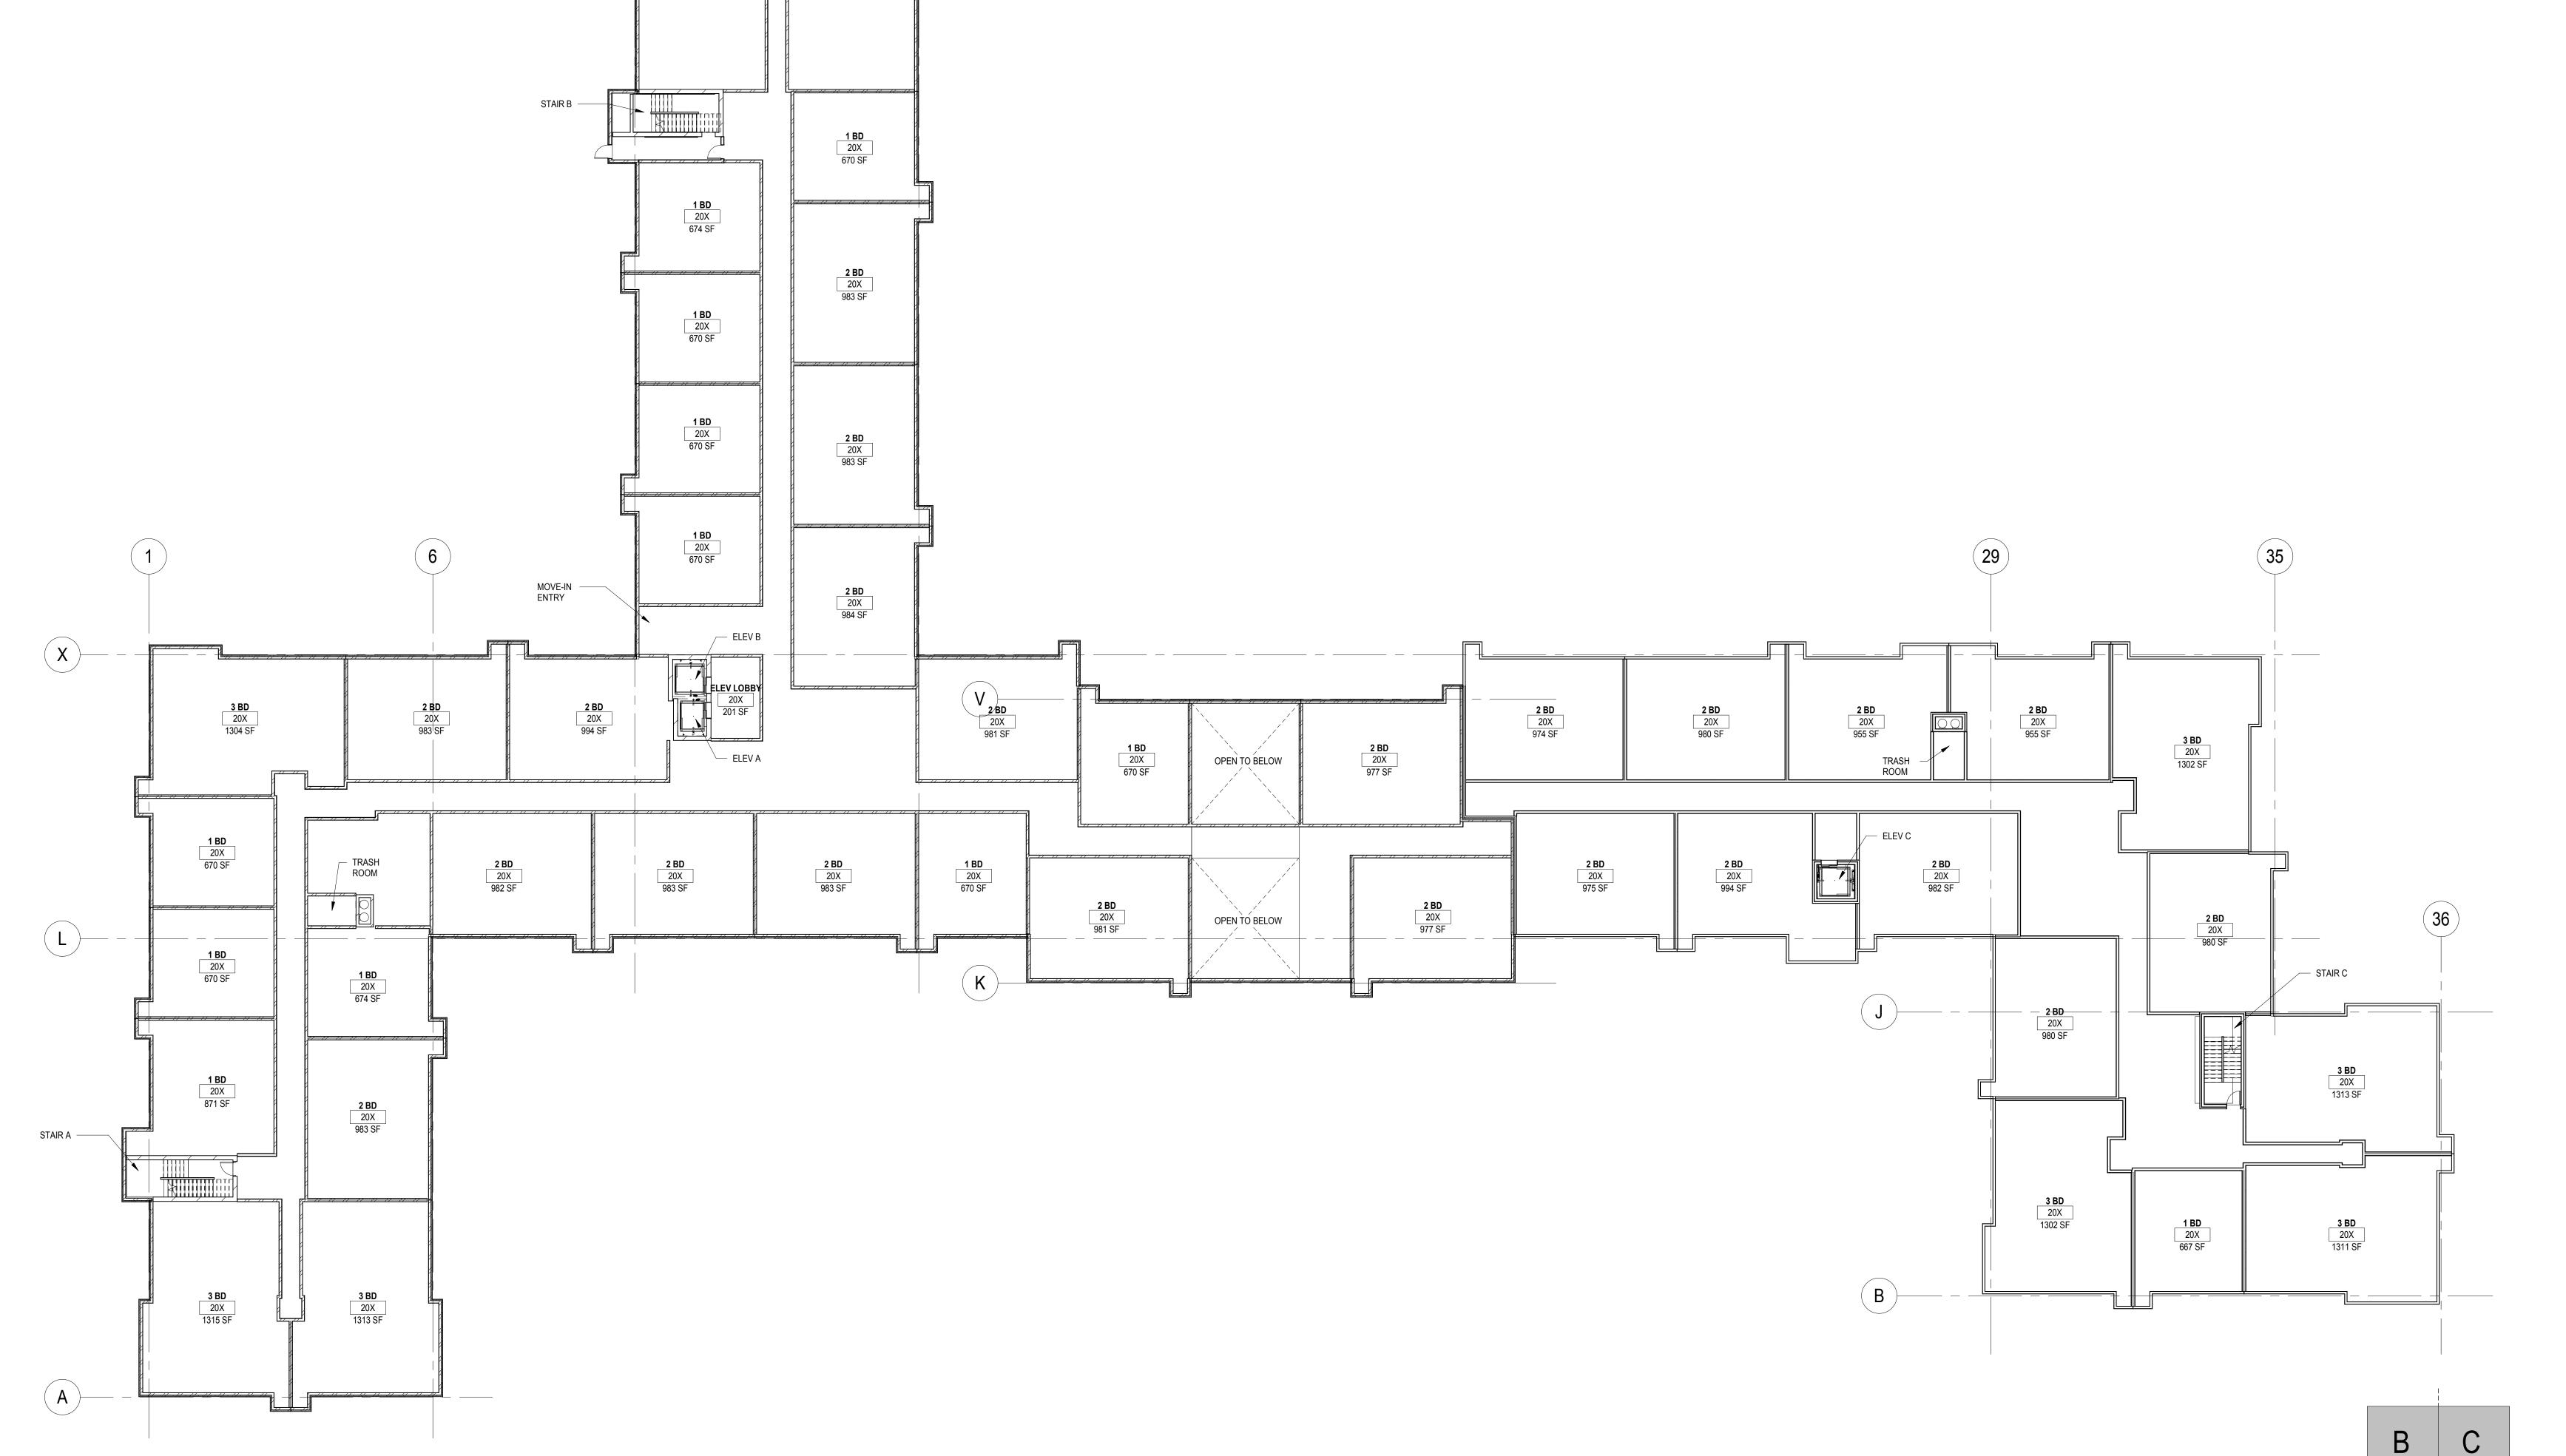
A102

1 LEVEL 2 - REFERENCE PLAN

1/16" = 1'-0"

GG

3 BD 20X 1313 SF 3 BD 20X 1313 SF







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ISSUE # DATE DESCRIPTION
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CHECKED BY SHEET TITLE В LEVEL 3 OVERALL FLOOR Α

TRUE NORTH PLAN NORTH SHEET NUMBER


A103

PLAN

COMMISSION NUMBER Project Number


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CERTIFICATION

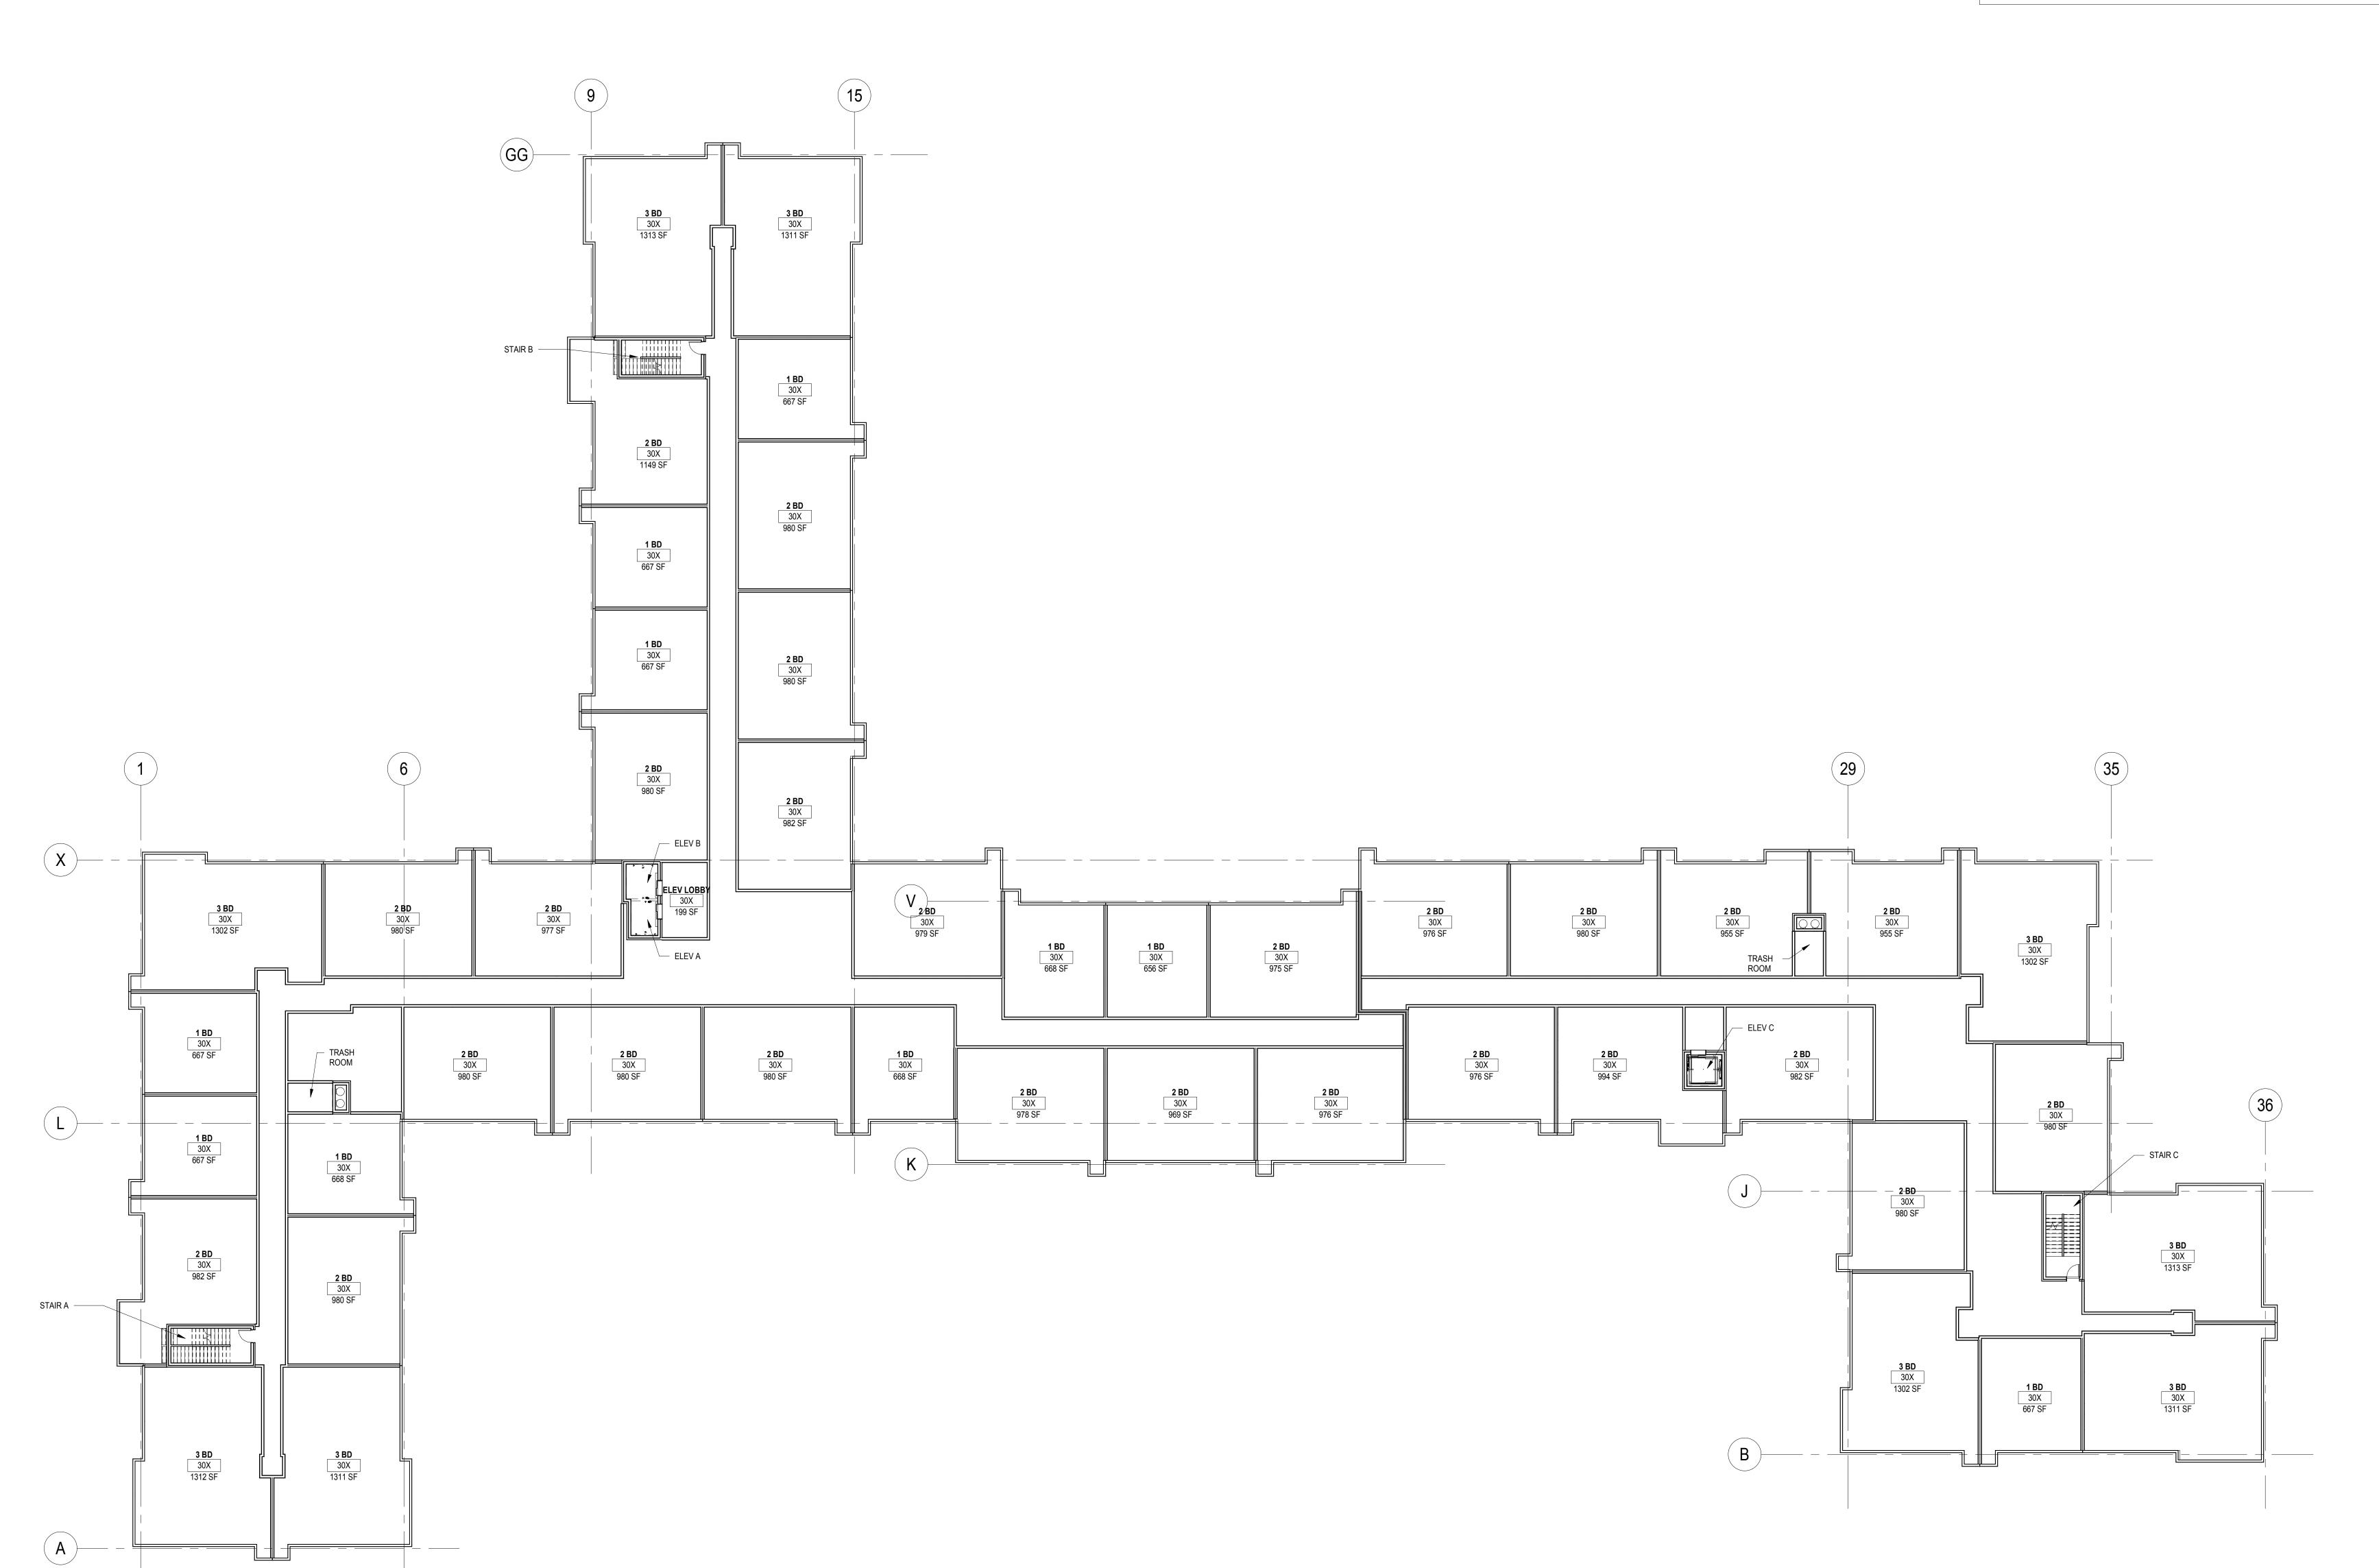

LEVEL 3 - REFERENCE PLAN (LEVELS 3-6 IDENTICAL)

1/16" = 1'-0"

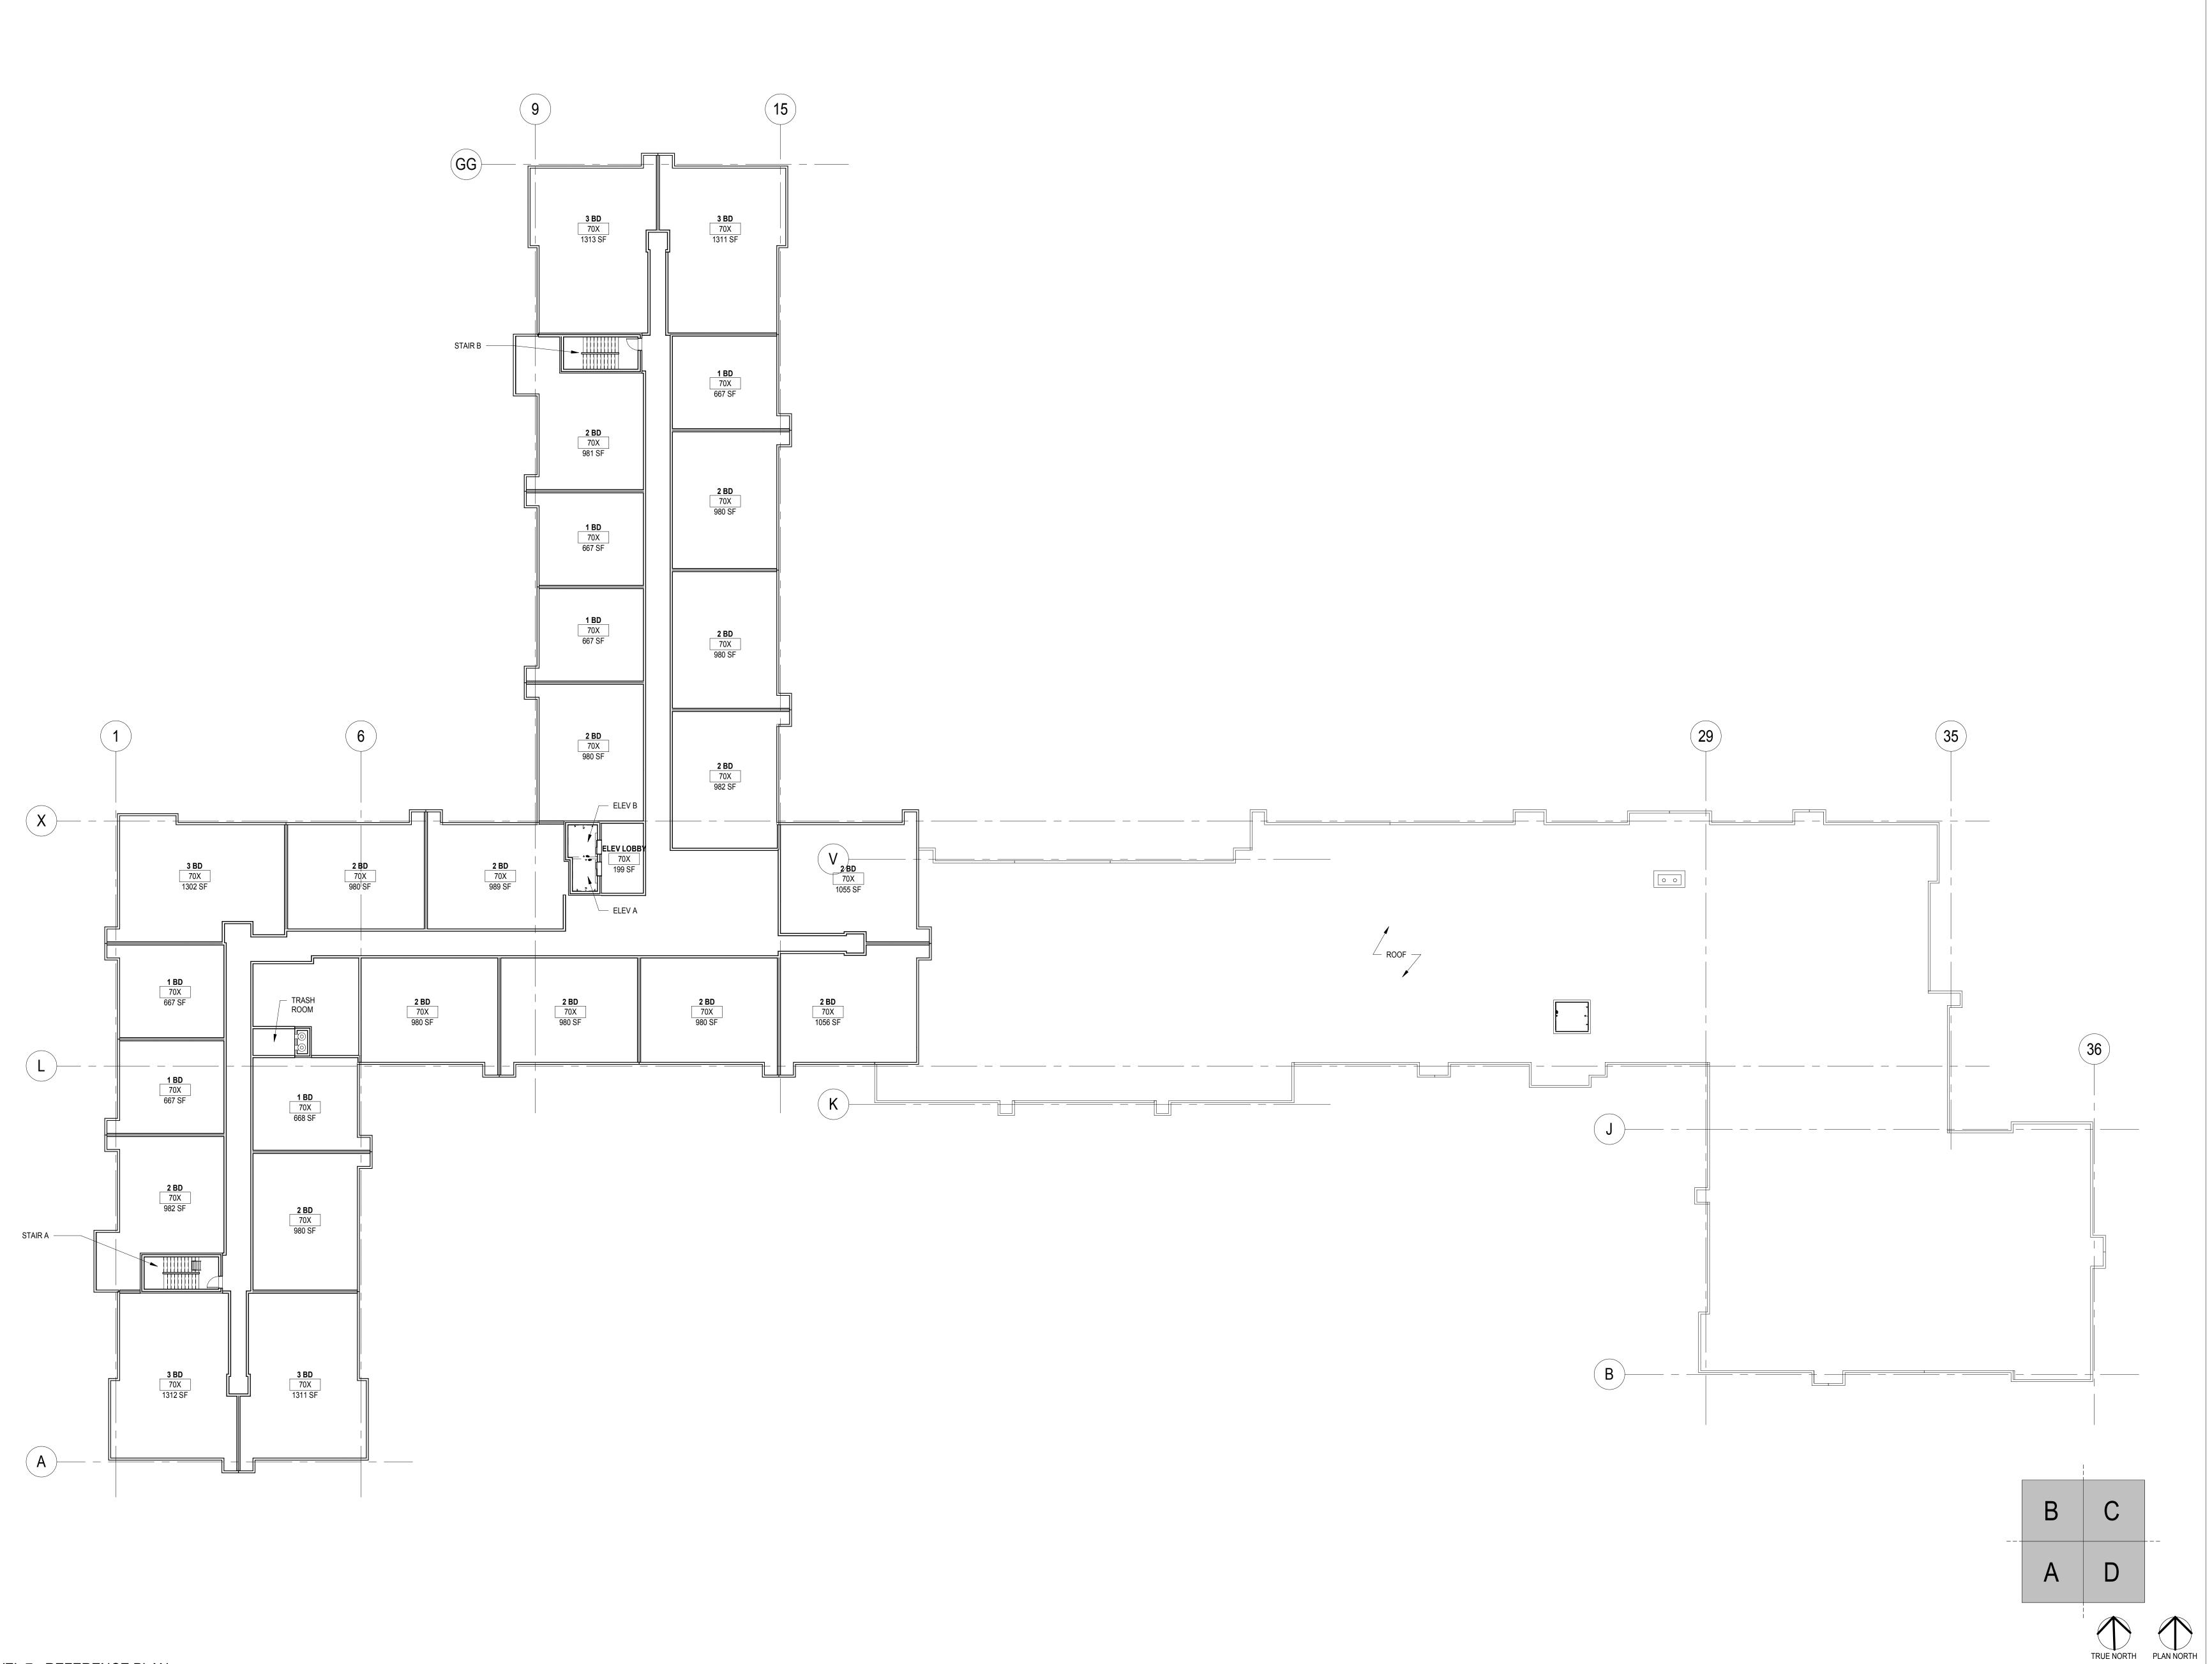

1 LEVEL 7 - REFERENCE PLAN

1 1/16" = 1'-0"

B V V
G R O U P
Architecture
Interior Design
Landscape Architecture
Engineering

Boarman Kroos Vogel Group Inc.

222 North Second Street Long & Kees Bldg, Suite 101 Minneapolis, MN 55401 Telephone: 612.339.3752 www.bkvgroup.com EOE

CONSULTANTS

PROJECT TITLE

BREN ROAD BUILDING C

ISSUE # DATE DESCRIPTION
04/06/2018 CITY SUBMITTAL

CERTIFICATION

CONSTRUCTION

DRAWN BY
CHECKED BY
COMMISSION NUMBER
Project Number
SHEET TITLE

LEVEL 7 OVERALL FLOOR PLAN

SHEET NUMBER

A107

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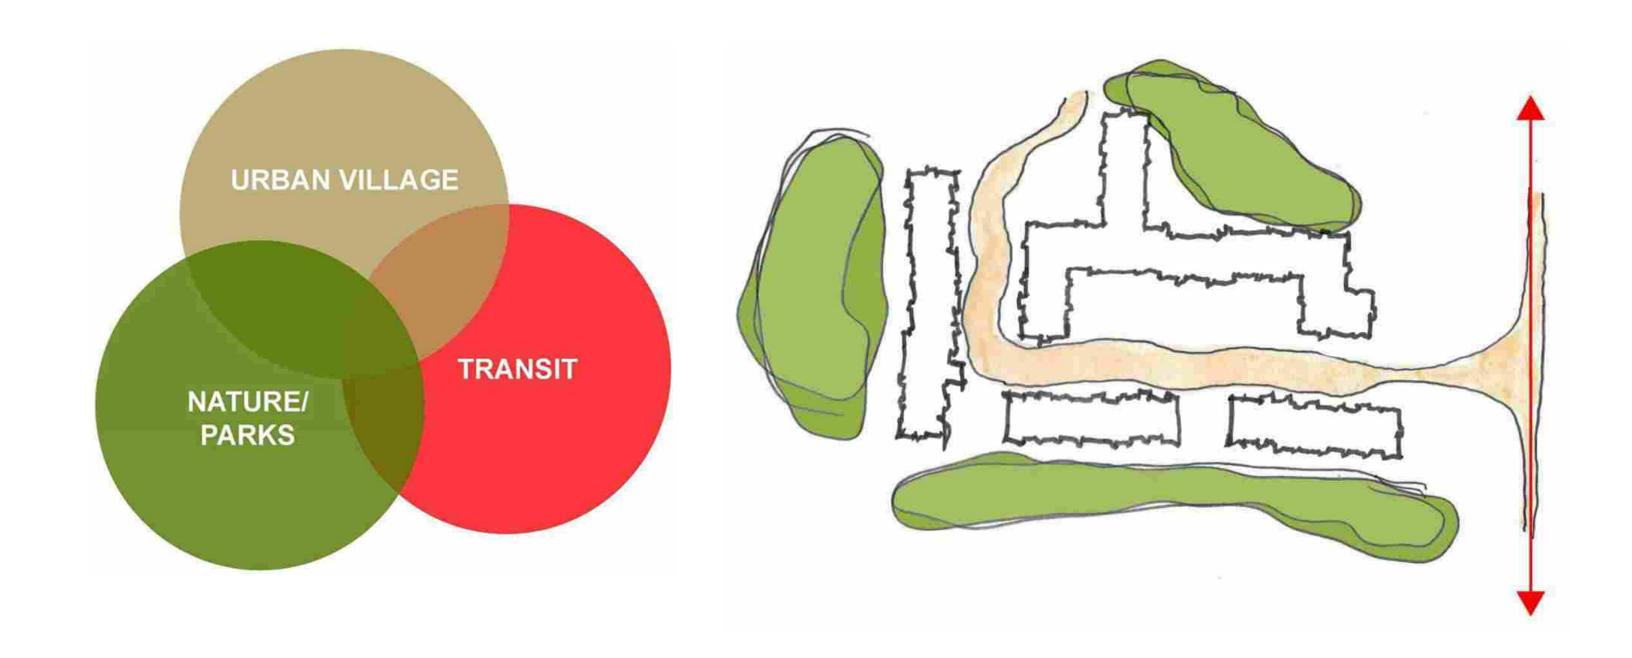























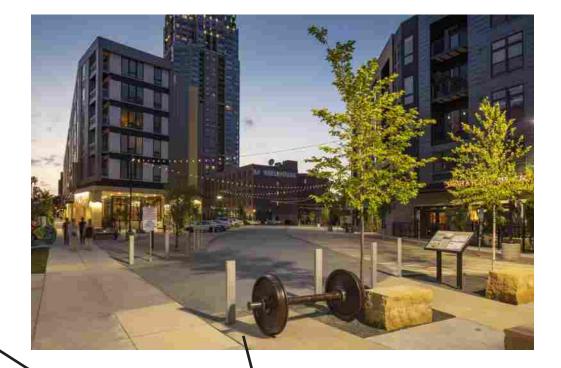






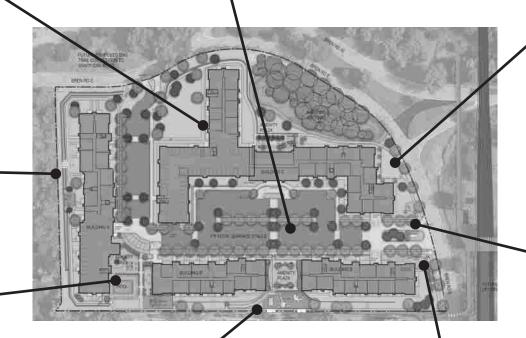

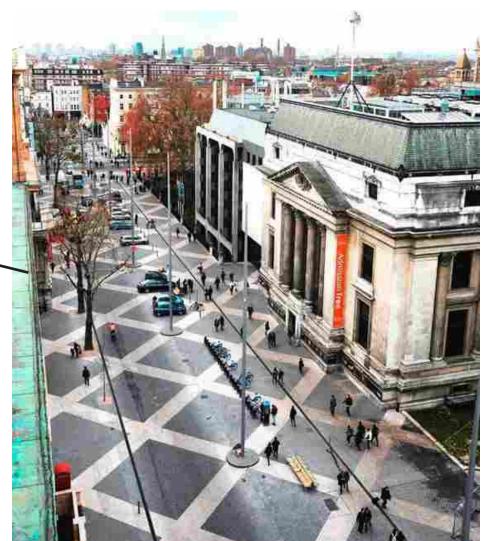

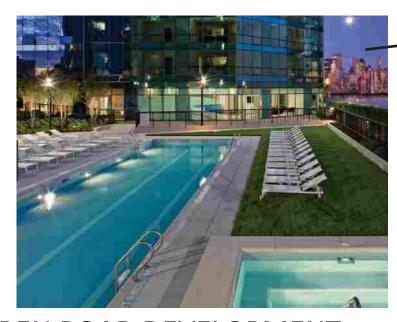





VISIONING IMAGES








































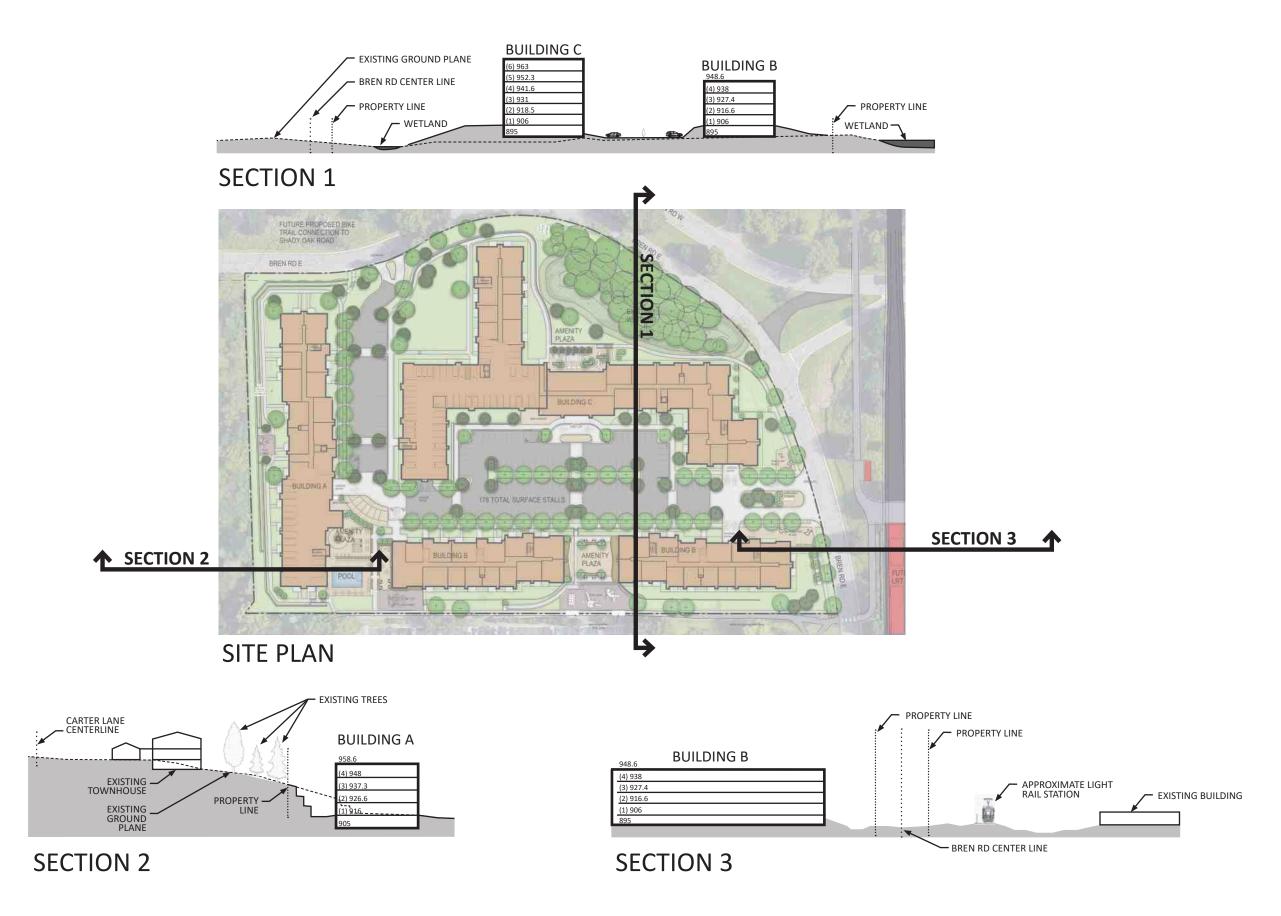



































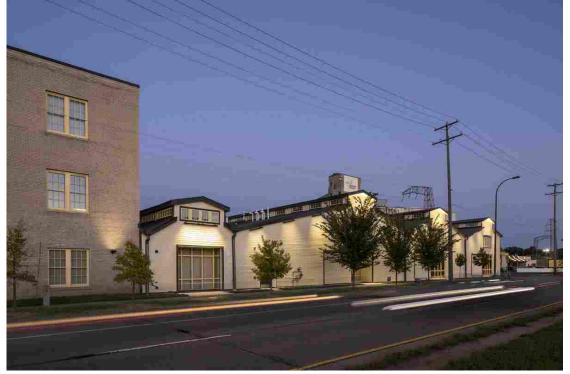





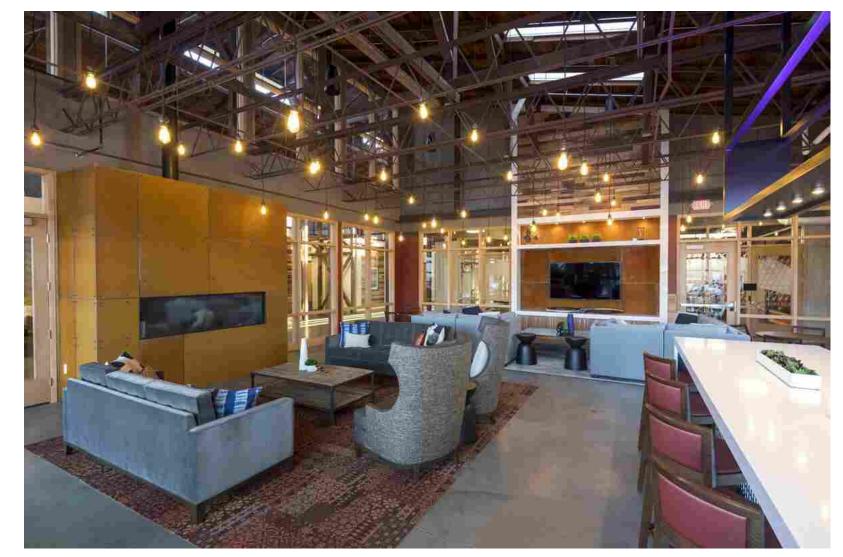















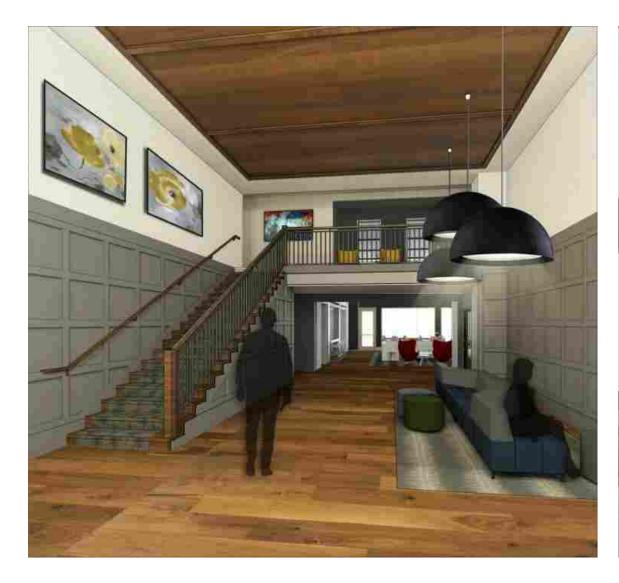

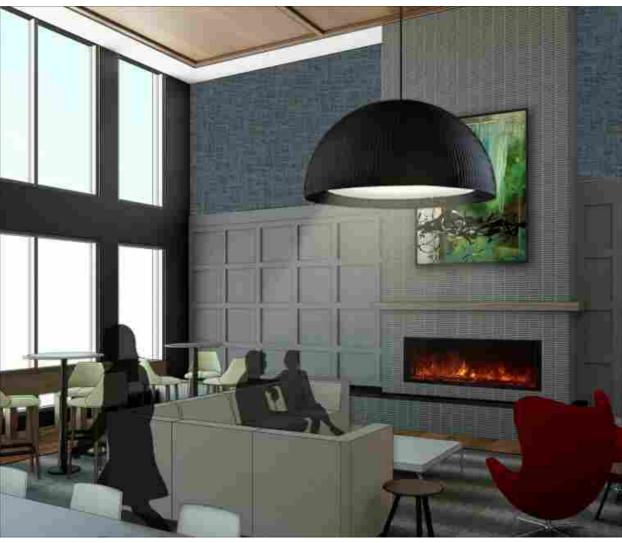







DESIGN EXAMPLES- EXTERIOR
GRAND CENTRAL FLATS- COLUMBIA HEIGHTS, MN


















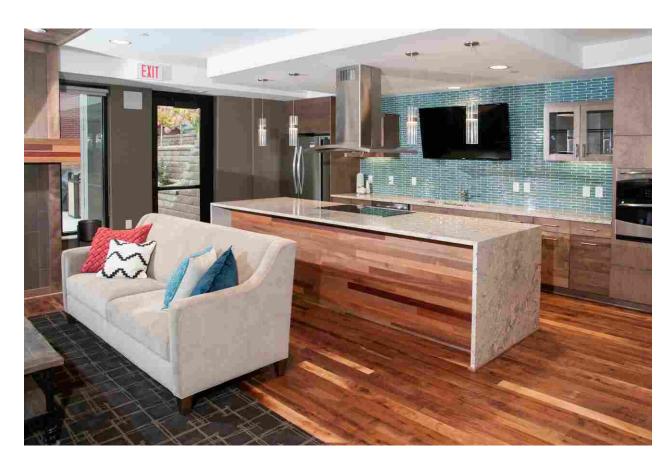













Parking Summary

After reviewing a number of comparable existing senior and general occupancy properties as well as new properties that are currently under construction we have come to the following conclusions. The table of this data is attached as Attachment 1.

1. The Bren Road Development project will provide considerably less parking than existing Dominium comparable properties.

For existing senior properties located in a mix of urban and suburban areas, the average total parking ratio is 1.18 parking stalls per unit. For existing general occupancy properties, the average total parking ratio is 1.85. Our proposed mix has a 1.01 ratio for the senior building and 1.25 for the general occupancy buildings which is considerably less than the existing properties.

2. The Bren Road Development project will provide less parking than pending Dominium new construction properties.


For senior new construction projects located in a mix of urban and suburban areas, the average parking ratio is 1.08 for seniors and 1.30 for general occupancy. It is important to note that two of the general occupancy properties are located in St. Paul in very urban areas where there are very limited parking options. Removing these St. Paul pending properties which are considerably more urban results in an average parking ratio of 1.13 for seniors and 1.62 for families.

On average, 83% of garage stalls are occupied in the existing general occupancy and senior properties. It is important to note that the effective occupancy of these properties is .77 stalls/unit (83% x .92 stalls/unit). Our project is proposing .75 stalls/unit of underground parking so the demand for parking based on this data, is greater than we have available. We are comfortable with this ratio because of the proximity to the future LRT stop and expected surrounding mixed-use redevelopment.

Conclusion: Overall, the parking mix we are proposing is significantly less than what we have historically provided. There will be some time between the construction completion of our project and the light rail and our future residents will not have any options if there is an insufficient amount of parking in the interim. If driverless cars and the light rail do indeed significantly reduce the parking demand in the future, BKV has come up with some plans that show where we can remove some of the existing surface parking and provide some additional green space. Attachment 2 shows the 10 and 30 year parking plans where some of the additional surface parking can be converted to green space.

Attachment 1

						ng Study					
					SUBJE	CT PROPERTY					
Property	Address	City	Units	Surface Spots	Garage Spots	Surface Parking Ratio	Garage Parking Ratio	Total Parking Ratio	Garage Type	# Occupied-Garage	% Occupied - Garage
Building C	11001 Bren Road E	Minnetonka	262	45	219	0.17	0.84	1.01	Underground	N/A	N/A
Buildings A & B	11001 Bren Road E	Minnetonka	220	133	141	0.60	0.64	1.25	Underground	N/A	N/A
	TOTALS		482	178	360	0.37	0.75	1.12			
					Senio	or Properties					
Property	Address	City	Units	Surface Spots	Garage Spots	Surface Parking Ratio	Garage Parking Ratio	Total Parking Ratio	Garage Type	# Occupied-Garage	% Occupied - Garage
The Legends at Silver Lake Village	2500 38th Ave NE	St. Anthony	169	60	128	0.36	0.76	1.11	Underground	109	85%
River North	10940 Crooked Lake Blvd. NW	Coon Rapids	167	57	116	0.34	0.69	1.04	Underground	112	97%
The Grainwood	5119 Gateway Street SE	Prior Lake	168	49	111	0.29	0.66	0.95	Underground	111	100%
The Cavanagh	5401 51st Ave North	Crystal	130	66	94	0.51	0.72	1.23	Underground	81	86%
The Cambric	720 East 7th St	St. Paul	113	120	86	1.06	0.76	1.82	Underground	<u>55</u>	64%
	TOTALS		149	67	109	0.45	0.73	1.18		97	89%
					General Occ	cupancy Properties					
Landings at Silver Lake Village	2551 38th Ave. NE	St. Anthony	263	231	215	0.88	0.82	1.70	Underground	161	75%
808 Berry	808 Berry Street	St. Paul	267	0	405	0.00	1.52	1.52	Underground	304	75%
Stone Creek	1020 West Medicine Lake Dr.	Plymouth	125	153	140	1.22	1.12	2.34	Underground	128	91%
Bluffs at Nine Mile Creek	7475 Flying Cloud Dr.	Eden Praire	188	118	241	N/A	1.28	1.91	Underground	196	81%
	TOTALS		211	121	270	0.57	1.28	1.85		209	78%
					General Occupa	ncy Under Construction					
Union Flats	787 Hampden Avenue	St. Paul	217	50	182	0.23	0.84	1.07	Underground	N/A	N/A
Grand Central Flats	4729 Grand Avenue NE	Columbia Heights	147	102	136	0.69	0.93	1.62	Underground	N/A	N/A
Millberry Apartments	778 Berry Street	St. Paul	121	42	95	0.35	0.79	1.13	Underground	N/A	N/A
	TOTALS		162	64	146	0.39	0.91	1.30			
					Senior Un	der Construction					
Legends of Columbia Heights	3700 Huset Parkway	Columbia Heights	191	88	136	0.46	0.71	1.17	Underground	N/A	N/A
Legends of Apple Valley	14050 Granite Ave	Apple Valley	163	42	143	0.26	0.88	1.13	Underground	N/A	N/A
Legends at Berry	700 Emerald Street	St. Paul	240	42	175	0.18	0.73	0.90	Underground	N/A	N/A
Legends of Champlin	11635 Theatre Drive	Champlin	184	73	138	0.40	0.75	1.15	Underground	N/A	N/A
Legends of Cottage Grove	6999 E Point Douglas Rd S	Cottage Grove	184	65	129	0.35	0.70	1.05	Underground	N/A	N/A
	TOTALS		192	61	146	0.32	0.76	1.08			
TOTALS - All Property Types			179	78	168	0.43	0.92	1.35		153	83%

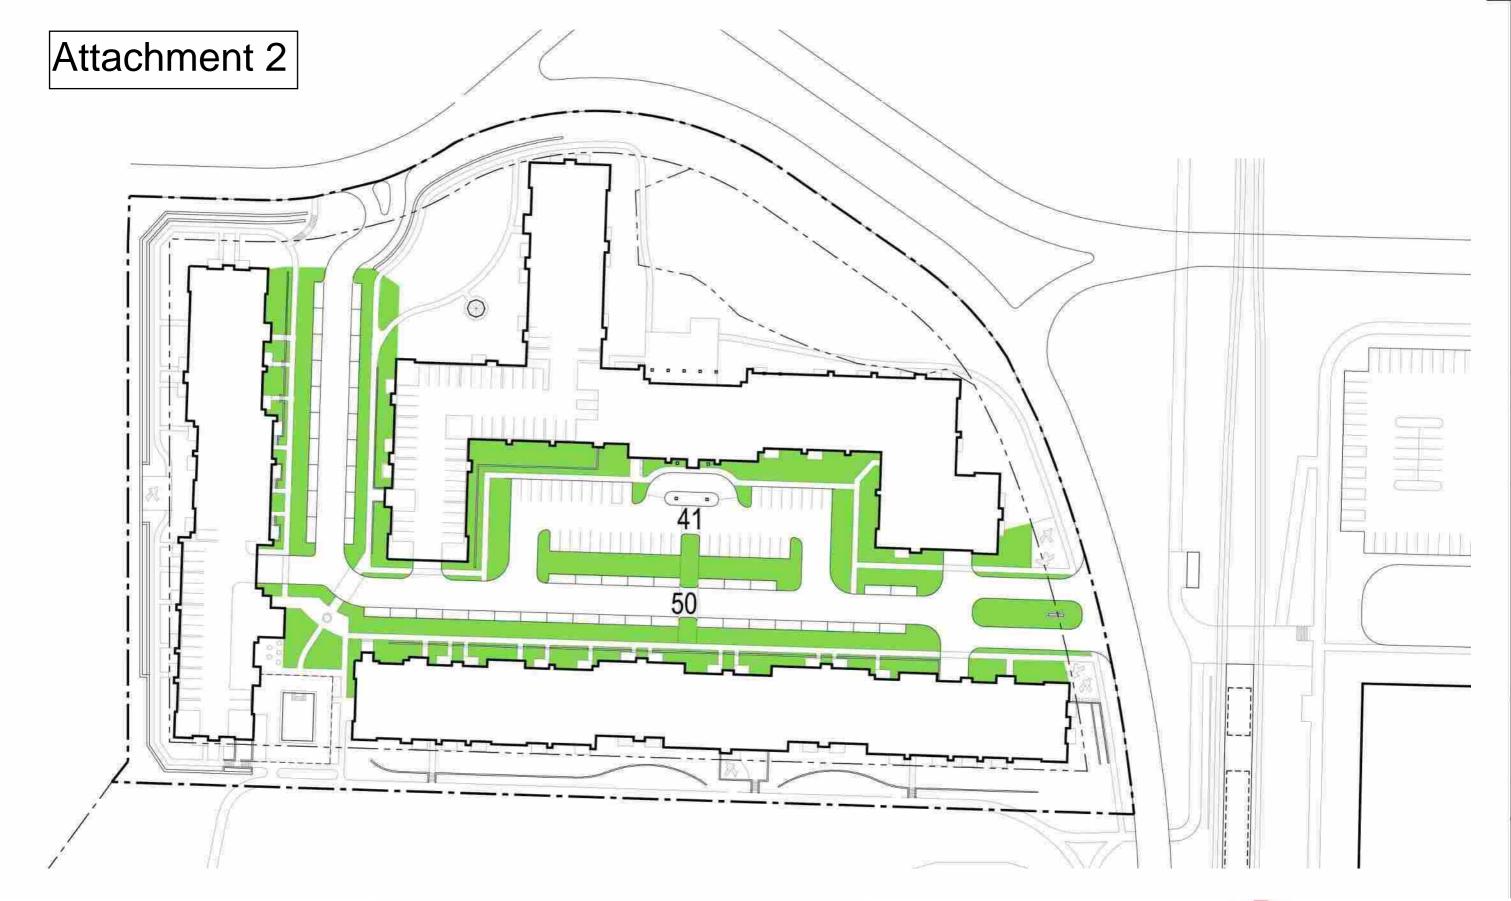


BREN ROAD DEVELOPMENT - 10 YEAR PARKING DEMAND PLAN

SCALE: 1"=80'-0" DATE: 2-28-18







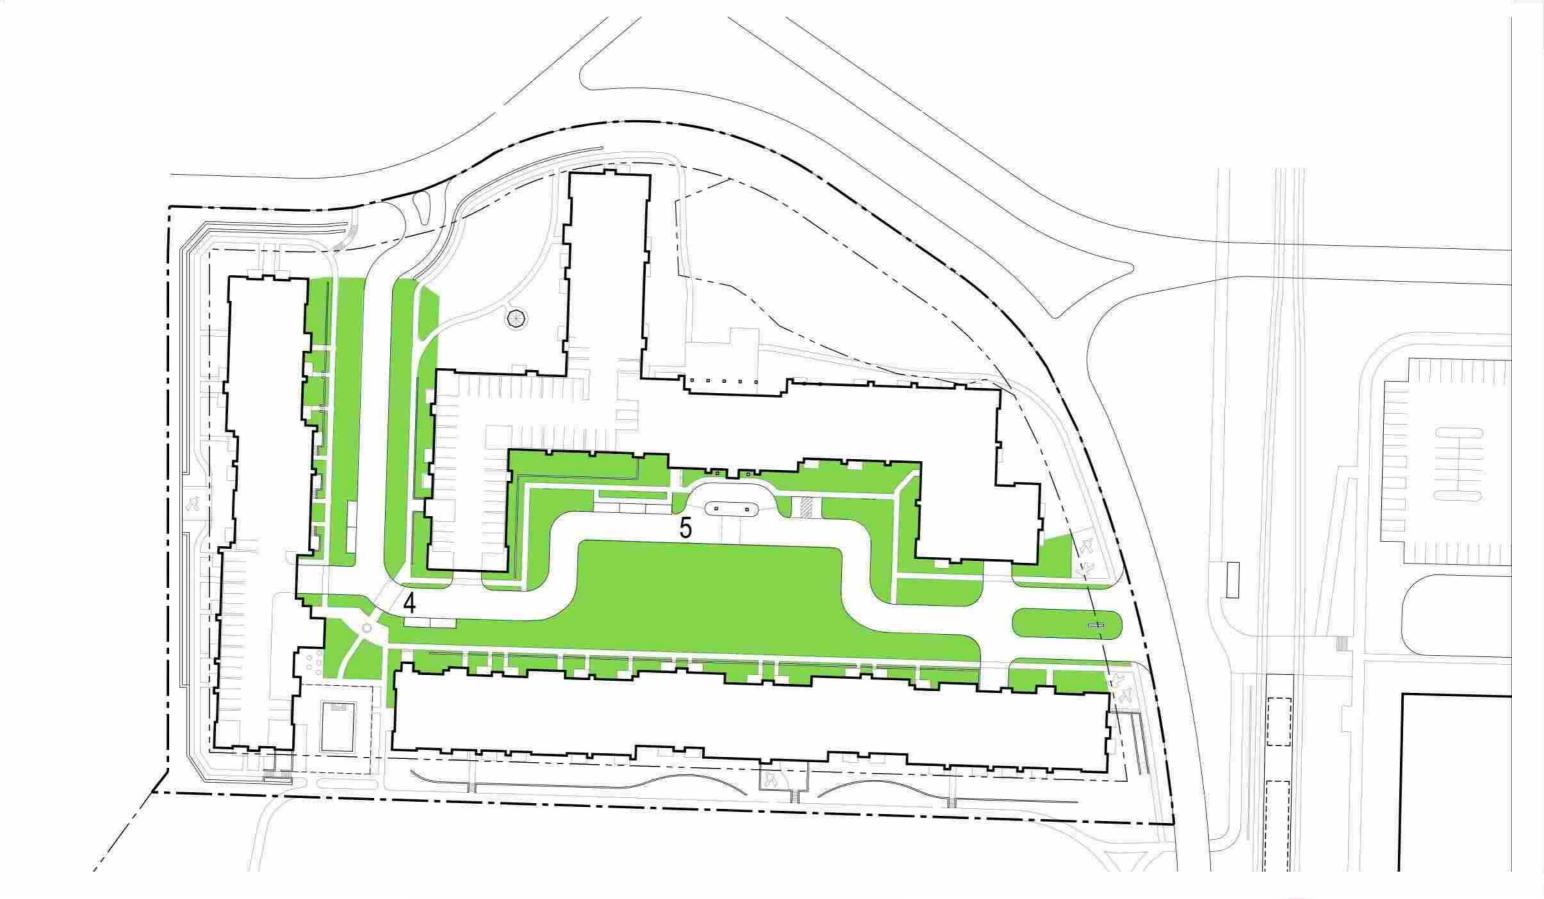

BREN ROAD DEVELOPMENT - 30 YEAR PARKING DEMAND PLAN

SCALE: 1"=80'-0" DATE: 2-28-18










Innovation Summary

Dominium is committed to providing many innovative features on the Bren Road Development project including an enhanced trail system, a green parkway entrance, public art plazas, and a bike café. In addition, this project will feature a state-of-the-art rooftop solar energy system.

Solar Energy System:

The proposed rooftop solar energy system will include over 1,500 Jinko 325-watt panels spread over all three buildings and is capable of producing more than 562,120 kWh per year. The system will be installed by Cedar Creek Energy, who have installed similar systems on past Dominium projects.

It is estimated that the system will be able to cover roughly 20% of the project's total electricity cost (including tenant unit electricity use), which results in annual power savings of over \$50,000. After accounting for the tax benefits and utility credits the project will be eligible for, the payback time is estimated to be less than seven years.

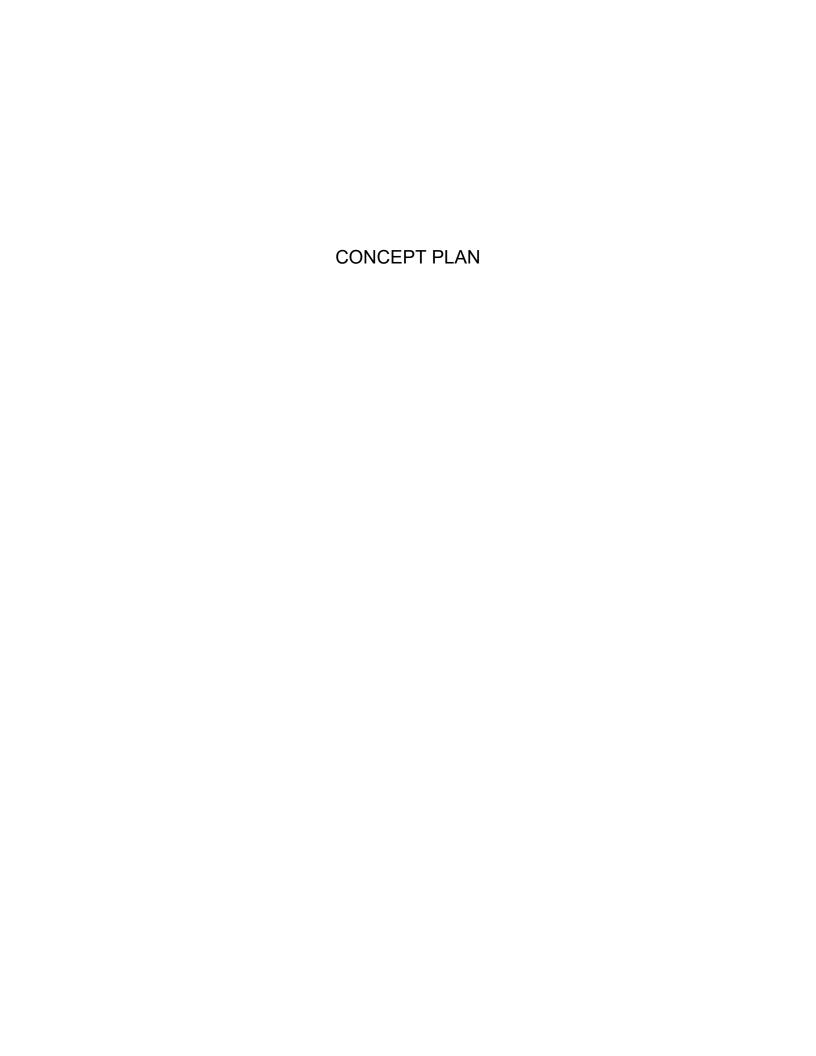





















C. Items relating to Dominium at 11001 Bren Road East

1) Concept plan review for Dominium at 11001 Bren Road East

Gordon gave the staff report.

Wagner said there was a wonderful opportunity to tackle affordable housing and workforce housing. There were 1,050 units being proposed. On top of that there were a number of institutional uses that now were schools in the Opus area. What the area did not have was anything other than trails. There were a lot of units and no park land. He suggested staff put together some information for a study session. He said historically the city had a mixture of affordability and market rate units. Although he understood the reason related to how things were currently being financed, he thought this plan with three buildings in close proximity, was a major shift, one he was OK with. He thought there was a missed opportunity in creating a sense of place, a theme with what the council wanted the area to be. He didn't think the plan felt like what the Shady Oak station area could be. He said the EDAC did a fabulous job analyzing the plan financially. He thought there were bigger picture issues for the Opus area.

Wiersum said he supported the plan. The opportunity to get this level of affordable housing in one proposal was not something the council was used to talking about. At the same time the council did not want to get into a situation where the city was only putting in affordable housing in certain areas and not others. He liked the idea of getting some park opportunities even if they were just pocket parks. He questioned if there was an opportunity to also get greater connectivity to Lone Lake Park.

Acomb was thrilled to see the affordability coming from a company that knows that market very well. She had reservations about the size of the buildings in one area. That said, the community needs affordable housing. She really liked the senior affordable units. The map in the council packet showed there really wasn't anything connecting this area and the light rail station over to Shady Oak Road. As the area develops it was important to keep in mind the need for getting people from the light rail station to where services are. She wondered if there were opportunities to get mixed use developments that would add retail to the area.

Bergstedt said the plan looked great and the mix of affordable senior and affordable workforce housing was something the city really needed. He thought it would help if there was a way to connect to Lone Lake Park or add pocket parks.

Allendorf said it was a wonderful project.

Ellingson said one of the wonderful things about the Opus area was the trail system. He said this was the kind of development the city wanted near the light rail station.

Schneider said conceptually the city couldn't ask for a better neighbor to the light rail station. He agreed with Wagner that the Opus area with all its housing would benefit from a master planned corridor approach toward open space with connecting ponds and amenities similar to the Centennial Lakes area in Edina. The challenge was distance-wise this was much greater than the Southdale area. The question was how to link it all together. He suggested staff look at where there were some natural areas that should be preserved and also look at the area all the way down to Crosstown and ways to link the entire area together through the developments. This was worth hiring a consultant to look at. It would add tremendous value to the developments.

Barone noted that a park planner position was being created for 2018.

Allendorf noted that many years ago Gerry Rauenhorst developed the Opus area with the one way road system. The paths were included to get connectivity from one area to another. Rauenhorst's vision was to use golf carts. The idea was to separate pedestrian traffic from automobile traffic. Wischnack said staff had discussed options with the developer to allow pedestrians to get around off of the roadway.

Acomb said the information about the financing indicated a possibility of deferring the park dedication fees from the project. She asked for more information. Wischnack said a deferment was not a waiver of the fees. If the project was built in phases, portions of the fee might be deferred over a period of time. Other options were being discussed with the developer.

Wagner said as far as the design the concept looked a little too boxy and might not stand the test of time.

Wiersum said the TIF seemed reasonable but noted there still would be an \$880,000 million gap. He asked if the developer could speak on his plan to cover the gap and if the project would proceed if the gap remains when the financing is determined.

Ryan Lunderby from Dominium said the project would still be a go. This was an \$115 million project so the amount of the gap would not stop it. He said city funds would be used last and the company would search to find other resources potentially from the county or the Metropolitan Council. He

added the project would also go forward whether or not light rail happened. The need for this type of housing was that great.

Schneider said the concept plan showed a play lot in one of the corners of the property. One design improvement would be to figure out a way to reconfigure the building to provide for a more prominent and centrally located open space for the residents to enjoy. This would help make the building look less boxy and institutional.

D. Resolution approving the second amendment to the regulatory agreement for Minnetonka Heights

Wagner moved, Acomb seconded a motion to adopt resolution 2017-134 approving the Second Amendment to the Regulatory Agreement between the City of Minnetonka and Heartland Heights, LLC. All voted "yes." Motion carried.

F. Process for filing the council vacancy to occur in Ward 3

Wagner noted there was a single person left in the audience who was at the meeting for item 13F. He suggested moving the item before item 13E on the agenda.

Barone and Heine gave the staff report.

Schneider said he had indicated at the study session discussion that he felt the community would better be served by an appointment process but only using an enhanced version that allowed for more public input. He suggested adding a few steps to the appointment process outlined in the staff report. One would be for staff to mail out a self-return postcard to each household in Ward 3 with a list of the applicants and a link to the live broadcast interview session. Residents would rank their preferences on the postcard and mail it back to the city. Staff would provide the council with a summary. The council would use this information to conduct the interviews and rank their choices. This was similar to a process used to hire past city managers. Using this process would likely mean more public engagement than a special election held in April.

Bergstedt said at the study session the council discussed the options and Allendorf, Schneider and himself preferred an appointment process. The reasons he preferred appointing someone to fill the vacancy was because of the April election date, that it was for a ward seat, and there would be no primary no matter how many people ran. Because of this, the winner could win with a small number of votes. His other concern was if the appointment process was used, someone could fill the seat February 12. If a special election was called the winner would be seated April 23. This





Parcels
----- City Boundary



NOTIFICATION AREA

Ordinance No. 2018-

An ordinance master development plans and final site and building plans for redevelopment of the property located at 12501 Ridgedale Drive							
The City of M	finnetonka Ordains:						
Section 1.	Background						
1.01	This ordinance hereby the master development plans and final site and building plans for construction of a residential apartment development at 12501 Ridgedale Drive.						
1.02	The property is located at 12501 Ridgedale Drive and are legally described as:						
	Lot 3, Block 1, Ridgedale Center Fifth Addition, Hennepin County, Minnetonka						
Section 2.	Findings						
2.01	This ordinance is based on the following findings:						
Section 3.	This ordinance is effective immediately.						
Adopted by t	he city council of the City of Minnetonka, Minnesota, on, 2018.						
Brad Wiersur	m, Mayor						
ATTEST:							
David E. Mae	eda, City Clerk						

Ordinance No. 2018-	Page 2
Action on this ordinance:	
Date of introduction: Date of adoption: Motion for adoption: Seconded by: Voted in favor of: Voted against: Abstained: Absent: Ordinance adopted.	
Date of publication:	
I certify that the foregoing is a true and correct copy of an ordinance adopted by the of the City of Minnetonka, Minnesota at a regular meeting held on,	

David E. Maeda, City Clerk